South Padre Island Pedestrian Walkover Southe

AT:

White Cap Circle Beach Public Access South Padre Island, Texas

OWNER:

City of South Padre Island 4601 Padre Blvd South Padre Island, Texas

PROJECT & STRUCTURAL ENGINEER: **GREEN, RUBIANO & ASSOCIATES**

1220 WEST HARRISON

HARLINGEN, TEXAS 78550

P: 956-428-4461

GRA@GRAENGINEERING.COM

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G0.0 COVER SHEET

GLO INFORMATION SHEET INDEX:

GLO-A1 VOLUME AND LOCATION OF DUNE CUT (MITIGATION)

GLO-A2 VOLUME AND LOCATION OF DUNE FILL (MITIGATION)


GLO-B1 AREAS OF VEGETATION IMPACT

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CIVIL ENGINEER: HALFF

1075 PAREDES LINE ROAD SUITE B BROWNSVILLE, TEXAS 78526 P: 956-303-7100

CIVIL SHEET INDEX:

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- C1.2 GENERAL NOTES AND LEGEND
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LANDSCAPE: SSP DESIGN LLC

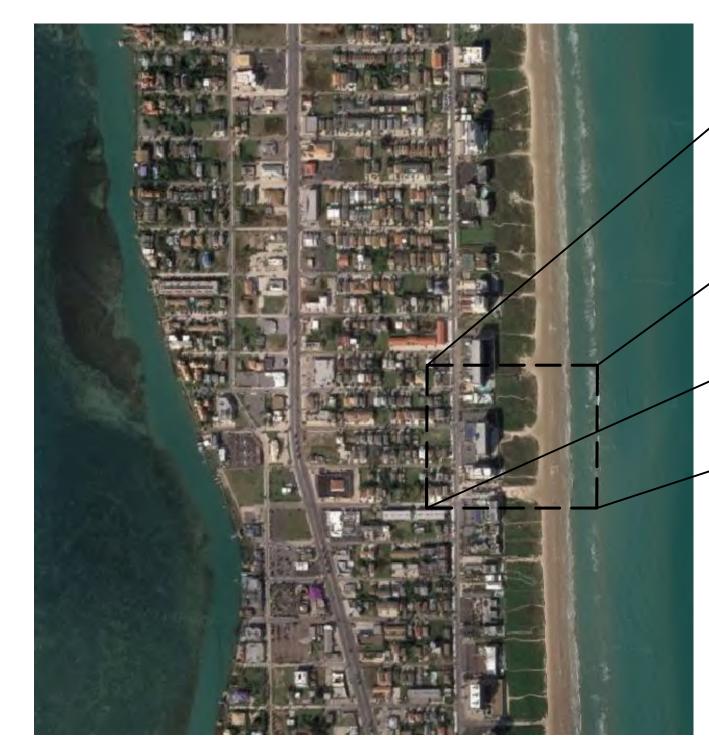789 E. WASHINGTON ST. BROWNSVILLE, TEXAS 78520 P: 956-547-9977 F: 956-547-9977

LANDSCAPE SHEET INDEX:

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ELECTRICAL PLUMBING ENGINEER: ETHOS ENGINEERING

1126 SOUTH COMMERCE ST, HARLINGEN, TEXAS 78550 P: 956-230-3435

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EP1.01 EP SITE PLAN

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CONSULTING STRUCTURAL ENGINEE



WHITE CAP CIRCLE

WALKOVER AT WHITE CAP CIRCLE

SOUTH PADRE ISLAND, **TEXAS**

CITY OF SOUTH PADRE ISLAND



SOUTH PADRE ISLAND. **TEXAS**

> P: 956-761-3044 F: 956-761-3898




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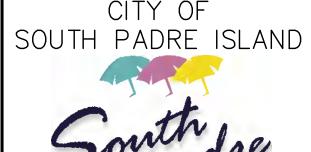
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AT WHITECAP CIRCLE



F: 956-761-3898


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DATE	04-22-2022
PROJECT NO.	1065–16

LOCATION OF **DUNE CUT** (MITIGATION)

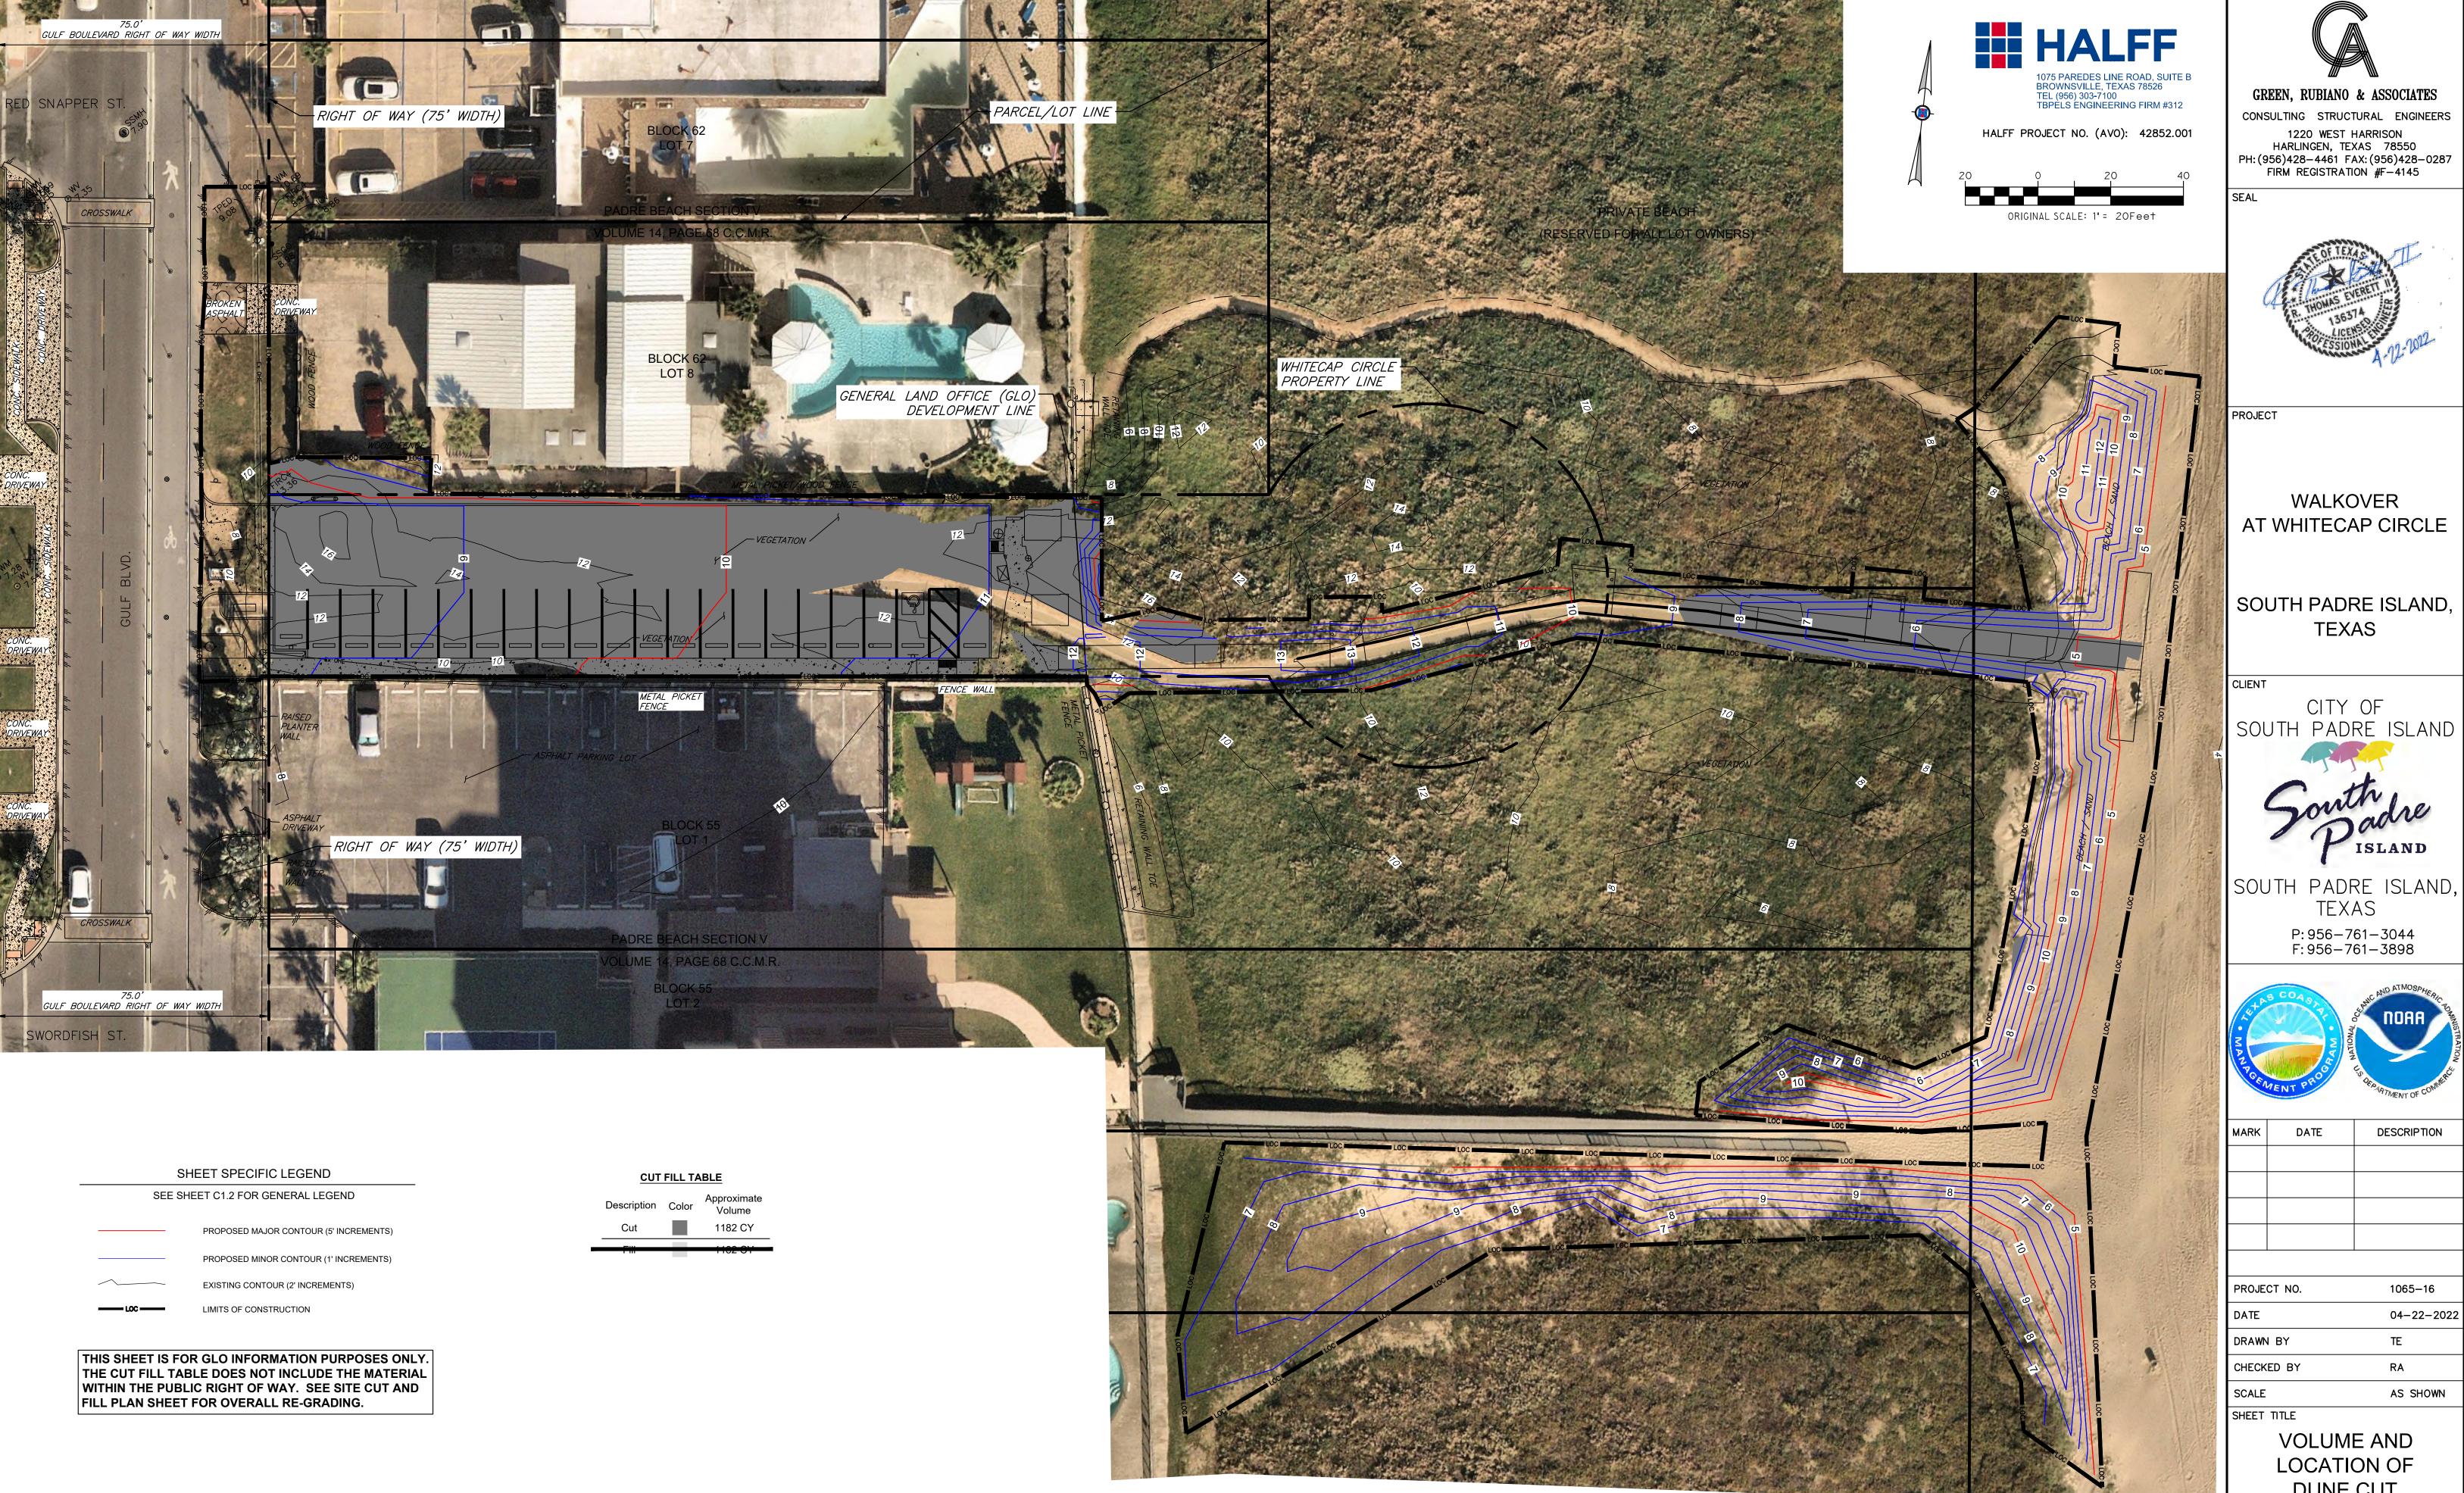SHEET NO.

GLO-A1



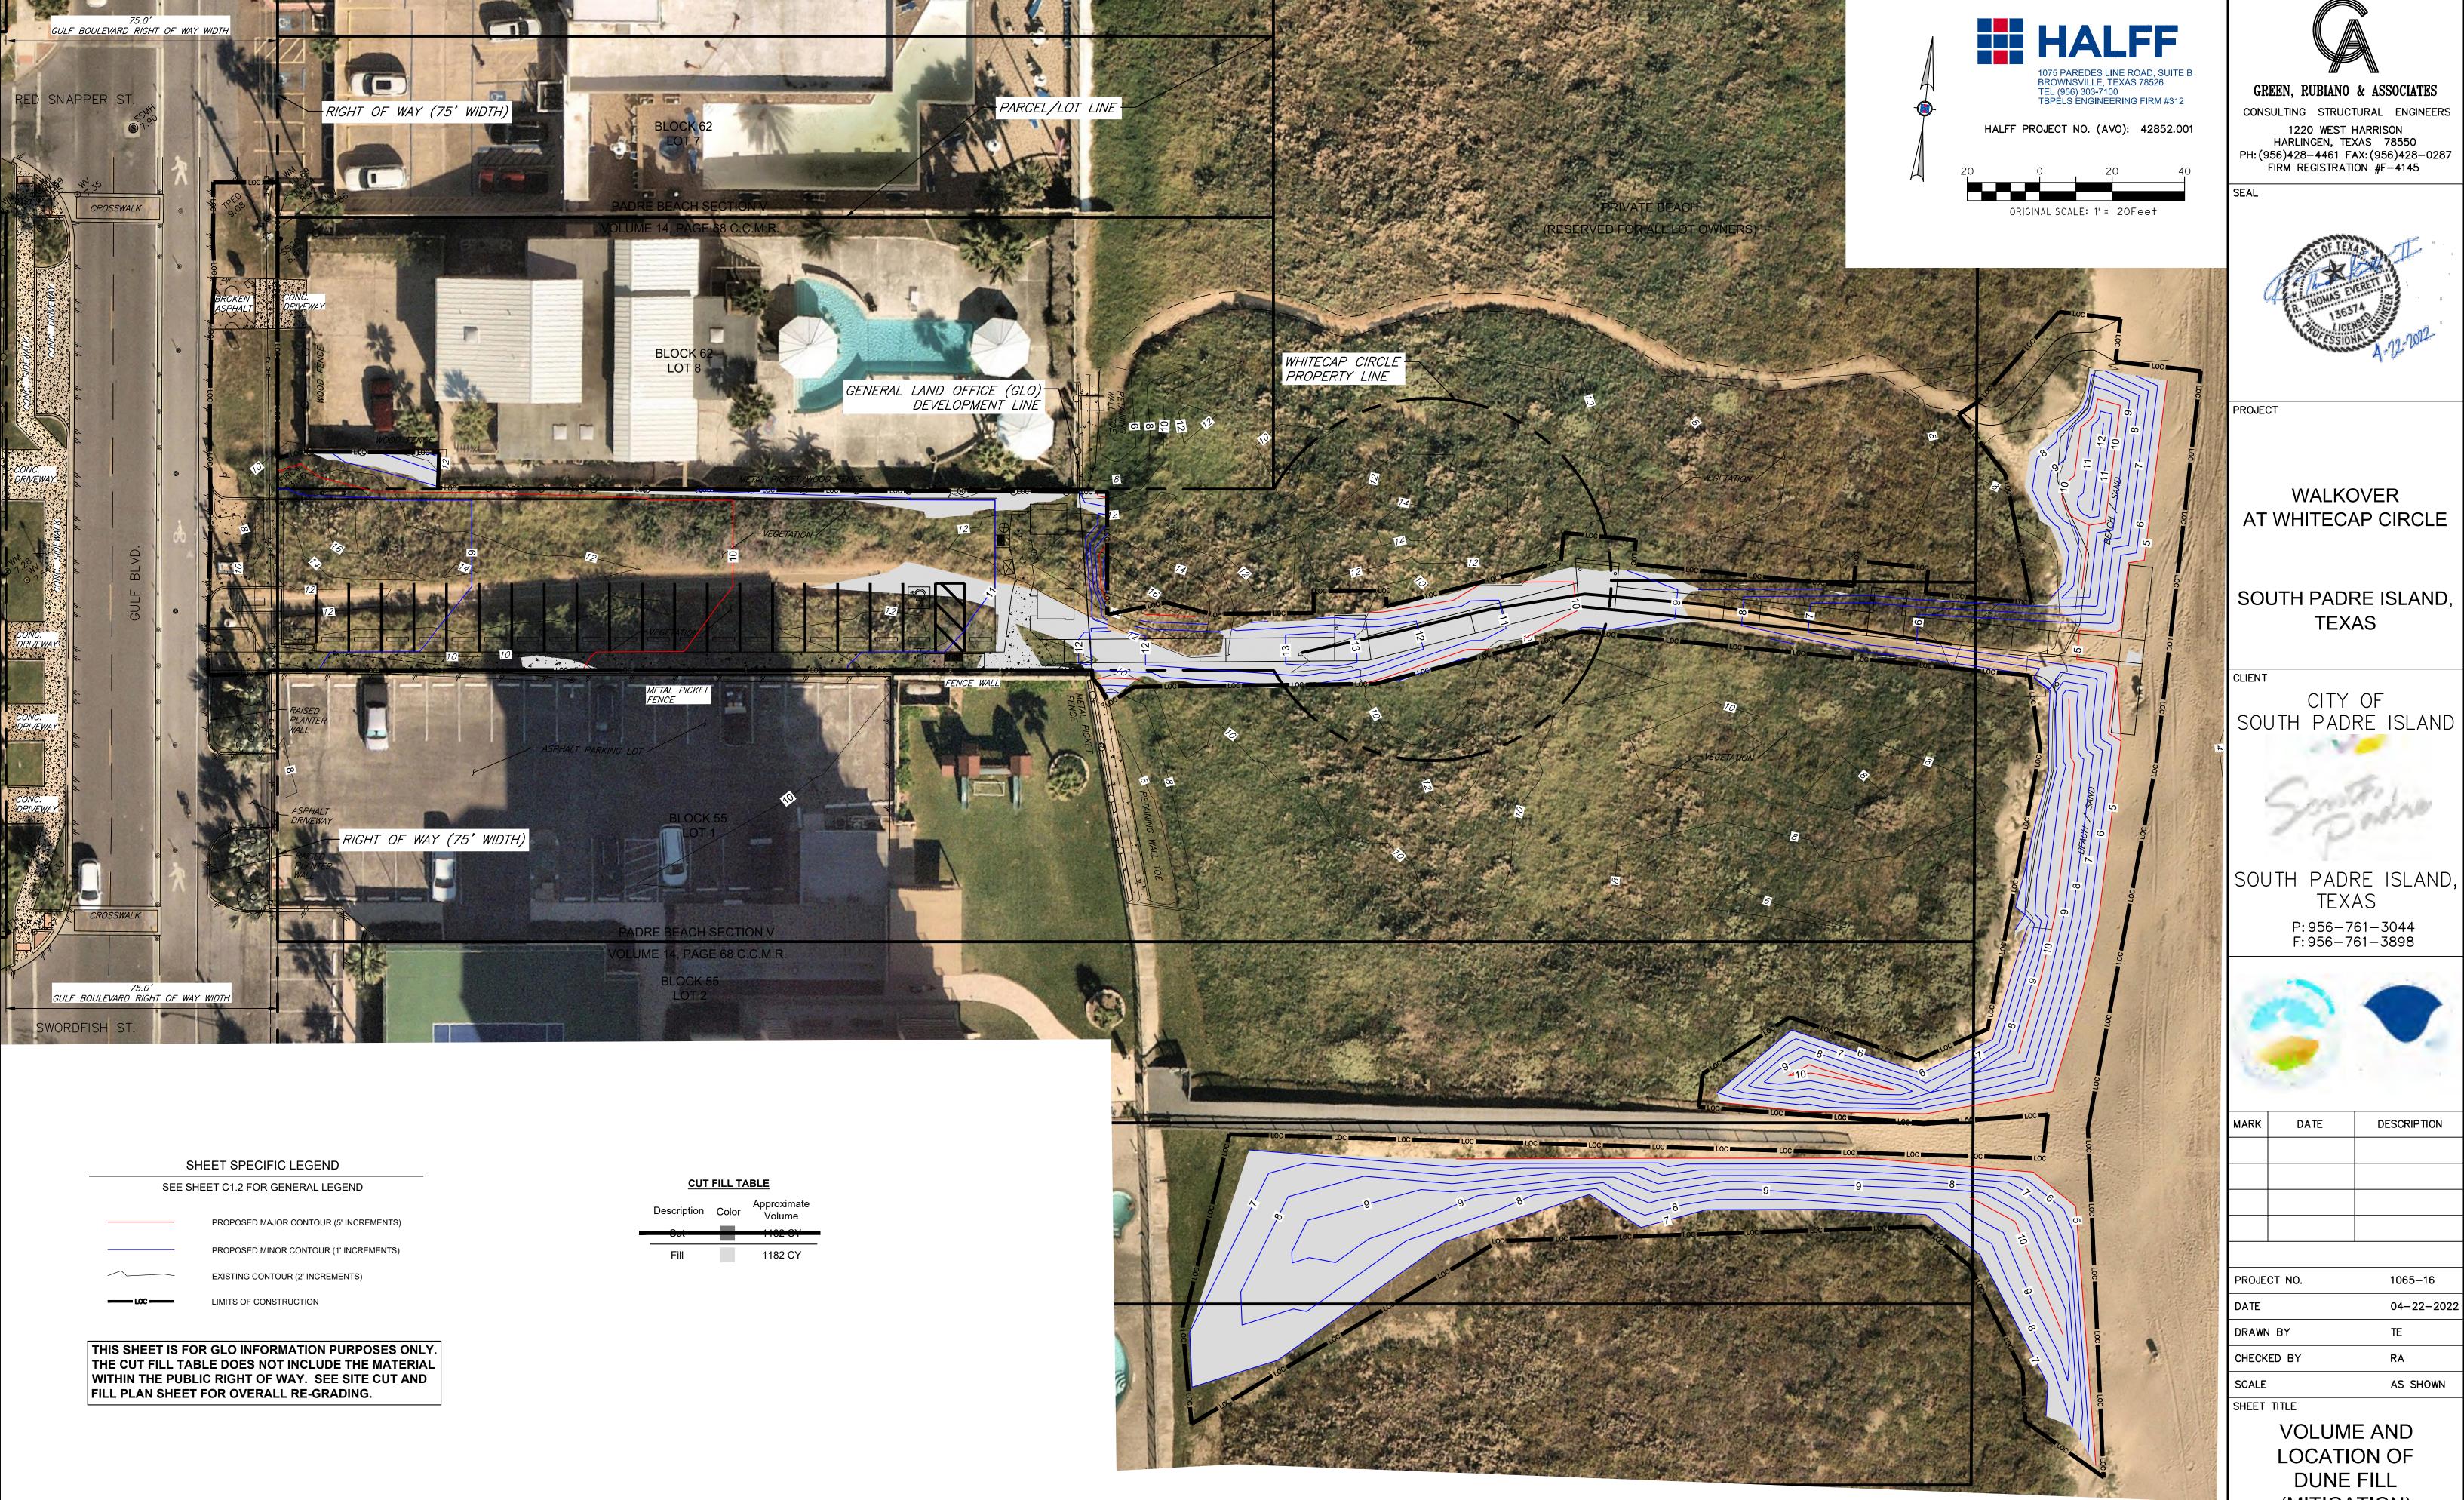





(MITIGATION)

SHEET NO.

GLO-A2

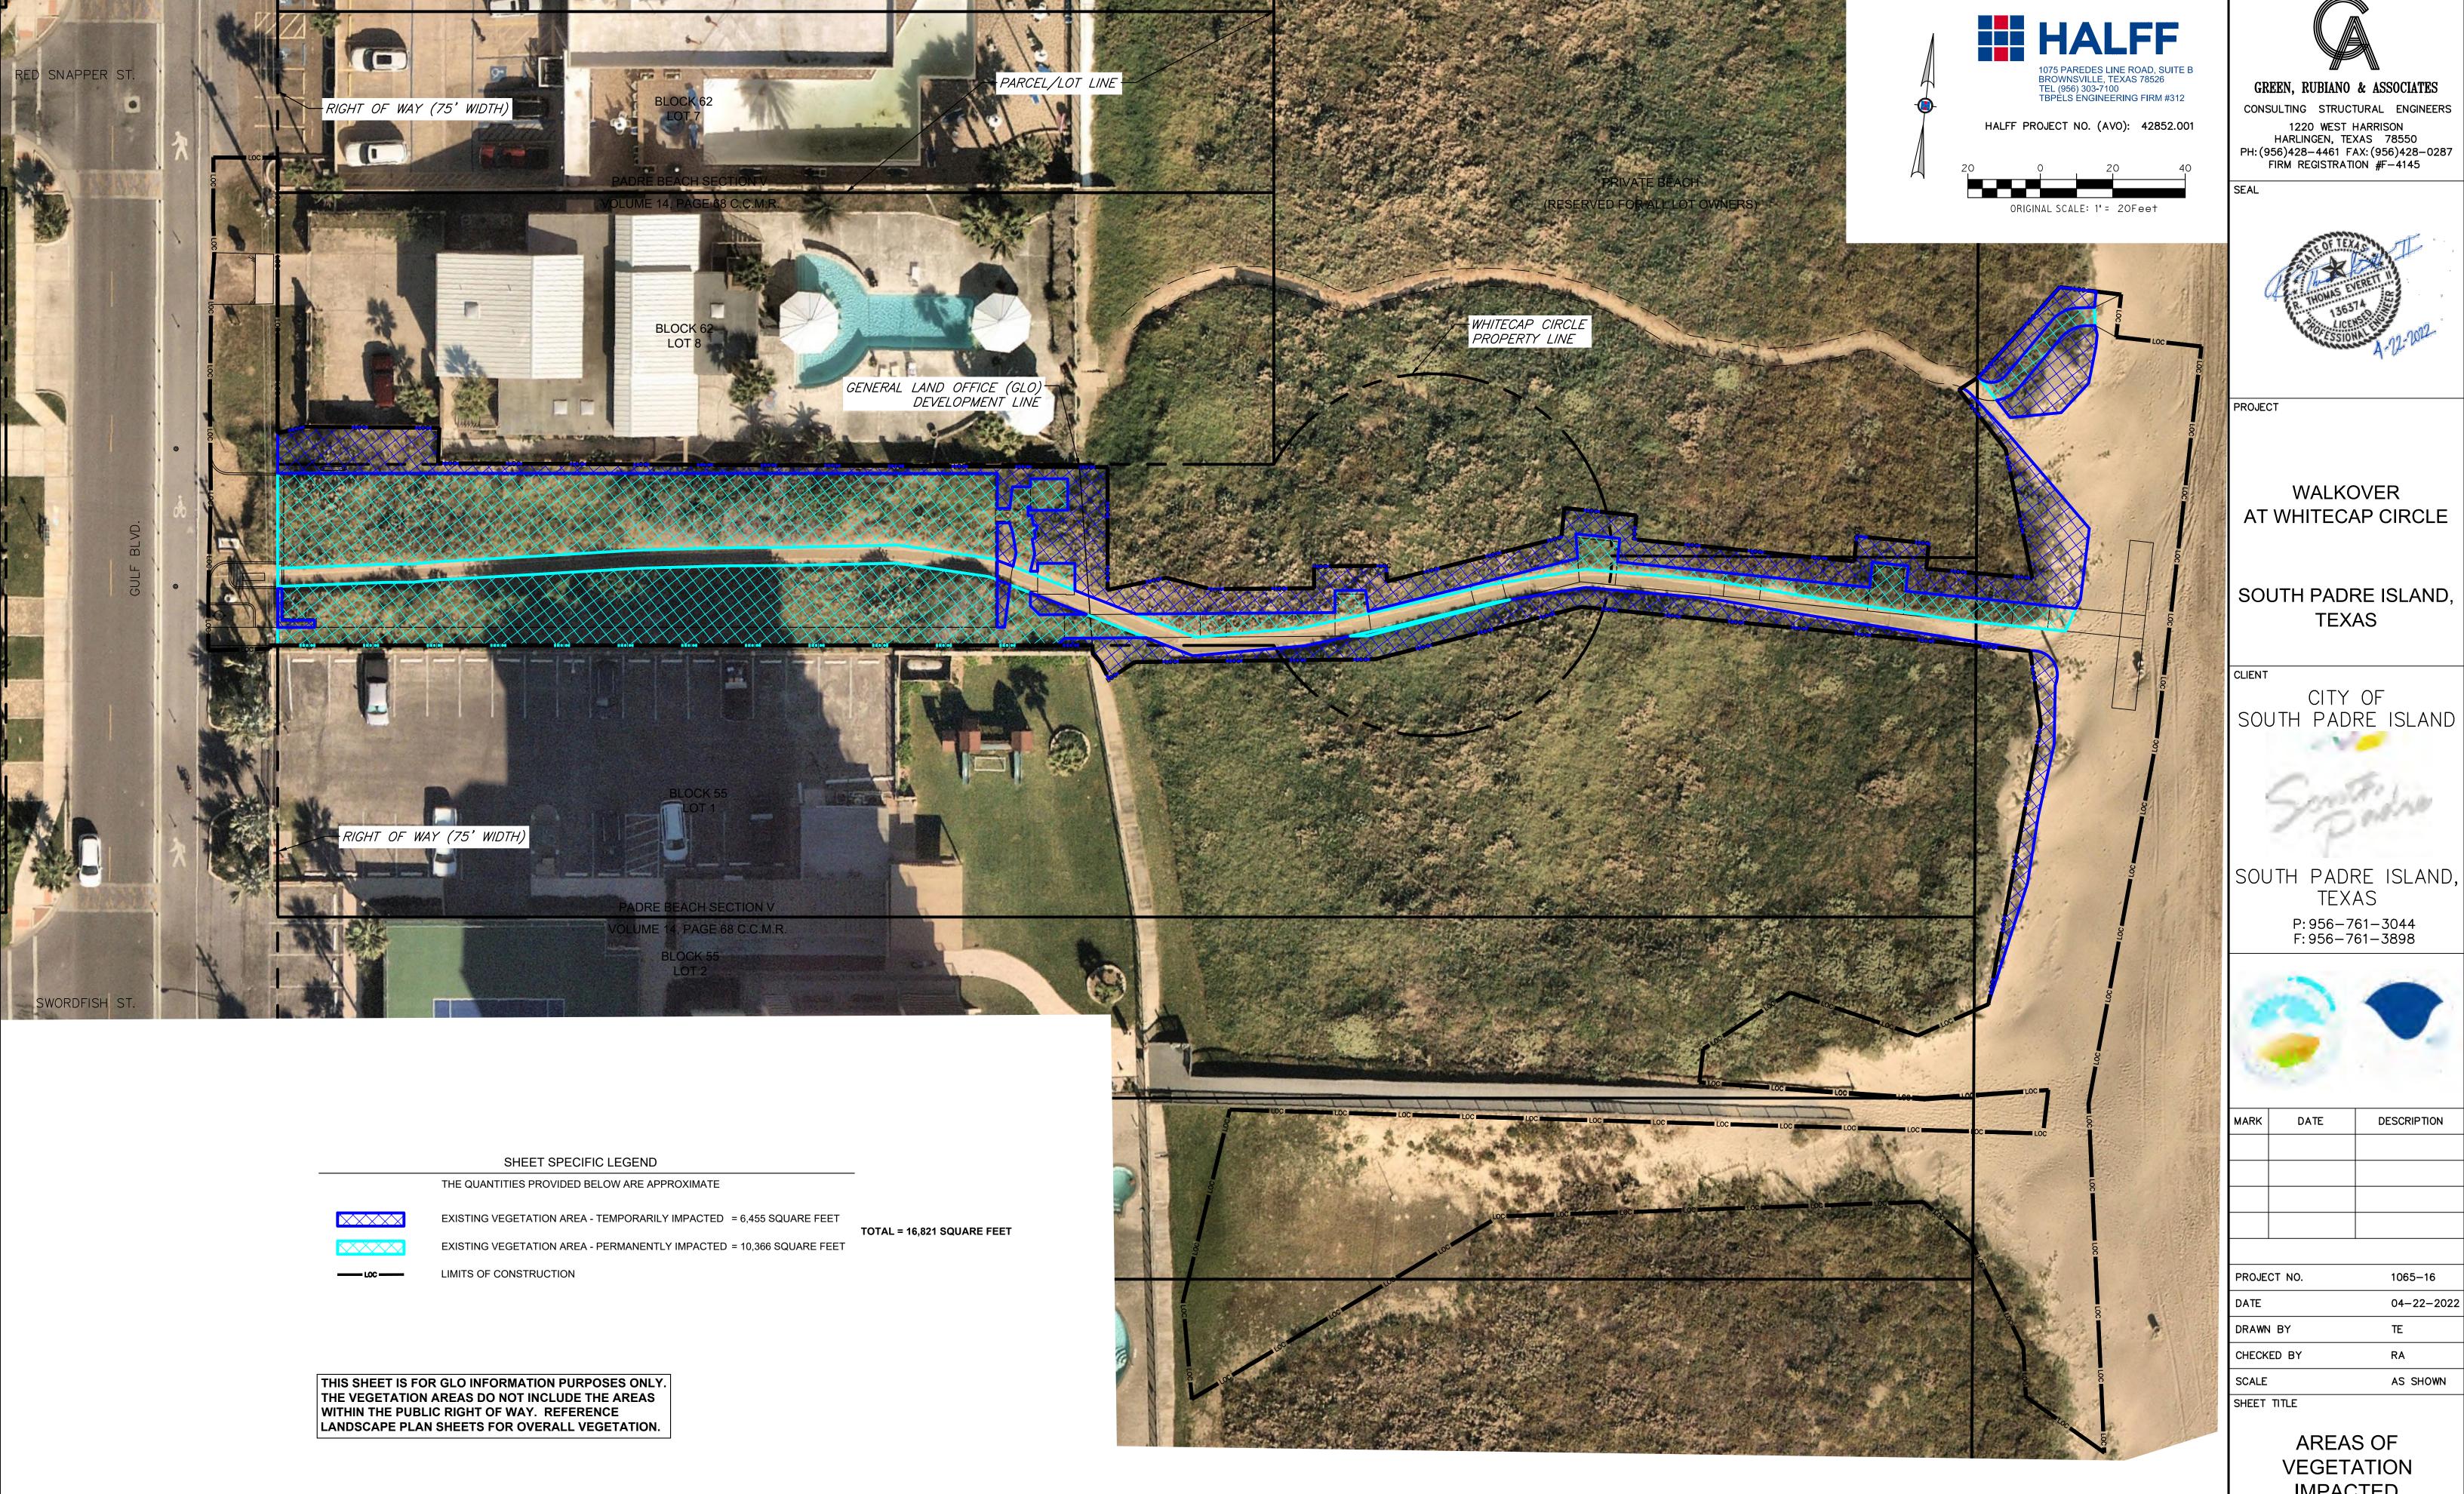



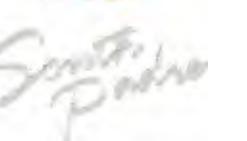


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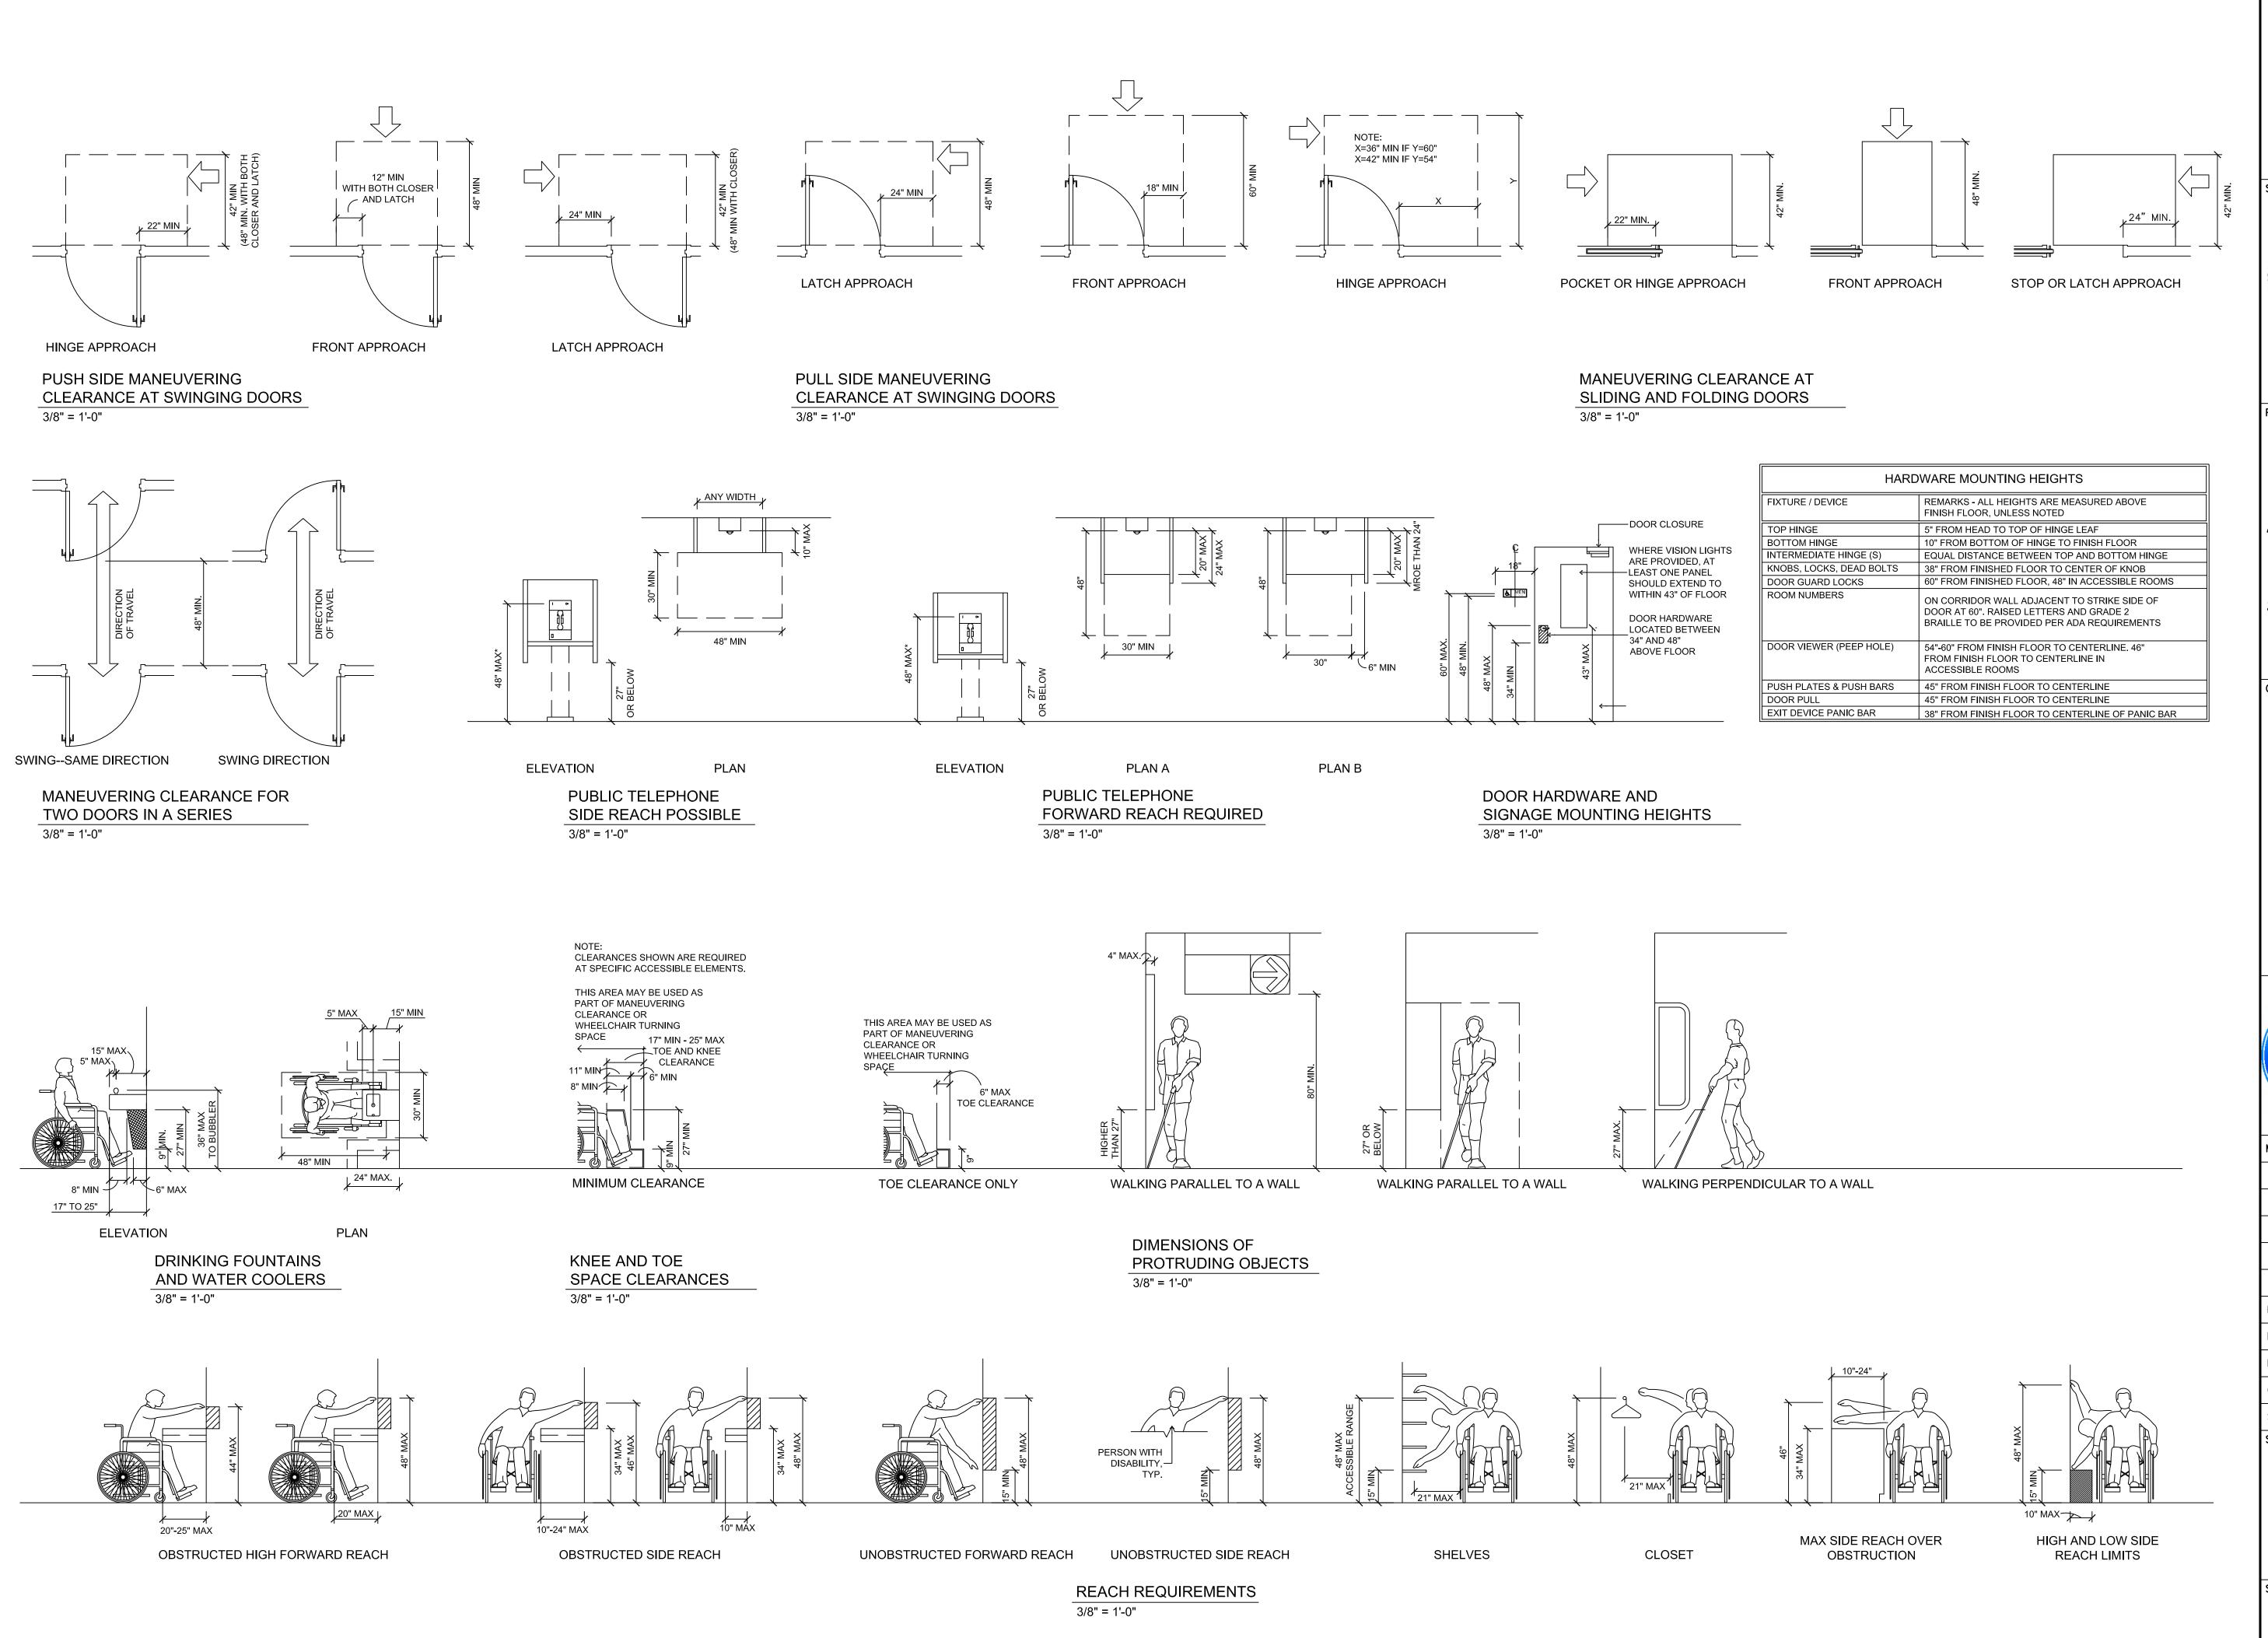
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NEW VEGETATION

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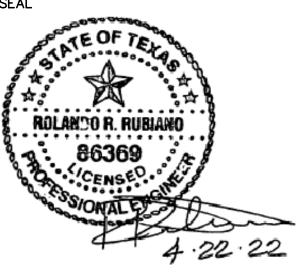
GLO-B2



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AL

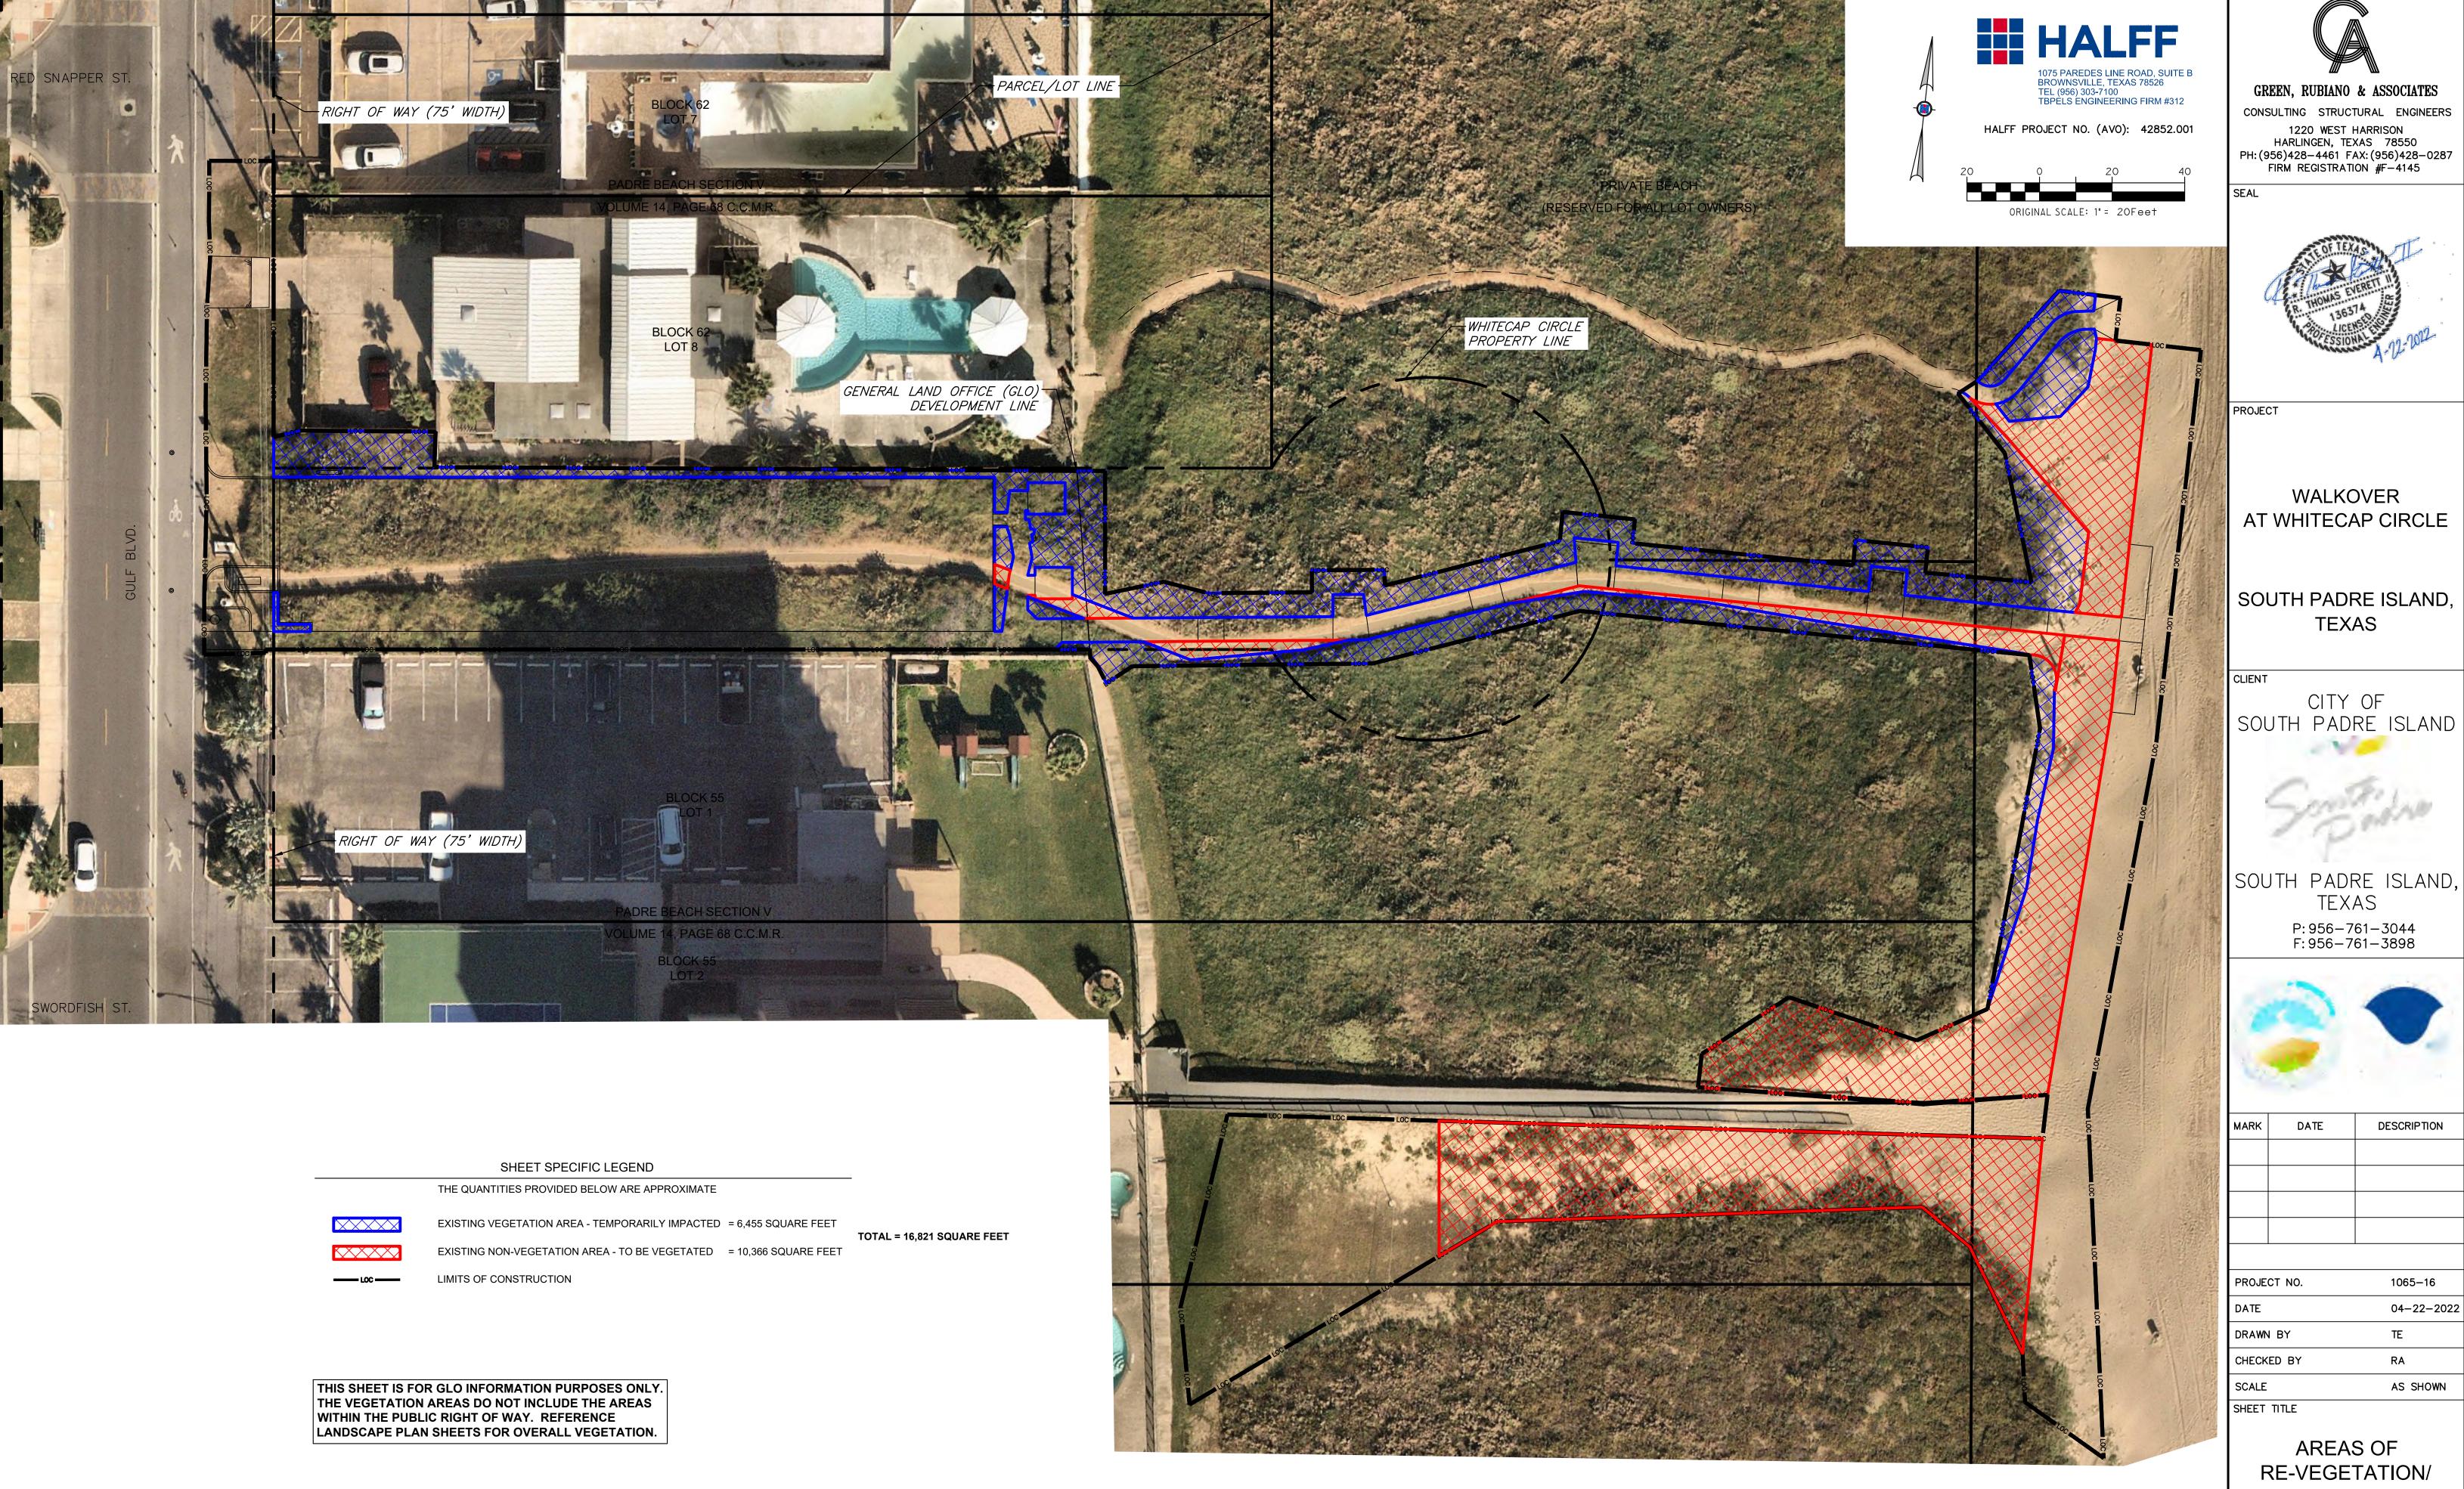

PROJECT

WALKOVER AT WHITE CAP CIRCLE

SOUTH PADRE ISLAND, TEXAS

CLIENT


CITY OF SOUTH PADRE ISLAND



SOUTH PADRE ISLAND, TEXAS

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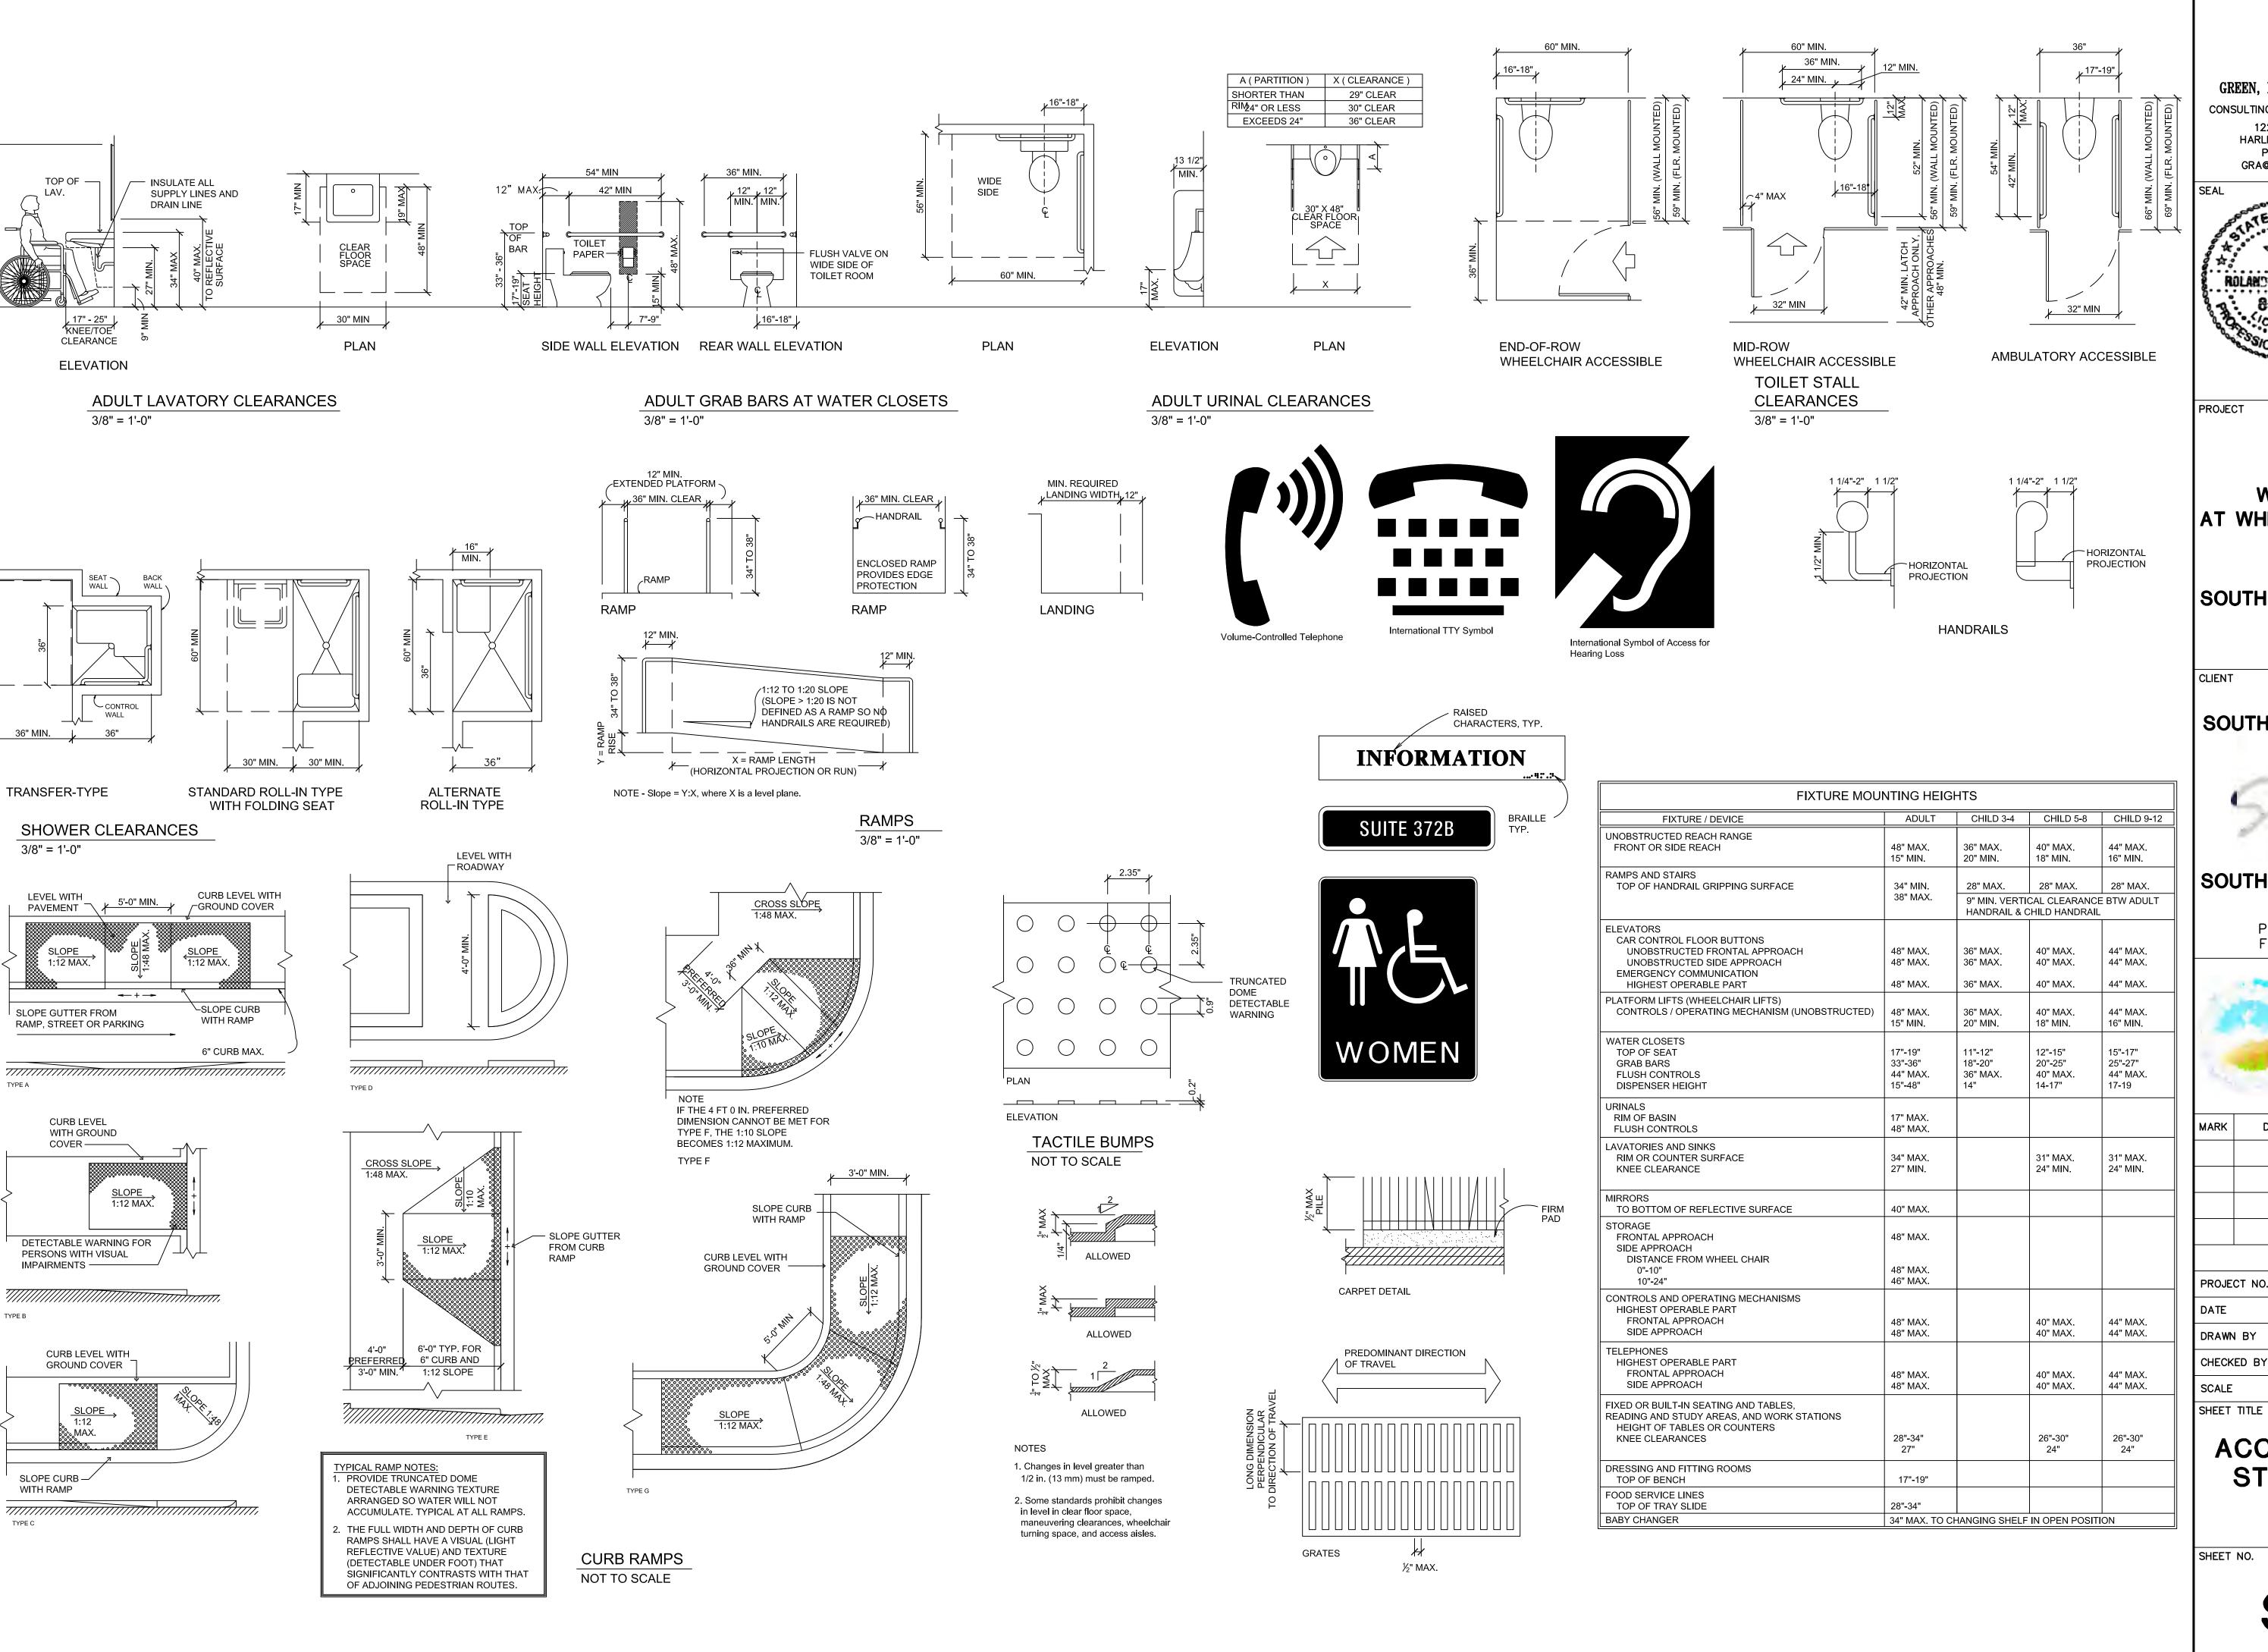
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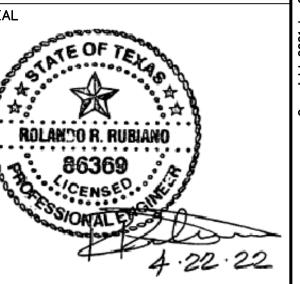
ACCESSIBILITY STANDARDS

SHEET NO.

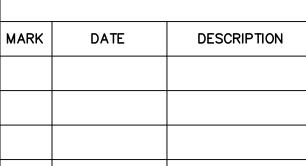S1.1



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WALKOVER AT WHITE CAP CIRCLE

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CITY OF SOUTH PADRE ISLAND



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SCALE	AS SHOWN

ACCESSIBILITY STANDARDS

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GENERAL NOTES

SCOPE OF PROJECT

SCOPE OF WORK IS DEFINED BY THE DRAWINGS AND SPECIFICATIONS, INCLUDES ALL SUPERVISION, LABOR, MATERIALS, EQUIPMENT, PERMITTING AND FEES TO ACCOMPLISH THE WORK. THE SCOPE INCLUDES, BUT IS NOT LIMITED TO:

1. INSTALLATION OF NEW BEACH VEHICLE DRIVE OVER CONCRETE STRUCTURE AND WOOD WALKOVER STRUCTURE AT WHITE SANDS STREET, AND ASSOCIATED IMPROVEMENTS.

CODE COMPLIANCE

- 1. ALL WORK PREFORMED SHALL BE COMPLETED IN ACCORDANCE WITH ALL STATE, FEDERAL, AND LOCAL CODES, ORDINANCES, AND LAWS, INCLUDING THE INTERNATIONAL BUILDING CODE 2012 EDITION.
- 2. ALL DEMOLITION MATERIAL SHALL BE PROPERLY DISPOSED OF IN A LANDFILL MEETING ALL FEDERAL, STATE, AND LOCAL REGULATORY REQUIREMENTS. CONTRACTOR SHALL PROVIDE PROPER DOCUMENTATION FROM LANDFILL INDICATING PROPER DISPOSAL OF DEMOLITION MATERIAL.

COORDINATION

1. THE CONTRACTOR SHALL COORDINATE WORK BETWEEN ALL TRADES. ANY CONFLICTS SHALL BE BROUGHT TO THE ENGINEER'S ATTENTION PRIOR TO THE WORK BEING INSTALLED. FAILURE TO DO SO WILL MAKE THE CONTRACTOR RESPONSIBLE FOR THE COST OF THE WORK.

EXISTING CONDITIONS

- 1. THE CONTRACTOR SHALL VISIT THE SITE OF THE PROPOSED WORK AND FULLY ACQUAINT THEMSELVES WITH THE EXISTING CONDITIONS.
- 2. THE CONTRACTOR SHALL FIELD VERIFY ALL EXISTING DIMENSIONS AND CONDITIONS. DIMENSIONS SHOWN ON THE PLANS ARE APPROXIMATE. CONTRACTOR SHALL OBTAIN ALL FIELD MEASUREMENTS AS NECESSARY TO COORDINATE NEW CONSTRUCTION TO EXISTING CONDITIONS.
- 3. IF EXISTING CONDITIONS DIFFER FROM THE DRAWINGS, INFORM THE ENGINEER AND ADDITIONAL DETAILS OR INTERPRETATION WILL BE PROVIDED. DO NOT PROCEED WITHOUT VERIFICATION.
- 4. IT IS THE GENERAL CONTRACTOR'S RESPONSIBILITY TO LOCATE ALL UNDERGROUND UTILITIES, INCLUDING STORM SEWER SYSTEM LINES, WASTE WATER LINES, IRRIGATION LINES, ETC., PRIOR TO MOBILIZATION AND COMMENCEMENT OF WORK. CONTACT ALL CITY OF SOUTH PADRE ISLAND MUNICIPALITIES AS REQUIRED TO LOCATE UNDERGROUND UTILITIES. ANY COSTS TO REPAIR DAMAGES IF UTILITIES ARE NOT PROPERLY IDENTIFIED, ARE THE SOLE RESPONSIBILITY OF THE CONTRACTOR.

TEMPORARY BRACING, FALSEWORK AND FORMWORK

- 1. THE DESIGN, ENGINEERING, FABRICATION, CONSTRUCTION, ERECTION, REMOVAL AND OVERALL SAFETY OF ALL TEMPORARY SUPPORTS SUCH AS FALSEWORK, FORMWORK, SHORES AND BRACING REQUIRED FOR THE EXECUTION OF THE CONTRACT ARE NOT INCLUDED IN THE DRAWINGS AND SHALL BE THE RESPONSIBILITY OF THE CONTRACTOR.
- 2. THE ENGINEER'S EFFORTS ARE AIMED AT DESIGNING A PROJECT WHICH WILL BE SAFE AFTER FULL COMPLETION. THE ENGINEER HAS NO EXPERTISE IN, AND TAKES NO RESPONSIBILITY FOR, CONSTRUCTION MEANS AND METHODS OR JOB SITE SAFETY DURING CONSTRUCTION. SAFETY IS EXCLUSIVELY THE CONTRACTOR'S RESPONSIBILITY. PROCESSING AND/OR APPROVING SUBMITTALS MADE BY CONTRACTOR WHICH MAY CONTAIN INFORMATION RELATED TO SHORING, CONSTRUCTION METHODS OR SAFETY ISSUES, OR PARTICIPATION IN MEETINGS WHERE SUCH ISSUES MIGHT BE DISCUSSED, MUST NOT BE CONSTRUED AS VOLUNTARY ASSUMPTION BY ENGINEER OF ANY RESPONSIBILITY FOR THESE SAFETY PROCEDURES.

DOCUMENTATION OF PRE-CONSTRUCTION PHOTOGRAPHS

1. THE CONTRACTOR SHALL PHOTOGRAPH AND/OR VIDEO DOCUMENT AND TAKE WRITTEN NOTES OF EXISTING CONDITIONS PRIOR TO THE COMMENCEMENT OF THE WORK ON THE SITE. COPIES OF ALL DOCUMENTATION TO BE PRESENTED TO THE OWNER PRIOR TO COMMENCING WORK.

PROTECTION OF EXISTING ADJACENT BUILDINGS

- 1. CONTRACTOR SHALL TAKE THE PROPER PRECAUTIONS NOT TO DAMAGE ADJACENT BUILDINGS DURING DEMOLITION.
- 2. THE CONTRACTOR SHALL TAKE PROPER PRECAUTION TO PROTECT ALL ADJACENT EXISTING TREES, LANDSCAPING, SITE LIGHTING, SIDEWALKS, AND SITE FEATURES FROM DAMAGE THROUGHOUT COURSE OF WORK. IF DAMAGED DURING THE COURSE OF THE WORK, REPAIR TO PRE—CONSTRUCTION CONDITION PRIOR TO COMPLETION OF THE PROJECT.

SAFETY

- 1. PERFORM ALL WORK IN A SAFE AND CONSCIENTIOUS MANNER TO PREVENT INJURIES.
- 2. CONTRACTOR SHALL MAINTAIN OSHA STANDARDS FOR JOB SAFETY AND WORKER PROTECTION, INCLUDING, BUT NOT LIMITED TO ADEQUATE PROTECTION, BARRICADES, SIGNS, ETC.
- 3. PEDESTRIAN PROTECTION REQUIREMENTS: PROVIDE CANOPY AND/OR BARRICADES AT SIDEWALKS AND OTHER PUBLICLY ACCESSIBLE AREAS WHICH MAY BE SUBJECT TO FALLING DEBRIS FROM THE WORK. COORDINATE ACCESS REQUIREMENTS WITH OWNER. BARRICADES AND CANOPY SHALL MEET OR EXCEED THE APPLICABLE REQUIREMENTS OF FEDERAL, STATE AND LOCAL LAWS, CODES, AND REGULATIONS OF AUTHORITIES HAVING JURISDICTION. AS A MINIMUM, CANOPY SHALL COMPLY WITH SECTION 3306, "PROTECTION OF PEDESTRIANS" OF THE 2012 EDITION OF THE INTERNATIONAL BUILDING CODE (IBC). UPON COMPLETION OF REMOVAL OF CANOPY AND BARRICADES, LEAVE PROPERTY IN GOOD CONDITION AS IT WAS PRIOR TO COMMENCEMENT OF WORK.
- 4. ALL CONSTRUCTION MATERIALS SHALL BE LOCKED—UP OR PLACED INSIDE A LOCKED CONSTRUCTION FENCE TO ENSURE MATERIALS DO NOT BECOME WINDBORNE OR CAUSE INJURY TO RESIDENTS, VISITORS OR PUBLIC.
- 5. THE GENERAL CONTRACTOR IS SOLELY RESPONSIBLE FOR SAFETY. THE OWNER AND ENGINEER EXPRESSLY EXLUDE ANY RESPONSIBILITY FOR CONTRACTOR SAFETY OR SAFETY OF JOBSITE.

TEMPORARY FACILITIES

1. COORDINATE LOCATION AND PLACEMENT OF FIELD OFFICE, MATERIAL STORAGE, PORTABLE TOILET, DUMPSTERS, ETC. WITH OWNER PRIOR TO CONSTRUCTION.

USE OF THE PREMISES

- 1. EQUIPMENT ACCESS TO BE SCHEDULED WITH OWNERS REPRESENTATIVE 48 HOURS IN ADVANCE.
- 2. TYPICAL HOURS OF WORK: 7:00 AM 7:00 PM MONDAY FRIDAY, 8:00 AM —7:00 PM SATURDAY, 9:00 AM 5:00 PM— SUNDAY, UNLESS OTHER ARRANGEMENTS MADE WITH OWNER'S REPRESENTATIVE. PRIOR TO COMMENCING WORK, COORDINATE HOURS OF WORK WITH THE OWNER TO MINIMIZE IMPACT TO THE SITE'S DAY—TO—DAY OPERATIONS.
- 3. MAINTAIN PUBLIC ACCESS FOR THE DURATION OF THE PROJECT, OR AS REQUIRED BY OWNER
- 4. AN ON-SITE STORAGE AREA IS TO BE ESTABLISHED DURING CONSTRUCTION. STORAGE IS TO BE PROTECTED IN A SECURE WEATHERPROOF LOCATION TO PREVENT DAMAGE TO THE CONTENTS.
- 5. PROVIDE REGULAR SITE CLEAN UP. STORE MATERIALS IN A NEAT AND ORDERLY MANNER.
- 6. DO NOT PLACE LOADS ON THE EXISTING ADJACENT STRUCTURES OR STORE DEMOLISHED MATERIALS ON THE STRUCTURES IN A MANNER THAT WILL DAMAGE THEM.
- 7. WORKERS SHALL BE PROPERLY DRESSED AND DISPLAY APPROPRIATE BEHAVIOR AT ALL TIMES IN CONSTRUCTION AND ADJACENT AREAS.
- 8. REPAIR/RESTORE DAMAGED LAWN OR OTHER LANDSCAPING AT COMPLETION OF THE WORK AT NO COST TO OWNER.
- 9. REFERENCE "TOWN OF SOUTH PADRE ISLAND BUILDING CONSTRUCTION SITE MANAGEMENT NOTICE" FOR ADDITIONAL REQUIREMENTS.

SITE MAINTENANCE

AT WHITE CAP CIRCLE BEACH ACCESS

- 1. MAINTAIN AREAS FREE OF WASTE MATERIALS, DEBRIS, AND RUBBISH.
- 2. MAINTAIN SITE IN A CLEAN AND ORDERLY CONDITION. AREAS USED AS PATHWAYS TO TRANSPORT MATERIALS OR TO REMOVE TRASH THAT ARE NOT DIRECTLY UNDER CONSTRUCTION ARE TO BE KEPT CLEAN.

FIRE PROTECTION

- 1. THE CONTRACTOR SHALL BE RESPONSIBLE FOR FIRE PROTECTION AND FIRE WATCH DURING ALL CONSTRUCTION OPERATIONS.
- 2. NO SMOKING SHALL BE PERMITTED AT THE SITE. CONTRACTOR SHALL PROVIDE AND MAINTAIN TEMPORARY FIRE EXTINGUISHERS UNTIL SUBSTANTIAL COMPLETION.

HAZARDOUS MATERIALS ABATEMENT/ MANAGEMENT


1. THE ENGINEER HAS NO RESPONSIBILITY OR LIABILITY FOR DESIGN, REMOVAL OF, OR TESTING FOR ASBESTOS/LEAD, OR FOR ABATEMENT /MANAGERIAL TREATMENTS, MONITORING, AND LEGAL DISPOSAL OF MATERIALS. CONTRACTOR SHALL DETERMINE IF ANY HAZARDOUS MATERIAL ABATEMENT/ MANAGEMENT IS REQUIRED AND SHALL INCLUDE COSTS THEREOF IN THE BID.



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PROJECT

WALKOVER AT WHITE CAP CIRCLE

SOUTH PADRE ISLAND, TEXAS

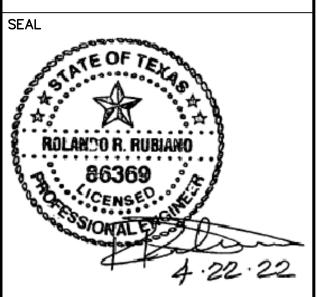CLIENT

MARK

CITY OF SOUTH PADRE ISLAND



SOUTH PADRE ISLAND, TEXAS

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PROJECT NO.		1065–16

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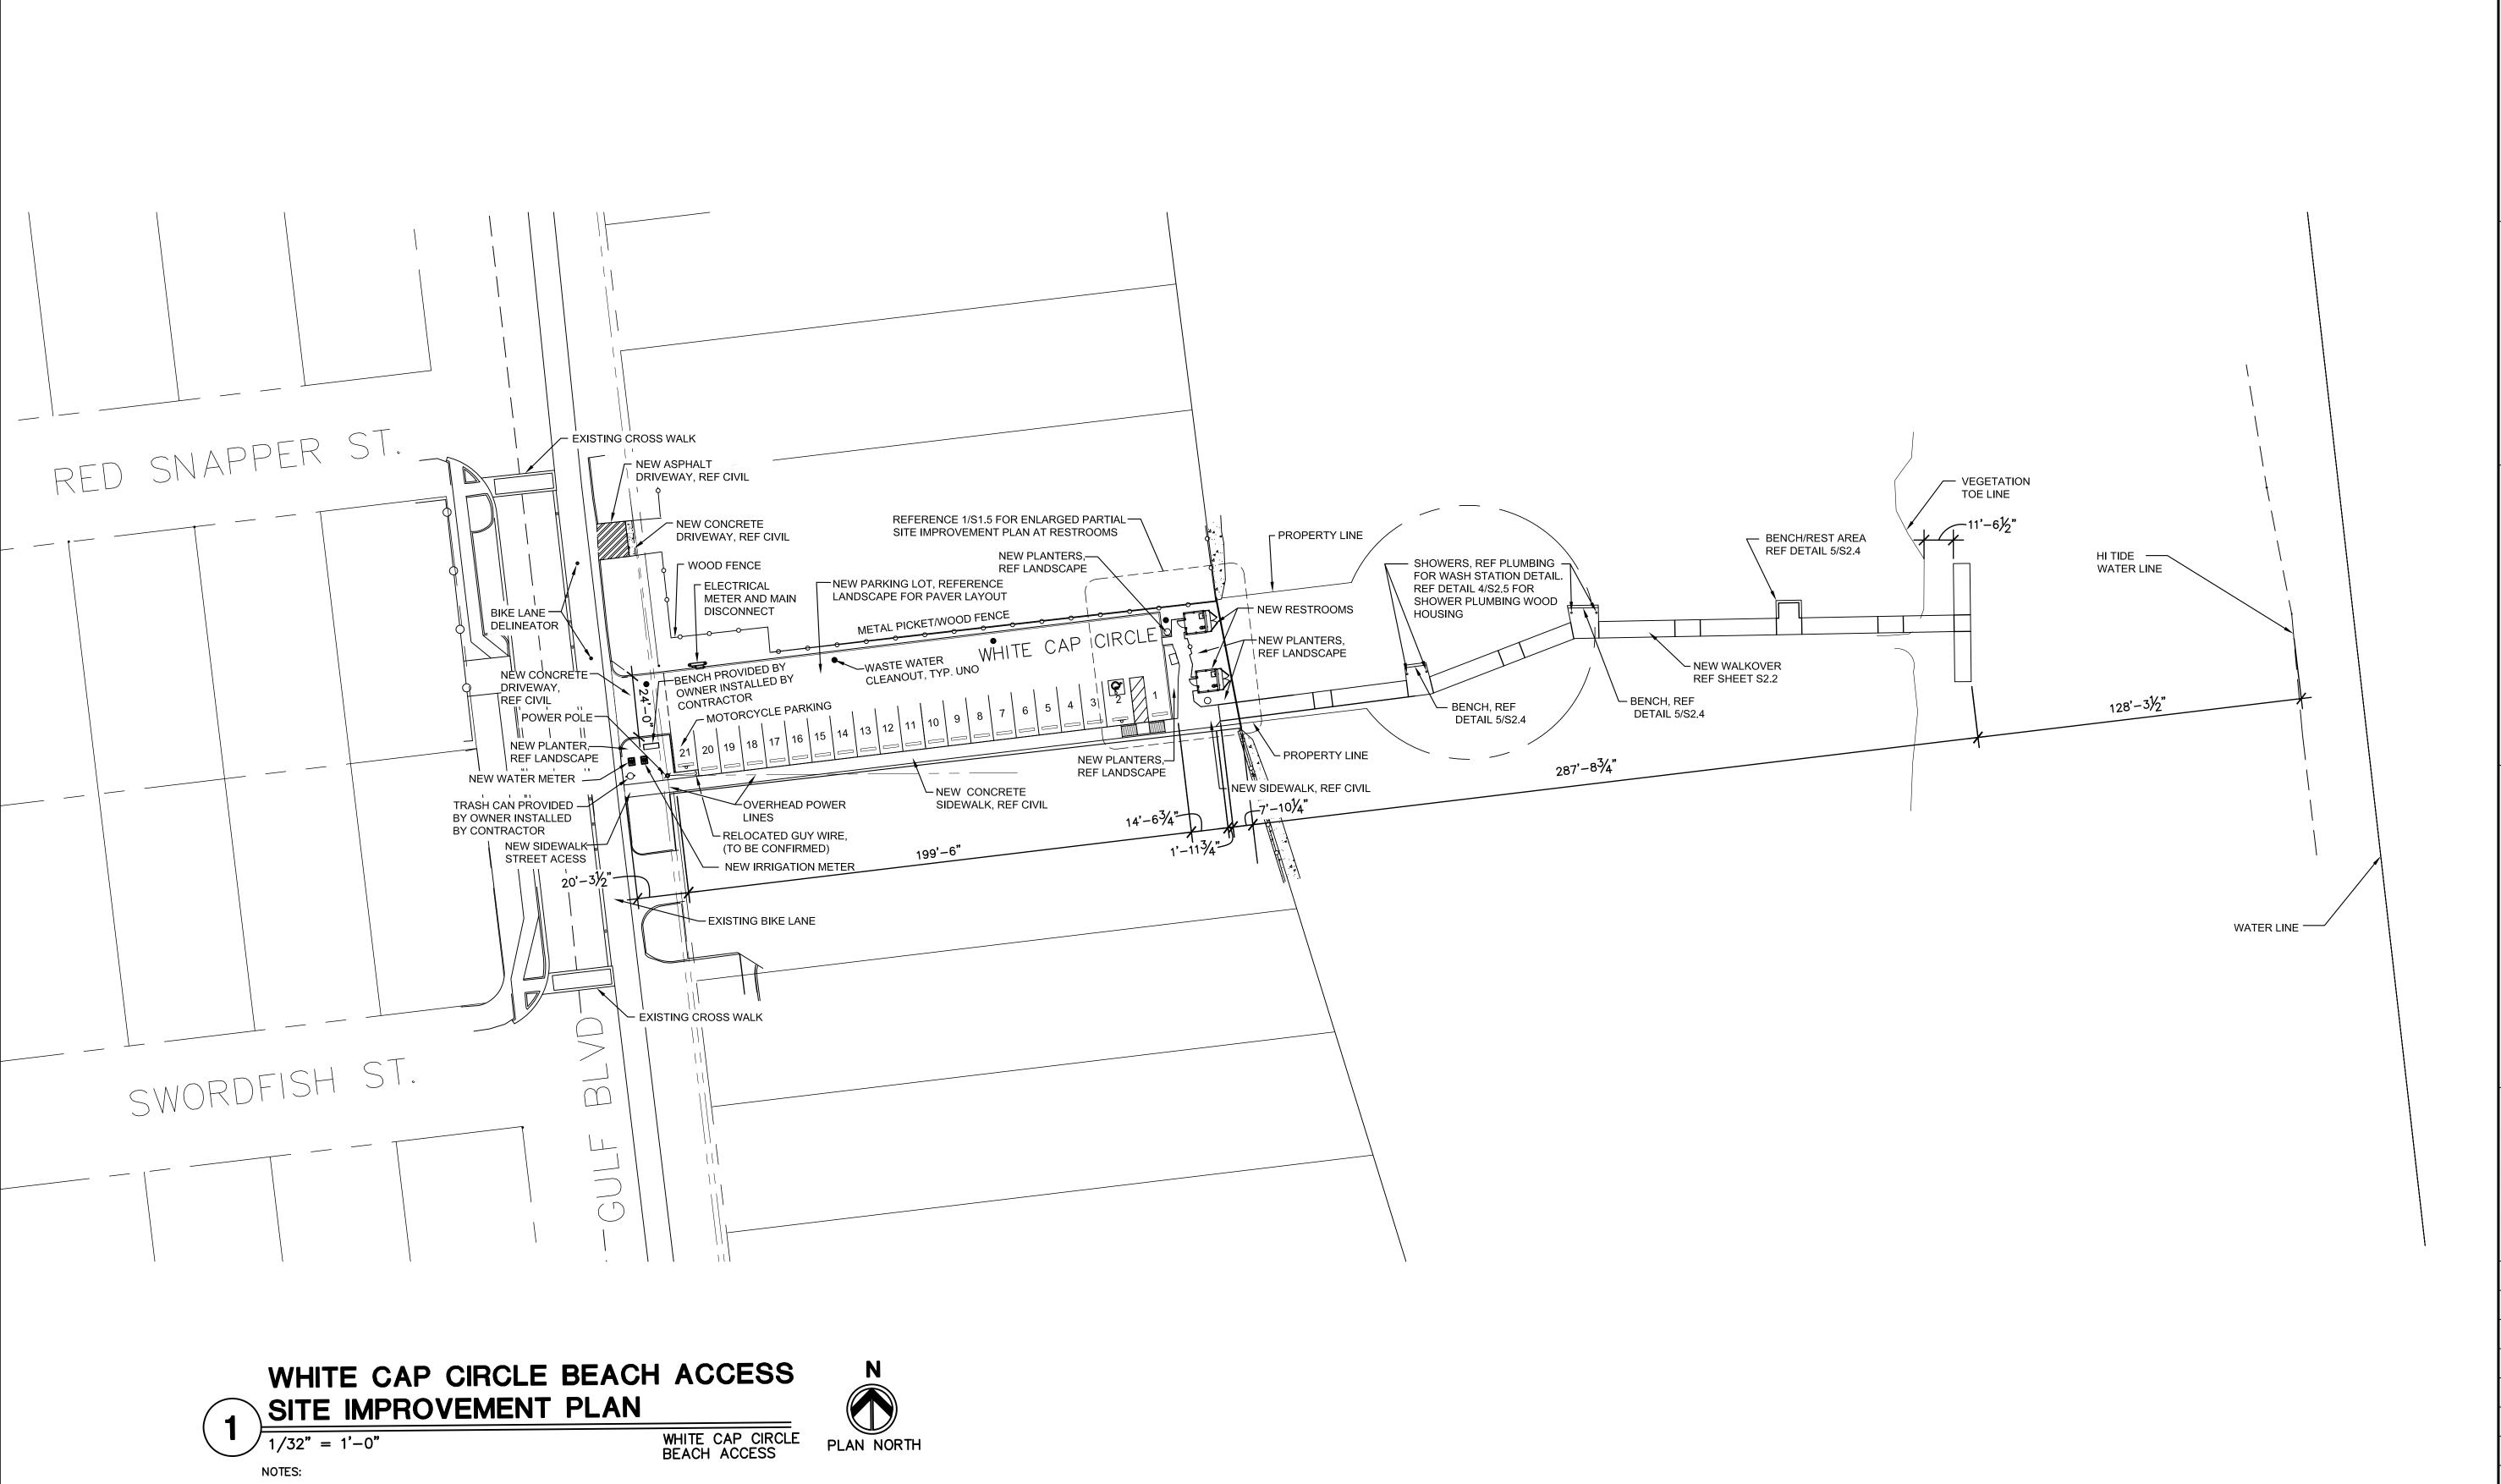
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PROJECT NO.	1065-16
DATE	04-22-2022
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SCALE	AS SHOWN
SHEET TITLE	

SITE AERIAL AND GENERAL NOTES

SHEET NO.

S1.3



1. UNLESS OTHERWISE NOTED ON IMPROVEMENT KEY LEGEND,

REFER TO CIVIL DRAWINGS FOR ADDITIONAL SCOPE TO BE PERFORMED UNDER THIS CONTRACT.

ALL EXISTING SITE COMPONENTS SHALL REMAIN


REFER TO CIVIL DRAWINGS FOR GRADING PLAN & TOPOGRAPHIC SURVEY.

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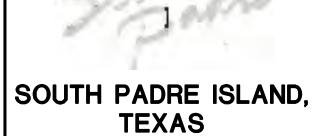
PROJECT

WALKOVER AT WHITE CAP CIRCLE

SOUTH PADRE ISLAND, TEXAS

CLIENT

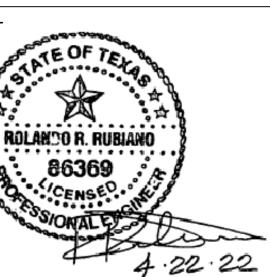CITY OF SOUTH PADRE ISLAND



P: 956-761-3044 F: 956-761-3898





MARK	DATE	DESCRIPTION

PROJECT NO.	1065–16
DATE	04-22-2022
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SHEET TITLE

SITE IMPROVEMENT PLAN

SHEET NO.

S1.4



WHITE CAP CIRCLE BEACH ACCESS SITE IMPROVEMENT PLAN

WHITE CAP CIRCLE BEACH ACCESS



NOTES:

- 1. UNLESS OTHERWISE NOTED ON IMPROVEMENT KEY LEGEND, ALL EXISTING SITE COMPONENTS SHALL REMAIN
- REFER TO CIVIL DRAWINGS FOR ADDITIONAL SCOPE TO BE PERFORMED UNDER THIS CONTRACT.
- REFER TO CIVIL DRAWINGS FOR GRADING PLAN & TOPOGRAPHIC SURVEY.

GREEN, RUBIANO & ASSOCIATES

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PROJECT

WALKOVER AT WHITE CAP CIRCLE

SOUTH PADRE ISLAND, **TEXAS**

CLIENT

CITY OF SOUTH PADRE ISLAND



SOUTH PADRE ISLAND, **TEXAS**

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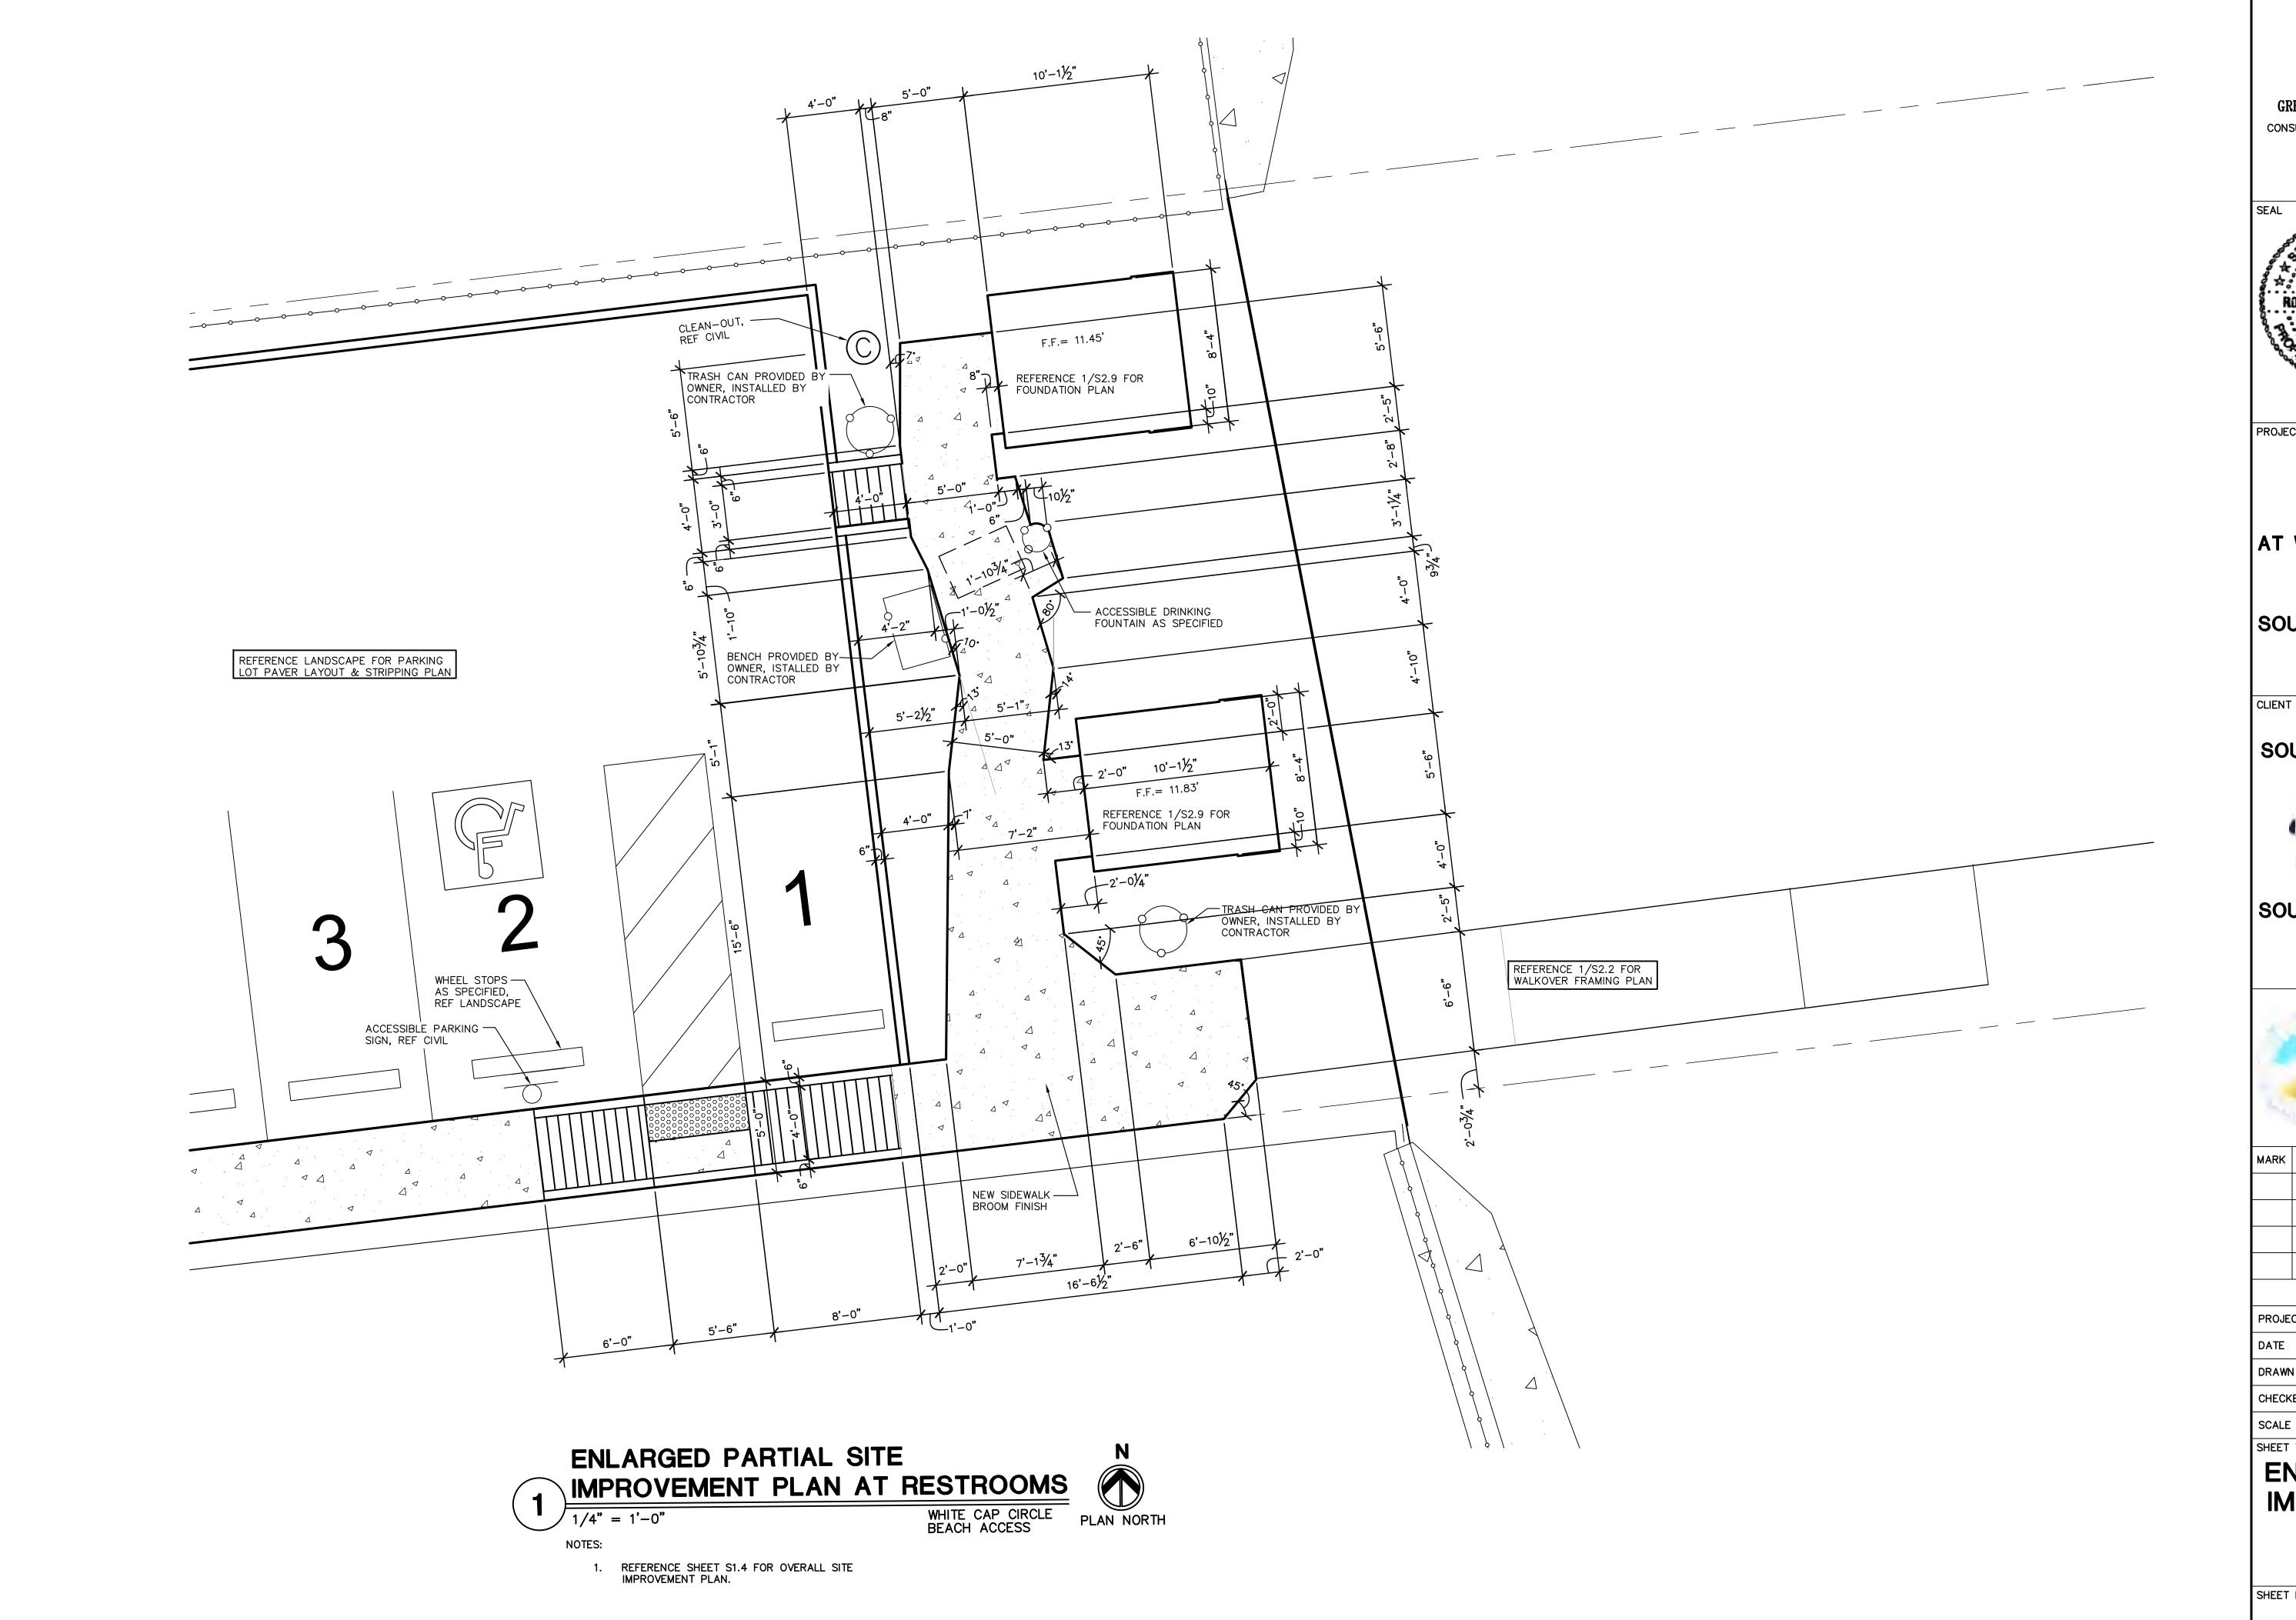


PROJECT NO.	1065–16
DATE	04-22-2022
DRAWN BY	LC
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SCALE	AS SHOWN
SHEET TITLE	

SITE **IMPROVEMENT PLAN WITH AERIAL OVERLAY**


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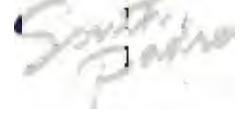


PROJECT

WALKOVER AT WHITE CAP CIRCLE

SOUTH PADRE ISLAND, **TEXAS**

CITY OF SOUTH PADRE ISLAND

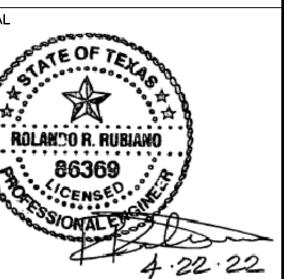

SOUTH PADRE ISLAND, **TEXAS**

P: 956-761-3044 F: 956-761-3898





PROJECT NO.	1065–16
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ENLARGED SITE **IMPROVEMENT PLAN**

AS SHOWN

SHEET NO.

GENERAL STRUCTURAL NOTES

THESE GENERAL NOTES SHALL APPLY UNLESS OTHERWISE SPECIFICALLY NOTED ON PLANS OR DETAILS. THE CONTRACTOR SHALL VERIFY ALL DIMENSIONS AND SHALL COORDINATE ALL STRUCTURAL PLANS AND DETAILS WITH ARCHITECTURAL & CIVIL DRAWINGS BEFORE STARTING WORK. THE ENGINEER SHALL BE NOTIFIED OF ANY DISCREPANCIES PRIOR TO CONSTRUCTION. THE ENGINEER ASSUMES NO RESPONSIBILITY FOR CONTRACTOR MEANS AND METHODS OF CONSTRUCTION OR SITE SAFETY. DESIGN, CONSTRUCTION, WORKMANSHIP AND MATERIALS SHALL COMPLY WITH THE CONTROLLING PROVISIONS OF THE 2018 EDITION OF THE INTERNATIONAL BUILDING CODE (IBC).

DESIGN CRITERIA

A. GOVERNING BUILDING CODE	IBC 2018 EDITION
2. GRAVITY DESIGN	
RESTROOMS:	
DEAD LOAD	SELF-WEIGHT OF STRUCTURE
	& ROOFING SYSTEM
LIVE LOAD (ROOF)	20 PSF
LIVE LOAD	50 PSF
WALKOVERS:	

3. BREAKING WAVE LOADS ON CROSSOVER STRUCTURE

1. BASIS FOR DESIGN AND CODE COMPLIANCE

- A. BASE FLOOD ELEVATION . ELEV 12'-0"
- B. ASSUMED GROUND ELEVATION AT STORM
- . ELEV 0'-0"
- C. COEFFICIENT OF DRAG FOR BREAKING WAVES FOR DRILLED PIER Cd = 1.75
- D. DYNAMIC PRESSURE COEFFICIENT FOR VERTICAL SURFACE CATEGORY II, Cp = 2.8

4. WIND DESIGN BASED ON:

DEAD LOAD...

LIVE LOAD (ROOF)....

A. ASCE 7-16 REQUIREMENTS

ULTIMATE DESIGN WIND SPEED	140	MPH	(VASD=108	MF
OCCUPANCY CATEGORY			•	
WIND EXPOSURE CATEGORY)			
INTERNAL PRESSURE COEFFICIENT (GCpi)	+/-	0.18		
Kzt				
Kd	0.85	,		

- 5. THESE BUILDINGS ARE DESIGNED TO MEET ASCE 7-16 WIND PRESSURES. ALL COMPONENTS AND CLADDINGS (E.G. WINDOWS, DOORS, ARCHITECTURAL SIDINGS AND ROOF PANELS) MUST MEET MINIMUM WIND CODE REQUIREMENTS.
- . PIER DESIGN IS IN ACCORDANCE WITH THE 2018 INTERNATIONAL BUILDING CODE, AND IS BASED ON THE VALUES RECOMMENDED IN TABLE 1806.2 PRESUMPTIVE LOAD BEARING VALUES, AS LISTED BELOW:

VERTICAL FOUNDATION PRESSURE	2,000 PSF
ALLOWABLE SHAFT RESISTANCE	333 PSF

LATERAL BEARING CAPACITY...

7. A GEOTECHNICAL ENGINEER SHALL BE RETAINED TO PERFORM TESTING AND INSPECTIONS DURING INSTALLATION OF DRILLED PIERS AND WOOD PILES AS REQUIRED BY SPECIFICATIONS AND GENERAL STRUCTURAL NOTES.

WOOD PILES

- MAXIMUM DESIGN LOAD OF EACH PILE IS 6.0 KIPS.
- PRIOR TO PILE PLACEMENT, THE CONTRACTOR SHALL PROVIDE THE ENGINEER DATA REGARDING THE PROPOSED HAMMER AND CUSHION SYSTEM.
- PILES SHALL BE ASTM D-25, CLASS "C" TREATED, PEELED SOUTHERN YELLOW PINE OR DOUGLAS FIR. PILES SHALL BE CREOSOTED ACCORDING TO AWPA MANUAL STANDARDS C-3 WITH A MINIMUM RETENTION OF 12 POUNDS PER CUBIC
- PILES SHALL HAVE A MINIMUM BUTT DIAMETER OF 12 INCHES AND A MINIMUM TIP DIAMETER OF 8 INCHES.
- A 8 INCH DIAMETER PILOT HOLE MAY BE DRILLED TO A DEPTH OF 5 FEET ABOVE THE FINAL TIP ELEVATION TO FACILITATE PILE DRIVING. JETTING ALONG SIDE OF PILES IS NOT PERMITTED.
- PILES SHALL BE DRIVEN WITH A DYNAMIC HAMMER HAVING AN EFFECTIVE DRIVING ENERGY OF 18,000 TO 48,000 FT/LBS/BLOW.
- ADEQUATE CUSHIONING MATERIAL SHALL BE PROVIDED BETWEEN THE PILE DRIVER CAP AND THE PILE HEAD. A SOFTWOOD CUSHION WITH A THICKNESS OF 6 TO 12 INCHES IS PREFERRED.
- THE PILE DRIVING HELMET OR CAP SHALL BE SUFFICIENTLY LOOSE AROUND THE PILE BUTT SO AS NOT TO DEVELOP TORSIONAL STRESSES IN THE PILE DURING INSTALLATION, HOWEVER THE HELMET SHOULD BE CAPABLE OF CONTROLLING PILE
- THE ENTIRE HAMMER-CUSHION-PILE SYSTEM SHOULD BE COMPATIBLE AND CAPABLE OF DRIVING PILES TO THE DESIGN PENETRATIONS WITHOUT DAMAGING PILES. BLOW COUNTS CONSISTENTLY IN EXCESS OF 50 BLOWS/FOOT ARE NOT IN LINE WITH GOOD PRACTICE.
- 10. PILES SHALL BE PROPERLY ALIGNED PRIOR TO DRIVING AND HELD WITH FIXED LEADS. REALIGNMENT ONCE DRIVING HAS COMMENCED IS NOT PERMITTED.

DRILLED PIERS

- EACH PIER SHAFT SHALL BE INSPECTED BY QUALIFIED GEOTECHNICAL OR A/E PERSONNEL TO INSURE PROPER BEARING AT SCHEDULED ELEVATION AND TO VERIFY STRATAS NOTED IN THE GEOTECHNICAL REPORT.
- ALL PIERS SHALL BE CENTERED ON BEAMS UNLESS OTHERWISE SHOWN.
- DRILL PIERS TO THE EXACT SIZE SHOWN. SHAFTS SHALL BE BORED PLUMB WITH A TOLERANCE OF TWO INCHES. INSTALL OFFSET STAKES ON OPPOSITE SIDES OF THE PIER AND USE TO MAINTAIN THE PIER CENTERS AND TO CHECK THE PIER PLUMBNESS. FOOTING BOTTOMS SHALL BE INSPECTED FOR A MAXIMUM OF ONE INCH (1") OF LOOSE DIRT AND TWO INCHES (2") OF GROUND WATER IMMEDIATELY PRIOR TO PLACING CONCRETE. IF MACHINE CLEANING IS NOT SATISFACTORY TO ARCHITECT/ENGINEER. HAND CLEANING WILL BE REQUIRED.

DRILLED PIERS CONTINUED

- FOR ESTIMATING PURPOSES. CARRY ALL PIERS TO THE DEPTHS INDICATED ON THE DRAWINGS. WHEN DIRECTED BY THE ARCHITECT / ENGINEER. PIERS SHALL BE ADJUSTED AS REQUIRED TO MEET DESIGN REQUIREMENTS ADJUSTMENTS WILL BE SPECIFIED IN THE CONTRACT PRICE FOR DEPTH ADJUSTMENTS IN ACCORDANCE WITH THE UNIT PRICES QUOTED IN THE CONTRACTOR'S BID.
- DUE TO SUBSURFACE STRATIGRAPHY AND WATER LEVELS ENCOUNTERED DURING DRILLING OPERATIONS, IF THE CONTRACTOR CANNOT INSTALL THE RECOMMENDED PIER AT THE REQUIRED DEPTH. THE ENGINEER MUST BE CONTACTED IMMEDIATELY.
- PROVIDE SUITABLE ACCESS AND LIGHTING FOR INSPECTION OF THE EXCAVATIONS FOR CLEANLINESS AND FOR CORRECTNESS OF DIMENSIONS AND
- PLACEMENT OF CONCRETE SHALL BE ACCOMPLISHED AS SOON AS POSSIBLE AFTER EXCAVATION IS COMPLETE, REINFORCING CAGE IS PLACED AND INSPECTED. THE CONCRETE SHOULD NOT BE ALLOWED TO RICOCHET OFF THE WALLS OF THE PIER EXCAVATION NOR OFF OF THE REINFORCING STEEL. PLACEMENT OF CONCRETE SHALL COMPLY WITH AMERICAN CONCRETE INSTITUTE (ACI) 318-89 CODE "BUILDING CODE REQUIREMENTS FOR REINFORCED CONCRETE" AND ACI 336-3R-72 ENTITLED "SUGGESTED DESIGN AND CONSTRUCTION PROCEDURES FOR PIER FOUNDATIONS". NO PIER EXCAVATION SHALL BE LEFT OPEN OVERNIGHT WITHOUT CONCRETING.
- CASINGS SHALL BE REQUIRED TO PREVENT CAVING OF SOIL AND SEEPAGE OF WATER INTO THE DRILLED FOOTINGS. CASINGS SHALL BE METAL WITH AMPLE STRENGTH TO WITHSTAND HANDLING STRESSES. CONCRETE AND EARTH PRESSURES, AND SHALL BE WATERTIGHT. CONTRACTORS SHALL FURNISH UNIT PRICES FOR CASING OF DIFFERENT SIZE PIER SHAFTS.
- AS AN ALTERNATE TO USING CASINGS TO INSTALL THE PIERS, THE SLURRY METHOD MAY BE CONSIDERED.

CONCRETE

..SELF-WEIGHT OF STRUCTURE

..100 PSF

- ALL CONCRETE WORK SHALL CONFORM TO THE AMERICAN CONCRETE INSTITUTE SPECIFICATION, A.C.I. #301 AND BUILDING CODE REQUIREMENTS, A.C.I. #318, LATEST EDITION.
- 2. ALL DETAILING, FABRICATION AND ERECTION OF REINFORCING BARS, UNLESS OTHERWISE NOTED, MUST FOLLOW THE A.C.I. "MANUAL OF STANDARD PRACTICE FOR DETAILING REINFORCED CONCRETE", A.C.I. #315, LATEST EDITION.
- CONCRETE SHALL HAVE A MINIMUM COMPRESSION STRENGTH OF 4000 PSI AT 28
- DAYS. PORTLAND CEMENT SHALL MEET ASTM C150, TYPE II (MODERATE).
- A MAXIMUM OF 25% FLYASH MAY BE USED AS A CEMENT SUBSTITUTE AND SHALL CONFORM TO ASTM C618, CLASS C. THE WATER/CEMENT RATIO SHALL NOT EXCEED 0.5 AND SLUMPS SHALL BE 5 INCHES (±1 INCH). CONCRETE FOR PIERS SHALL BE DESIGNED TO ACHIEVE SPECIFIED STRENGTH WHEN PLACED WITH A SEVEN (7) INCH (± 1) SLUMP. AGGREGATE SHALL BE WELL-GRADED, 1" MAXIMUM FOR THE SLAB ON GRADE, 1" MAXIMUM FOR CAST-IN-PLACE BEAMS AND ABOVE GRADE SLABS. COARSE AGGREGATE SHALL MEET ASTM C33, GRADATION #57. A QUALIFIED TESTING LABORATORY SHALL BE RETAINED TO FURNISH MIX DESIGNS FOR ALL CLASSES OF CONCRETE. A SAMPLE OF FOUR CYLINDERS SHALL BE TAKEN NOT LESS THAN ONCE A DAY, NOR LESS THAN ONCE FOR EACH 100 YD3 OF CONCRETE. ONE CYLINDER SHALL BE TESTED AT 7 DAYS AND TWO AT 28 DAYS. THE FOURTH CYLINDER MAY BE DISPOSED OF AFTER 45 DAYS IF NOT USED.
- ADMIXTURES CONTAINING WATER SOLUBLE CHLORIDE IONS GREATER THAN 0.06% BY WEIGHT OF CEMENT SHALL NOT BE USED.
- REINFORCING BARS SHALL BE NEW BILLET STEEL CONFORMING TO ASTM A-615, GRADE 60. #3 BARS MAY BE GRADE 40.
- STANDARD PROTECTIVE COVER OF REINFORCING BARS UNLESS OTHERWISE NOTED SHALL BE:

WHERE CAST AGAINST DIRT OR FILL	3	IN
EXPOSED TO EARTH OR WEATHER		
SLABS AND WALLS	-	
OTHER 1-		

- ALL ACCESSORIES SHALL BE IN ACCORDANCE WITH THE A.C.I. "MANUAL OF STANDARD PRACTICE FOR DETAILING REINFORCED CONCRETE", A.C.I. #315, LATEST EDITION. ACCESSORIES FOR EXPOSED CONCRETE SOFFITS SHALL HAVE PLASTIC
- SLAB MAT TO BE SUPPORTED BY REINFORCING BAR CHAIRS SPACED AT 4 FEET ON CENTER EACH WAY (MAX). BEAM CAGES SUPPORTED BY CHAIRS AT 4 FEET
- MAINTAIN A MINIMUM OF ONE AND ONE-HALF (1-1/2) TIMES THE MAXIMUM COARSE AGGREGATE SIZE BETWEEN ALL REINFORCING BARS (EXCEPT AT LAPS).
- BARS SCHEDULED OR DETAILED "CONT" SHALL BE LAPPED 48 BAR DIAMETERS (24 INCHES MINIMUM) UNLESS OTHERWISE NOTED. ON REINFORCED CONCRETE BEAMS. SPLICES OF BEAM BOTTOM BARS SHALL BE LAPPED AT THE COLUMN SUPPORTS, AND SPLICES OF TOP BARS SHALL BE LAPPED AT THE MIDDLE THIRD OF THE SPAN OF THE BEAM.
- WHERE CONCRETE IS TO HAVE UNEXPOSED SURFACES, THE FORMS MAY BE CONSTRUCTED OF #2 LUMBER OR BETTER. WHERE SURFACES ARE EXPOSED, SUCH AS FOR FINISH PAINTING THE FORMS SHALL BE COMMERCIAL STANDARD DOUGLAS FIR, MOISTURE-RESISTANT CONCRETE FORM PLYWOOD; MINIMUM 5-PLY AND AT LEAST 9/16" THICK, OR FORMS LINED WITH COMMERCIAL STANDARD DOUGLAS FIR CONCRETE FORM EXTERIOR, 3-PLY, NOT LESS THAN 1/4" THICK. WHERE CONCRETE IS EXPOSED, A SMOOTH SURFACE IS REQUIRED, FREE FROM FINS, HONEYCOMB, FORM MARKS OR OTHER DEFECTS.
- CONSTRUCT FORMS SO THAT JOINTS ARE LEAKPROOF. MAINTAIN FORMS SUFFICIENTLY RIGID TO PREVENT DEFORMATION UNDER LOAD.
- 14. COLUMN FORMS AND BEAMS SIDE FORMS MAY BE REMOVED 48 HOURS AFTER CONCRETE PLACEMENT. BEAM AND SLAB BOTTOM FORMS AND SHORING MAY BE REMOVED AFTER CONCRETE COMPRESSIVE STRENTH REACHES 3000 PSI OR
- CONCRETE MAY BE PLACED WITH CHUTES UP TO 25' MAXIMUM. SLUMP SHALL NOT EXCEED 6" AT TRUCK DISCHARGE POINT.
- 16. CONCRETE PLACED BY PUMPING SHALL MEET THE FOLLOWING REQUIREMENTS:
- a) COARSE AGGREGATE SHALL BE GRADED FROM A MAXIMUM OF 1" DOWN
- CUBIC YARD OVER NORMAL MIX DESIGN.

MAXIMUM ALLOWABLE INCREASE IN CEMENT FACTOR SHALL BE 1/2 SACK PER

- MAXIMUM WEIGHT RATIO OF FINE AGGREGATES TO COARSE AGGREGATES SHALL NOT EXCEED 2/3.

MAXIMUM WATER CEMENT RATIO SHALL BE 7-1/2 GALLONS PER SACK OF

CEMENT. IF MORE WORKABILITY IS REQUIRED, AN ADMIXTURE MAY BE USED.

REFER TO A.C.I. #301, LATEST EDITION, SECTION 800, FOR OTHER PUMPING REQUIREMENTS.

f) IN NO CASE SHALL CONCRETE BE PUMPED THROUGH AN ALUMINUM TUBE.

g) SLUMP SHALL NOT EXCEED 6" AT TRUCK DISCHARGE POINT.

CONCRETE CONTINUED

- 17. FLOOR FINISH (TOLERANCES)
- a) STEEL TROWEL FINISH 1/8" IN 10'
- b) FLOAT FINISH 1/4" IN 10'
- c) SCRATCH FINISH 1/2" IN 10'
- d) IN ALL INSTANCES MINIMUM SLAB THICKNESS SHALL BE PROVIDED. COORDINATE SLAB FINISH REQUIREMENTS WITH PLANS/SPECIFICATIONS. REFERENCE PLANS AND/OR SPECIFICATIONS FOR CONCRETE FINISHES.
- 18. CONCRETE TO BE CURED IN ACCORDANCE WITH ACI RECOMMENDATIONS. PROPOSED METHOD OF CURING TO BE COORDINATED WITH ENGINEER PRIOR TO CONCRETE PLACEMENT.
- 19. SHOP DRAWINGS SHALL BE PREPARED FOR ALL REINFORCING STEEL AND SUBMITTED FOR REVIEW BY ENGINEER. SUBMITTALS SHALL BE TRANSMITTED AS A SINGLE ELECTRONIC FILE (PDF FORMAT). ENGINEERING DRAWINGS SHALL NOT BE REPRODUCED AND USED AS SHOP DRAWINGS.
- 20. THE CONTRACTOR SHALL REVIEW AND ANNOTATE SHOP DRAWINGS BEFORE SUBMITTING THEM TO THE ARCHITECT/ENGINEER FOR REVIEW. THE CONTRACTOR SHALL ALLOW ARCHITECT/ENGINEER 10 WORKING DAYS FOR REVIEW OF SHOP DRAWINGS.
- 21. ENGINEER TO BE NOTIFIED 24 HOURS PRIOR TO PLACEMENT OF FOUNDATION AND OF STRUCTURAL CONCRETE TO SCHEDULE REQUIRED INSPECTIONS.

STRUCTURAL STEEL

- ALL STRUCTURAL STEEL SHALL BE DESIGNED, FABRICATED AND ERECTED IN ACCORDANCE WITH THE LATEST SPECIFICATIONS OF THE AMERICAN INSTITUTE OF STEEL CONSTRUCTION.
- 2. ALL MEMBERS SHALL BE FULL LENGTH WITHOUT SPLICES UNLESS INDICATED ON PLANS OR APPROVED BY THE ENGINEER IN WRITING.
- 3. ALL SHOP AND FIELD WELDS SHALL BE MADE BY WELDERS WHO HAVE BEEN QUALIFIED AND CERTIFIED TO MAKE THE REQUIRED WELDS IN ACCORDANCE WITH THE LATEST AMERICAN WELDING SOCIETY SPECIFICATIONS (A.W.S. D-1.1).
- WELDS SHALL BE MADE WITH COVERED MILD STEEL ELECTRODES COMPLYING WITH AWS D1-72 CODE AND SERIES E 70XX.
- . ERECTION CONNECTORS SHALL BE PROVIDED IN ORDER TO PROPERLY ALIGN AND BE TRUE AND PLUMB WHEN WELDS ARE MADE.
- S. ALL COMPLETE PENETRATION WELDS, BOTH SHOP AND FIELD, SHALL BE TESTED BY A QUALIFIED TESTING LABORATORY UTILIZING ULTRA SONIC TESTING PROCEDURES IN ACCORDANCE WITH AWSD1.1 ANY WELDS FOUND DEFECTIVE SHALL BE REMOVED AND REPLACED AT NO ADDITIONAL COST TO THE OWNER. ALL X-RAYED WELDS SHALL BE GROUND SMOOTH.
- 7. THE FABRICATOR SHALL SUPPLY BACK—UP PLATES AND EXTENSION TABS FOR ALL COMPLETE PENETRATION WELDS.
- 8. ALL STEEL MEMBERS, UNLESS NOTED OTHERWISE, SHALL STAINLESS STEEL.
- 9. AFTER ERECTION, PRIME WELDS, ABRASIONS AND SURFACES NOT PRIMED. USE PRIMER CONSISTENT WITH STEEL FINISH.
- 10. FIELD WELDS SHALL BE VISUALLY INSPECTED BY A QUALIFIED INDEPENDENT INSPECTOR. THE INSPECTOR SHALL PROVIDE A WRITTEN REPORT TO THE STRUCTURAL ENGINEER.
- 11. A SINGLE ELECTRONIC FILE (PDF FORMAT) SHOP DRAWINGS SHALL BE PREPARED FOR ALL STRUCTURAL STEEL COMPONENTS AND SUBMITTED FOR REVIEW BY ENGINEER. ENGINEERING DRAWINGS SHALL NOT BE REPRODUCED AND USED AS
- 12. THE CONTRACTOR SHALL REVIEW AND ANNOTATE SHOP DRAWINGS BEFORE SUBMITTING THEM TO THE ARCHITECT/ENGINEER FOR REVIEW. THE CONTRACTOR SHALL ALLOW ARCHITECT/ENGINEER 10 WORKING DAYS FOR REVIEW OF SHOP DRAWINGS.
- 13. THE STRUCTURAL ENGINEER SHALL BE NOTIFIED FOR A FRAMING OBSERVATIONS IMMEDIATELY AFTER ROOF DECK IS INSTALLED AND BEFORE INSTALLATION OF THE CEILING.

FASTENERS

- CAST-IN-PLACE AND POST-INSTALLED ANCHORS SHALL BE PER ANCHOR DIAMETER AND EMBEDMENT DEPTH NOTED ON THE DRAWINGS. POST-INSTALLED ANCHORS SHALL BE UTILIZED ONLY WHERE SPECIFIED. ALL ANCHORS SHALL BE HOT-DIPPED GALVANIZED PER ASTM A153
- 2. ALL ANCHORS NOTED BELOW SHALL BE INSTALLED IN ACCORDANCE WITH THE MANUFACTURER'S RECOMMENDATIONS. CONTRACTOR SHALL CONTACT MANUFACTURER'S REPRESENTATIVE FOR THE INITIAL TRAINING AND INSTALLATION OF ANCHORS, AND FOR PRODUCT RELATED QUESTIONS AND AVAILABILITY.
- 3. SPECIAL INSPECTIONS SHALL BE PROVIDED FOR ALL MECHANICAL AND ADHESIVE ANCHORS PER THE APPLICABLE EVALUATION REPORT NOTED BELOW. SPECIAL INSPECTIONS SHALL BE PERFORMED BY INDEPENDENT TESTING LABORATORY PERFORMING QA/QC SERVICES ON PROJECT.
- 4. EXPANSION BOLTS (EB) IN CONCRETE/CMU SHALL BE TESTED AND QUALIFIED FOR USE IN ACCORDANCE WITH ACI 355.2 AND ICC-ES AC193. ACCEPTABLE
- A. KWIK BOLT III (ICC-ES ESR-2302) BY HILTI (CONCRETE)
- B. KWIK BOLT III (ICC-ES-ESR-1385) BY HILTI (MASONRY)
- C. STRONG-BOLT 2 (ICC-ES ESR-3037) BY SIMPSON STRONG-TIE (CONCRETE)
- D. WEDGE-ALL ANCHOR (ICC-ES ESR-1396) BY SIMPSON STRONG-TIE (MASONRY)
- HEAVY DUTY SLEEVE ANCHORS IN CONCRETE/CMU SHALL BE TESTED AND QUALIFIED OR USE IN ACCORDANCE WITH ACI 355.2 AND ICC-ES AC193. EXPANSION BOLTS (EB) SHALL NOT BE SUBSTITUTED FOR SLEEVE ANCHORS WITHOUT PRIOR WRITTEN APPROVAL BY STRUCTURAL ENGINEER. ACCEPTABLE PRODUCTS:
- A. HSL-3 (ICC-ES ESR-1545) BY HILTI (CONCRETE)
- 6. SCREW ANCHORS IN CONCRETE SHALL BE TESTED AND QUALIFIED FOR USE IN ACCORDANCE WITH ACI 355.2 AND ICC-ES AC193. ACCEPTABLE PRODUCTS:
- A. KWIK HUS-EZ (ICC-ES ESR-3027) BY HILTI (CONCRETE)
- B. KWIK HUS-EZ (ICC-ES ESR-3056) BY HILTI (MASONRY)
- C. TITEN HD (ICC-ES ESR-2713) BY SIMPSON STRONG-TIE (CONCRETE)
- D. TAPCON ANCHORS (ICC-ES ESR-1671) (MASONRY)
- E. POWERS WEDGE BOLT (ICC-ES ESR-1678) (MASONRY)

FASTENERS CONTINUED

- UNDERCUT ANCHORS IN CONCRETE SHALL BE TESTED AND QUALIFIED FOR USE IN ACCORDANCE WITH ACI 355.2 AND ICC-ES AC193. ACCEPTABLE PRODUCTS:
- A. HDA (ICC-ES ESR-1546) BY HILTI (CONCRETE)
- B. TORQ-CUT (ICC-ES ESR-2705) BY SIMPSON STRONG-TIE (CONCRETE)
- . POWDER ACTUATED FASTENERS IN CONCRETE/CMU SHALL BE TESTED AND QUALIFIED FOR USE IN ACCORDANCE WITH ACI 355.2 AND ICC-ES AC193. ACCEPTABLE PRODUCTS:
 - A. X-U (ICC-ES ESR-2269) BY HILTI (CONCRETE/MASONRY)
 - B. POWDER ACTUATED FASTENERS (ICC-ES ESR-2138) BY SIMPSON STRONG TIE (CONCRETE/MASONRY)
- ADHESIVE ANCHORS IN CONCRETE/CMU SHALL BE TESTED AND QUALIFIED FOR USE IN ACCORDANCE WITH ACI 355.4 AND ICC-ES AC308. ACCEPTABLE
 - A. HIT-RE 500-SD (ICC-ES ESR-2322) BY HILTI (CONCRETE)
 - B. HIT-HY 150 MAX (ICC-ES ESR-1967) BY HILTI (MASONRY)
 - C. SET-XP (ICC-ES ESR-2508) BY SIMPSON STRONG-TIE (CONCRETE)
 - D. SET (ICC-ES ESR-1772) BY SIMPSON STRONG-TIE (MASONRY)
- 10. J-BOLTS SHALL BE FABRICATED FROM ASTM A36/A307 ROD. BOLTS, NUTS AND WASHERS SHALL BE GALVANIZED. EXPANSION BOLTS/SLEEVE ANCHORS SHALL NOT BE SUBSTITUTED FOR J-BOLTS WITHOUT PRIOR WRITTEN APPROVAL BY STRUCTURAL ENGINEER.
- 11. HEADED ANCHOR RODS SHALL BE FABRICATED FROM ASTM F1554 MATERIAL, FY=36 KSI
- 12. SUBSTITUTION REQUESTS FOR PRODUCTS LISTED ABOVE SHALL BE SUBMITTED BY THE CONTRACTOR TO THE STRUCTURAL ENGINEER ALONG WITH CALCULATIONS THAT ARE PREPARED & SEALED BY A REGISTERED PROFESSIONAL ENGINEER. THE CALCULATIONS SHALL DEMONSTRATE THAT THE SUBSTITUTED PRODUCT IS CAPABLE OF ACHIEVING THE PERTINENT EQUIVALENT PERFORMANCE VALUES OF THE SPECIFIED PRODUCT USING THE APPROPRIATE DESIGN PROCEDURE AND/OR STANDARDS. SUBSTITUTED ANCHORS SHALL HAVE A VALID CURRENT EVALUATION (ICC-ES OR IAPMO-ES) REPORT.

ROUGH CARPENTRY SPECIFICATIONS AND NOTES

- ROUGH CARPENTRY SHALL COMPLY WITH THE PROVISIONS OF THE 2009 EDITION OF THE INTERNATIONAL BUILDING CODE.
- 2. ALL LUMBER USED FOR LOAD SUPPORTING PURPOSES SHALL BE IDENTIFIED BY THE GRADE MARK OF AN APPROVED LUMBER GRADING OR INSPECTION BUREAU OR
- 3. ALL LUMBER SHALL BE PRESERVATIVELY TREATED AND SHALL BEAR AN APPROVED AWPB QUALITY MARK. THE QUALITY MARK SHALL BE ON A STAMP OR LABEL AFFIXED TO THE PRESERVATIVE-TREATED WOOD, AND SHALL INCLUDE THE FOLLOWING INFORMATION:
 - A. IDENTIFICATION OF TREATING MANUFACTURER.
 - B. TYPE OF PRESERVATIVE USED.
 - C. MINIMUM PERSERVATIVE RETENSION (pcf).
 - D. END USE FOR WHICH THE PRODUCT IS TREATED.
 - E. AWPA STANDARD TO WHICH THE PRODUCT WAS TREATED.
- F. IDENTITY OF THE ACCREDITED INSPECTION AGENCY. . FRAMING LUMBER MOISTURE CONTENT SHALL NOT EXCEED 19 PERCENT AT TIME

OF INSTALLATION.

5. MATERIALS FRAMING LUMBER

<u>USE-ITEM</u>	LUMBER SPECIES	MINIMUM GRADE
JOISTS, BEAMS	SOUTHERN PINE	#2
PLANKS	2x6 WOOD COMPOSITE DECKING	SEE MFR REQUIREMENTS

- B. FASTENERS 1. NAILS AND BOLTS SHALL BE STAINLESS STEEL.
- 6. VERTICAL FRAMING MEMBERS SHALL BE CONTINUOUS LENGTH WITHOUT SPLICING. SPLICES IN HORIZONTAL MEMBERS SHALL OCCUR ONLY OVER BEARING POINTS. LAP MEMBERS WHICH BEAR ON PLATES TO PROVIDE FULL BEARING FOR EACH
- STRUCTURAL MEMBERS WHOSE STRENGTH IS IMPAIRED BY IMPROPER CUTTING, DRILLING, OR EXCESSIVE DEFECTS SHALL BE REPLACED OR REINFORCED IN A MANNER ACCEPTABLE TO THE ENGINEER.
- 8. PROVIDE SOLID BLOCKING BETWEEN FLOOR JOISTS AT BEARING LOCATIONS AND AT MID OPENING OF SPANS GREATER THAN 8'-0" OR AS NOTED. BLOCKING TO MATCH
- 9. ALL METAL HANGERS, ETC., SHALL BE STAINLESS STEEL

WOOD COMPOSITE DECKING MATERIAL FOR PLANKS

SIZE OF FRAMING MEMBER.

- NOMINAL SIZE OF WOOD COMPOSITE DECKING MATERIAL FOR PLANKS SHALL BE 2"x6" BOARD.
- 2. WOOD COMPOSITE DECKING BOARD MANUFACTURED BY TREX COMPANY, INC., OR EQUIVALENT COMPOSITE DECKING BOARDS MAY BE USED SUBJECT TO REVIEW AND EVALUATION OF THE ENGINEER.
- 3. WOOD COMPOSITE DECKING SHALL BE INSTALLED ACCORDING TO MANUFACTURER'S SPECIFICATIONS, PROCEDURES AND REQUIREMENTS.
- 4. ALL FASTENERS SHALL BE MADE OF STAINLESS STEEL.
- 5. DECKING SHALL BE DESIGNED AND INSTALLED TO LIMIT BENDING DEFLECTION UNDER TOTAL LOAD TO LESS THAN OR EQUAL TO L/360. DESIGN LIVE LOAD IS
- 6. THE CONTRATOR AND MANUFACTURER SHALL SUBMIT TO THE ENGINEER THE FOLLOWING FOR REVIEW AND EVALUATION:
- A. PRODUCT DATA INCLUDING SPECIFICATIONS, PRODUCT HANDLING, AND INTALLATION INSTRUCTION.



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PROJECT

WALKOVER AT WHITE CAP CIRCLE

SOUTH PADRE ISLAND **TEXAS**

CLIENT CITY OF



SOUTH PADRE ISLAND, **TEXAS**



P: 956-761-3044

MARK	DATE	DESCRIPTION

PROJECT NO.	1065–16
DATE	04-22-20
DRAWN BY	LC
CHECKED BY	BD
SCALE	AS SHOWN
SHEET TITLE	

GENERAL STRUCTURAL NOTES

SHEET NO.

GENERAL STRUCTURAL NOTES

CONCRETE MASONRY

- 1. THE GENERAL CONTRACTOR, PROJECT SUPERINTENDENT, TESTING LABORATORY AND THE MASONRY FOREMAN SHALL MEET WITH THE STRUCTURAL ENGINEER PRIOR TO THE START OF MASONRY WORK TO REVIEW PROJECT REQUIREMENTS AND PROCEDURES.
- 2. AN INDEPENDENT TESTING LAB SHALL VERIFY PLACEMENT OF VERTICAL REINFORCING IN WALLS AND HORIZONTAL REINFORCING IN BOND BEAMS AND LINTELS PRIOR TO PLACEMENT OF GROUT. INDEPENDENT TESTING LAB SHALL PROVIDE CONTINUOUS VISUAL OBSERVATIONS OF GROUTING PROCEDURES, REBAR PLACEMENT, SITE MIXING OF MORTAR, INSTALLATION OF EMBEDED STEEL CONNECTORS, AND GENERAL PLACEMENT OF MASONRY UNITS AND MORTAR JOINTS. INSPECTION REPORTS ARE TO BE GENERATED DAILY BY THE TESTING LAB. INSPECTION SUMMARY REPORTS SHALL BE EMAILED TO THE STRUCTURAL ENGINEER IN ELECTRONIC (PDF) FORMAT.
- 3. ALL CONCRETE MASONRY SHALL BE IN ACCORDANCE WITH THE REQUIREMENTS OF THE LOCAL BUILDING CODES AND THE AMERICAN CONCRETE INSTITUTE (ACI 530-13/ ASCE 5-13/ TMS 402-16). DESIGN IS BASED ON MASONRY COMPRESSIVE STRENGTH (f'm) OF 2,000 PSI.
- 4. HOT AND COLD WEATHER CONSTRUCTION PROCEDURES SHALL BE UTILIZED AS REQUIRED BY THE SPECIFICATIONS AND ACI 530.1.
- 5. HOLLOW CONCRETE MASONRY UNITS SHALL BE DOMESTIC LIGHTWEIGHT MOISTURE CONTROLLED TYPE I UNITS, CONFORMING TO ASTM C-90.
- 6. MASONRY UNITS SHALL HAVE A MINIMUM AVERAGE COMPRESSIVE STRENGTH OF 1,900 PSI (NET AREA) WHEN TESTED IN ACCORDANCE WITH ASTM C-140, "METHODS OF SAMPLING AND TESTING CONCRETE MASONRY UNITS".
- 7. MORTAR PROPORTIONS FOR REINFORCED MASONRY SHALL BE ESTABLISHED PER ASTM C270 PROPORTION SPECIFICATIONS, TYPE S USING MASONRY CEMENT.
- 3. GROUT FOR ALL REINFORCED HOLLOW MASONRY UNIT WALLS SHALL HAVE A MINIMUM COMPRESSIVE STRENGTH OF 3,000 PSI WITH A MAXIMUM 3/8" AGGREGATE. A MID RANGE WATER REDUCING AGENT SUCH AS "POLYHEED" (MASTER BUILDERS) SHALL BE USED. SLUMP TO BE BETWEEN 8 AND 11 INCHES. ALL GROUT SHALL BE PUMPED. PLACING OF GROUT TO FOLLOW AMERICAN CONCRETE INSTITUTE (ACI) RECOMMENDATIONS REGARDING LOW & HIGH LIFT GROUTING. MAXIMUM LIFT OF GROUT SHALL NOT EXCEED 5'-0" UNLESS APPROVED BY THE ENGINEER PRIOR TO START OF GROUTING. GROUT TO BE TESTED BY A QUALIFIED TESTING LABORATORY AT A RATE OF ONE TEST PER 25 CY OF GROUT IN ACCORDANCE WITH ASTM C1019.
- 9. REINFORCING STEEL SHALL CONFORM TO ASTM A-615, GRADE 60. ALL BAR REINFORCING SHALL BE LAPPED 48 BAR DIAMETERS (MIN). BARS SHALL BE PLACED WITHIN 1/2" (CENTERLINE OF BAR TO FACE OF MASONRY) OF LOCATION SHOWN IN STRUCTURAL PLANS. BARS SHALL BE HELD IN POSITION DURING GROUTING WITH BAR POSITIONERS. POSITIONERS SHALL BE LOCATED AT THE BOTTOM AND TOP OF THE WALL AND AT 8 TO 10 FOOT INTERVALS. BARS SPLICED BY NON-CONTACT LAP SPLICES SHALL NOT BE SPACED TRANSVERSELY FARTHER APART THAN ONE-FIFTH THE REQUIRED LENGTH OF LAP NOR MORE THAN 8 INCHES.
- 10. VERTICAL BARS SHALL EXTEND TO THE TOP OF THE PARAPET WALL OR BOND BEAM WHEN A 16" DEEP BEAM IS SPECIFIED. HOOKED DOWELS SHALL BE PROVIDED AT ROOF BOND BEAMS (w/o PARAPETS) LESS THAN 16" DEEP. DOWELS SHALL BE 30" LONG WITH 12" HOOKS.
- 11. ALL EXTERIOR MASONRY WALLS SHALL BE REINFORCED WITH 9 GA. HOT DIPPED GALVANIZED HORIZONTAL WIRE REINFORCEMENT (LADDER TYPE) EMBEDDED IN MORTAR JOINTS AT 16" O.C. NOMINAL WIDTH OF JOINT REINFORCING SHALL EQUAL WALL THICKNESS. (INTERIOR WALLS MAY BE MILL GALVANIZED). WIRE REINFORCEMENT SHALL CONFORM TO ASTM DESIGNATION A-82, AND SHALL BE LAPPED AT LEAST 8" WITH AT LEAST ONE CROSS WIRE WITHIN THE LAP. JOINT REINFORCING SHALL BE INSTALLED IN THE FIRST AND SECOND MORTAR BED JOINTS IMMEDIATELY ABOVE AND BELOW ALL OPENINGS. WIRE REINFORCING SHALL BE DISCONTINUOUS AT CONTROL JOINTS.
- 12. EXTERIOR WALLS SHALL BE BONDED WITH CONCRETE MASONRY UNITS AT BUILDING CORNERS.
- 13. ONE GROUTED #5 BAR SHALL BE PROVIDED AROUND THE PERIMETER OF ALL WALL OPENINGS AND AT BUILDING CORNERS UNLESS NOTED OTHERWISE ON THE STRUCTURAL PLANS.
- 14. NEATLY TOOL INTERIOR AND EXTERIOR JOINTS IN MASONRY TO FORM A SLIGHTLY CONCAVE PROFILE WHEN MORTAR IS THUMBPRINT HARD UNLESS SHOWN OTHERWISE. ALL MORTAR JOINTS SHALL BE TOOLED THE ENTIRE HEIGHT OF WALL.
- 15. BOND BEAMS SHALL BE REINFORCED WITH TWO CONTINUOUS #5 BARS UNLESS NOTED OTHERWISE ON THE STRUCTURAL PLANS. REINFORCING SHALL BE CONTINUOUS AT ALL CORNERS AND INTERSECTING WALLS. (PROVIDE CORNER BARS). WHERE SIDE WALL AND END WALL BOND BEAMS DO NOT COURSE CONTINUE THE LOWER BOND BEAM AROUND THE BUILDING CORNER TO THE FIRST VERTICAL REINFORCED CELL.
- 16. CONTROL JOINTS SHALL BE CONSTRUCTED WITH SLOTTED MASONRY UNITS AND FACTORY MOLDED JOINT FILLER. JOINTS SHALL BE CAULKED WITH AN APPROVED MATERIAL. JOINTS SHALL BE PROVIDED AT MAXIMUM SPACING OF 22 FT. AND AT ALL LOCATIONS WHERE COLUMNS ARE PLACED IN CMU CELLS. (EXTERIOR AND INTERIOR WALLS). JOINT LOCATIONS, IF NOT SHOWN ON PLANS, SHALL BE COORDINATED WITH ARCHITECT.
- 17. CONTROL JOINTS **SHALL NOT** EXTEND THROUGH BOND BEAMS UNLESS INDICATED ON THE STRUCTURAL PLANS.
- 18. CONTROL JOINTS IN CMU WALLS SHALL NOT BE LOCATED CLOSER THAN 2'-0" FROM AN EDGE OF OPENING WITHOUT REVIEW OF STRUCTURAL ENGINEER.
- 19. COLUMNS WHICH EXTEND THROUGH BOND BEAMS SHALL BE WRAPPED WITH 2 LAYERS OF 30# BUILDING PAPER. REINFORCING SHALL BE CONTINUOUS PAST COLUMNS WHEN ADEQUATE CLEARANCE EXISTS.
- 20. LINTELS OVER ALL OPENINGS IN INTERIOR MASONRY PARTITIONS, NOT OTHERWISE COVERED, ARE TO BE OF STANDARD CMU LINTEL BLOCK WITH THICKNESS EQUAL TO WALL THICKNESS. DEPTH SHALL BE 8" FOR OPENINGS UP TO 6'-0", REINFORCED WITH TWO #5's, LOCATED 2-1/2" ABOVE THE BOTTOM EXTERIOR FACE OF THE UNIT.

SPECIAL INSPECTIONS

SPECIAL INSPECTIONS INDEPENDENT OF THE CONTRACTOR, THE ARCHITECT, OR THE ENGINEER, SHALL BE PROVIDED BY A SPECIAL INSPECTOR EMPLOYED BY THE OWNER ACCORDING TO CHAPTER 17 OF THE IBC 2018. THE SPECIAL INSPECTOR SHALL OBSERVE THE WORK FOR CONFORMANCE WITH THE CONTRACT DOCUMENTS. THE SPECIAL INSPECTOR SHALL SEND WRITTEN REPORTS TO THE OWNER, THE ARCHITECT, THE ENGINEER AND THE CONTRACTOR. THE REPORTS SHALL INDICATE IF WORK INSPECTED WAS DONE IN CONFORMANCE WITH THE CONTRACT DOCUMENTS. ALL DISCREPANCIES SHALL BE BROUGHT TO THE IMMEDIATE ATTENTION OF THE CONTRACTOR FOR CORRECTION. IF THE DISCREPANCIES ARE NOT CORRECTED, THE SPECIAL INSPECTOR SHALL BRING THE DISCREPANCIES TO THE ATTENTION OF THE REGISTERED DESIGN PROFESSIONAL IN RESPONSIBLE CHARGE PRIOR TO THE COMPLETION OF THAT PHASE OF THE WORK. THE SPECIAL INSPECTOR SHALL SUBMIT A FINAL SIGNED REPORT STATING THAT THE SPECIAL INSPECTION WORK WAS, TO THE BEST OF THEIR KNOWLEDGE, IN OR NOT IN CONFORMANCE WITH THE DRAWINGS, SPECIFICATIONS AND APPLICABLE WORKMANSHIP PROVISIONS OF THE IBC 2018.

CONTINUOUS OR PERIODIC SPECIAL INSPECTION IS REQUIRED FOR THE FOLLOWING WORK:

REQUIRED VERIFICATION AND INSPECTION OF SOILS

The College of the Co					
VERIFICATION AND INSPECTION TASK	CONTINUOUS DURING TASK LISTED	PERIODICALLY DURING TASK LISTED			
VERIFY EXCAVATIONS ARE EXTENDED TO PROPER DEPTH AND HAVE REACHED PROPER MATERIAL		х			
PERFORM CLASSIFICATION AND TESTING OF SELECT FILL MATERIALS		х			
VERIFY USE OF PROPER MATERIALS, DENSITIES AND LIFT THICKNESSES DURING PLACEMENT AND COMPACTION OF SELECT FILL	×				
PRIOR TO PLACEMENT OF SELECT FILL, OBSERVE SUBGRADE AND VERIFY THAT SITE HAS BEEN PREPARED PROPERLY		х			

REQUIRED VERIFICATION AND INSPECTION OF PIER FOUNDATIONS

VERIFICATION AND INSPECTION TASK	CONTINUOUS DURING TASK LISTED	PERIODICALLY DURING TASK LISTED
OBSERVE DRILLING OPERATIONS AND MAINTAIN COMPLETE AND ACCURATE RECORDS OF EACH PIER	X	
VERIFY PLACEMENT LOCATIONS AND PLUMBNESS, CONFIRM PIER DIAMETERS, BELL DIAMETERS (IF APPLICABLE), LENGTHS, EMBEDMENT INTO BEDROCK (IF APPLICABLE) AND ADEQUATE END BEARING STRATA CAPACITY	X	

FOR CONCRETE PIERS, PERFORM ADDITIONAL INSPECTIONS AS REQUIRED FOR CONCRETE CONSTRUCTION

REQUIRED VERIFICATION AND INSPECTION OF CONCRETE CONSTRUCTION

VERIFICATION AND INSPECTION	CONTINUOUS	PERIODIC
INSPECTION OF REINFORCING STEEL, INCLUDING PRESTRESSING TENDONS, AND PLACEMENT		х
INSPECT BOLTS TO BE INSTALLED IN CONCRETE PRIOR TO AND DURING PLACEMENT OF CONCRETE	X	
VERIFY USE OF REQUIRED DESIGN MIX		×
PERFORM SLUMP AND AIR CONTENT TEST, AND DETERMINE THE TEMPERATURE OF THE CONCRETE AT THE TIME OF SAMPLING FRESH CONCRETE FOR MAKING SPECIMENS FOR STRENGTH TESTS PER ACI 318	×	
INSPECTION OF CONCRETE AND SHOTCRETE PLACEMENT FOR PROPER APPLICATION TECHNIQUES	Х	
INSPECTION FOR MAINTENANCE OF SPECIFIED CURING TEMPERATURE AND TECHNIQUES		×
INSPECTION OF PRESTRESSED CONCRETE APPLICATION OF PRESTRESSING FORCES	X	
VERIFICATION OF IN-SITU CONCRETE STRENGTH, PRIOR TO STRESSING OF TENDONS IN POST-TENSIONED CONCRETE AND PRIOR TO REMOVAL OF SHORES AND FORMS FROM BEAMS AND STRUCTURAL SLABS		х
ERECTION OF PRECAST CONCRETE MEMBERS		Х
INSPECT FORMWORK FOR SHAPE, LOCATION AND DIMENSIONS OF THE CONCRETE MEMBER BEING FORMED		×

REQUIRED LEVEL 1 SPECIAL INSPECTION OF MASONRY CONSTRUCTION (OCCUPANCY CATEGORY I, II, III)

(OCCOPANCE CALEGORI I, II, III)		
INSPECTION TASK	CONTINUOUS DURING TASK LISTED	PERIODICALLY DURING TASK LISTED
AS MASONRY CONSTRUCTION BEGINS, THE FOLLOWING SHALL BE VERIFIED TO ENSURE COMPLIANCE:		
PROPORTIONS OF SITE-PREPARED MORTAR		×
PLACEMENT OF MASONRY UNITS AND CONSTRUCTION OF MORTAR JOINTS		х
LOCATION OF REINFORCEMENT, CONNECTORS AND ANCHORAGES		х
THE INSPECTION PROGRAM SHALL VERIFY:		
SIZE AND LOCATION OF STRUCTURAL ELEMENTS		x
TYPE, SIZE AND LOCATION OF ANCHORS, INCLUDING OTHER DETAILS OF ANCHORAGE OF MASONRY TO STRUCTURAL MEMBERS, FRAMES OR OTHER CONSTRUCTION		×
SPECIFIED SIZE, GRADE AND TYPE OF REINFORCEMENT		х
PROTECTION OF MASONRY DURING COLD WEATHER (TEMPERATURE BELOW 40°F) OR HOT WEATHER (TEMPERATURE ABOVE 90°F)		х
PRIOR TO GROUTING, THE FOLLOWING SHALL BE VERIFIED TO ENSURE COMPLIANCE:		
GROUT SPACE IS CLEAN		х
PLACEMENT OF REINFORCEMENT, CONNECTORS AND ANCHORAGES		х
CONSTRUCTION OF MORTAR JOINTS		Х
GROUT PLACEMENT SHALL BE VERIFIED TO ENSURE COMPLIANCE WITH CODE AND CONSTRUCTION DOCUMENT PROVISIONS	×	
PREPARATION OF ANY REQUIRED GROUT SPECIMENS, MORTAR SPECIMENS AND/OR PRISMS SHALL BE OBSERVED	x	
COMPLIANCE WITH REQUIRED INSPECTION PROVISIONS OF THE CONSTRUCTION DOCUMENTS AND THE APPROVED SUBITTALS SHALL BE VERIFIED		х
	l	<u> </u>

REQUIRED VERIFICATION AND INSPECTION OF ANCHORS

VERIFICATION AND INSPECTION	CONTINUOUS	PERIODIC
CAST-IN-PLACE, POST-INSTALLED, MECHANICAL AND EPOXY SET ANCHORS: AS APPLICABLE, THE INSPECTION PROGRAM SHALL VERIFY THE ANCHOR TYPE, EMBEDMENT, TIGHTENING TORQUE, DIMENSIONS, HOLE DEPTH & DIAMETER AND CLEANOUT, EPOXY MIXING AND PLACEMENT PROCEDURES IN ACCORDANCE WITH THE CONTRACT DOCUMENTS AND THE CURRENT ICC-ES EVALUATION REPORT	FREQUENCY OF INSPECTION SHACCORDANCE CURRENT ICC—EVALUATION REPORTION REQUIREMENTS ANCHOR SUBS WHICHEVER IS STRINGENT	HALL BE IN WITH THE ES EPORT, OR CHAL THE TRATE,

REQUIRED VERIFICATION AND INSPECTION OF STEEL CONSTRUCTION


VERIFICATION AND INSPECTION	CONTINUOUS	PERIODIC
MATERIAL VERIFICATION OF HIGH-STRENGTH BOLTS, NUTS AND WASHERS		Х
INSPECTION OF HIGH STRENGTH BOLTING		Х
INSPECTION OF WELDING:		
COMPLETE AND PARTIAL PENETRATION GROOVE WELDS	Х	
MULTIPASS FILLET WELDS	Х	
SINGLE-PASS FILLET WELDS		Х
FLOOR AND ROOF DECK WELDS		X
INSPECTION OF STEEL FRAME JOINT DETAILS FOR COMPLIANCE WITH APPROVED CONSTRUCTION DOCUMENTS		X



GREEN, RUBIANO & ASSOCIATES

CONSULTING STRUCTURAL ENGINEERS

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PROJECT

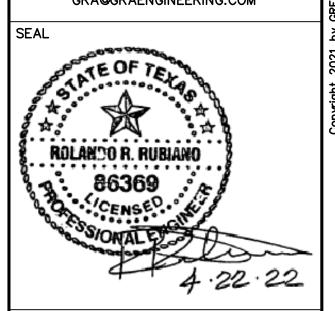WALKOVER AT WHITE CAP CIRCLE

SOUTH PADRE ISLAND, TEXAS

CLIENT

CITY OF SOUTH PADRE ISLAND



SOUTH PADRE ISLAND, TEXAS

P: 956-761-3044 F: 956-761-3898




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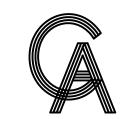
PROJECT NO.	1065–16
DATE	04-22-202
DRAWN BY	LC
CHECKED BY	BD
SCALE	AS SHOWN

SHEET TITLE

GENERAL STRUCTURAL NOTES

SHEET NO.



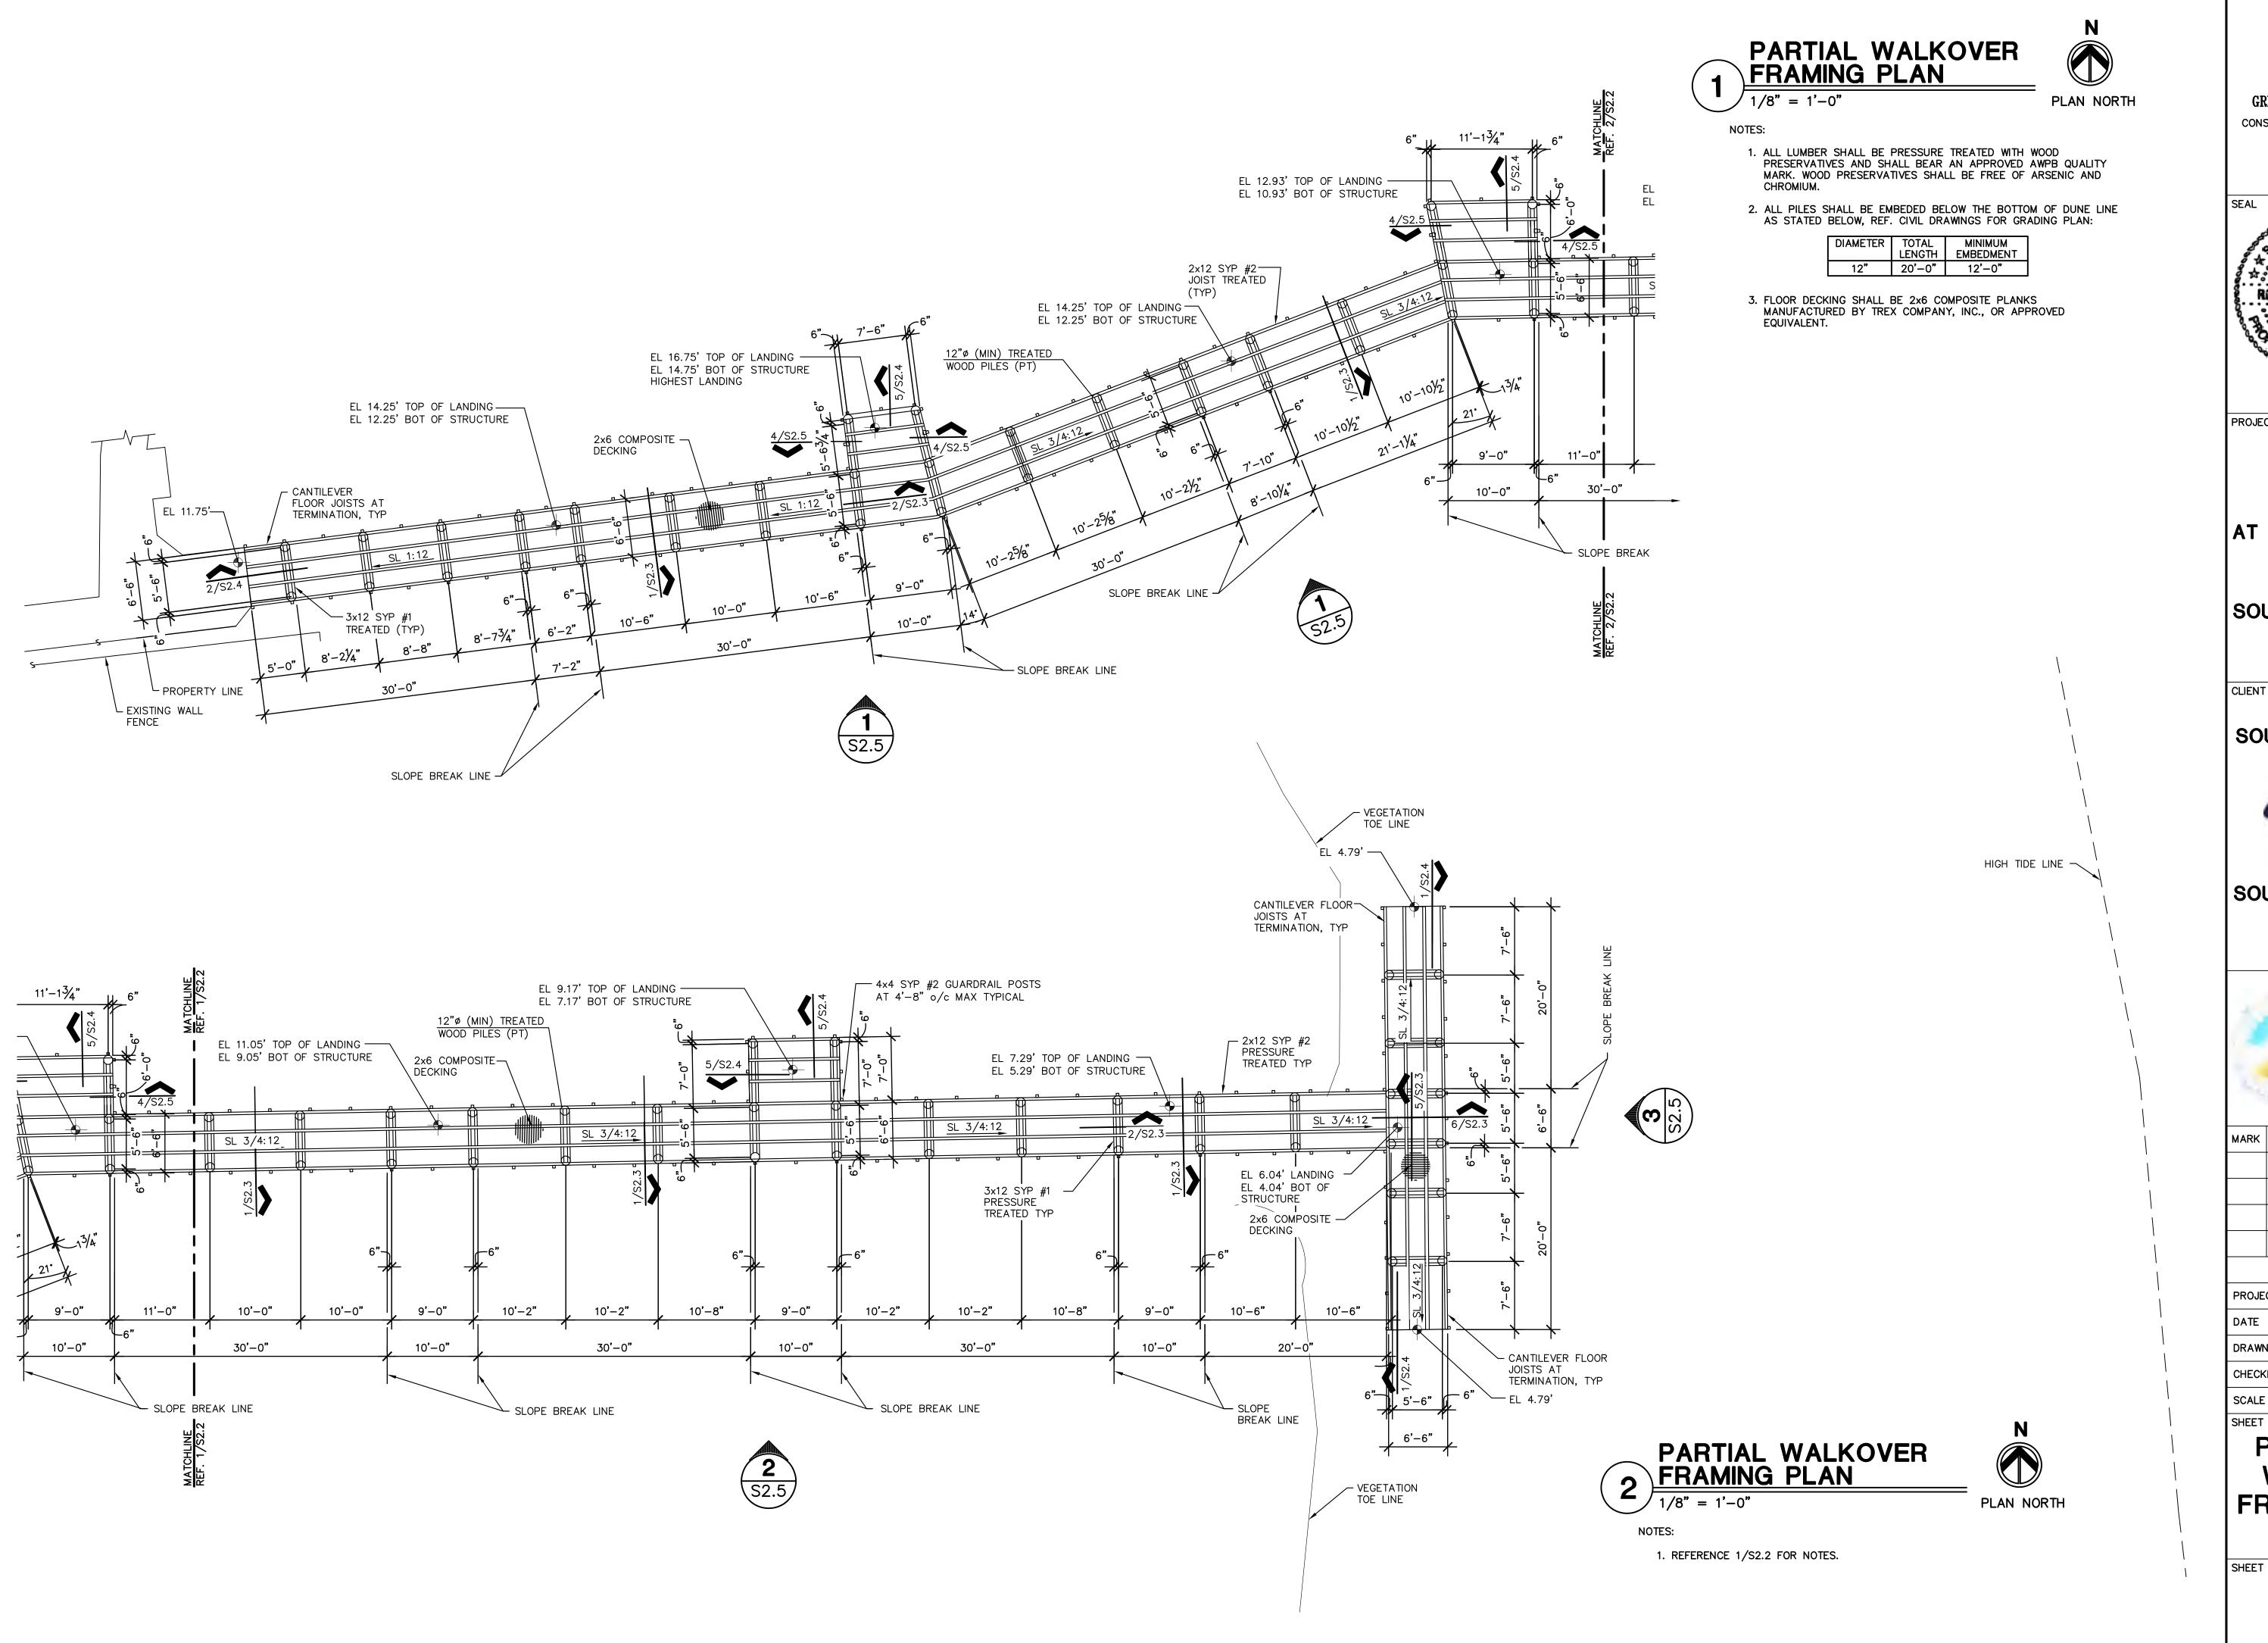

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SEAL



PROJECT

WALKOVER AT WHITE CAP CIRCLE

SOUTH PADRE ISLAND, **TEXAS**

CLIENT

CITY OF SOUTH PADRE ISLAND



SOUTH PADRE ISLAND, **TEXAS**

> P: 956-761-3044 F: 956-761-3898



DATE




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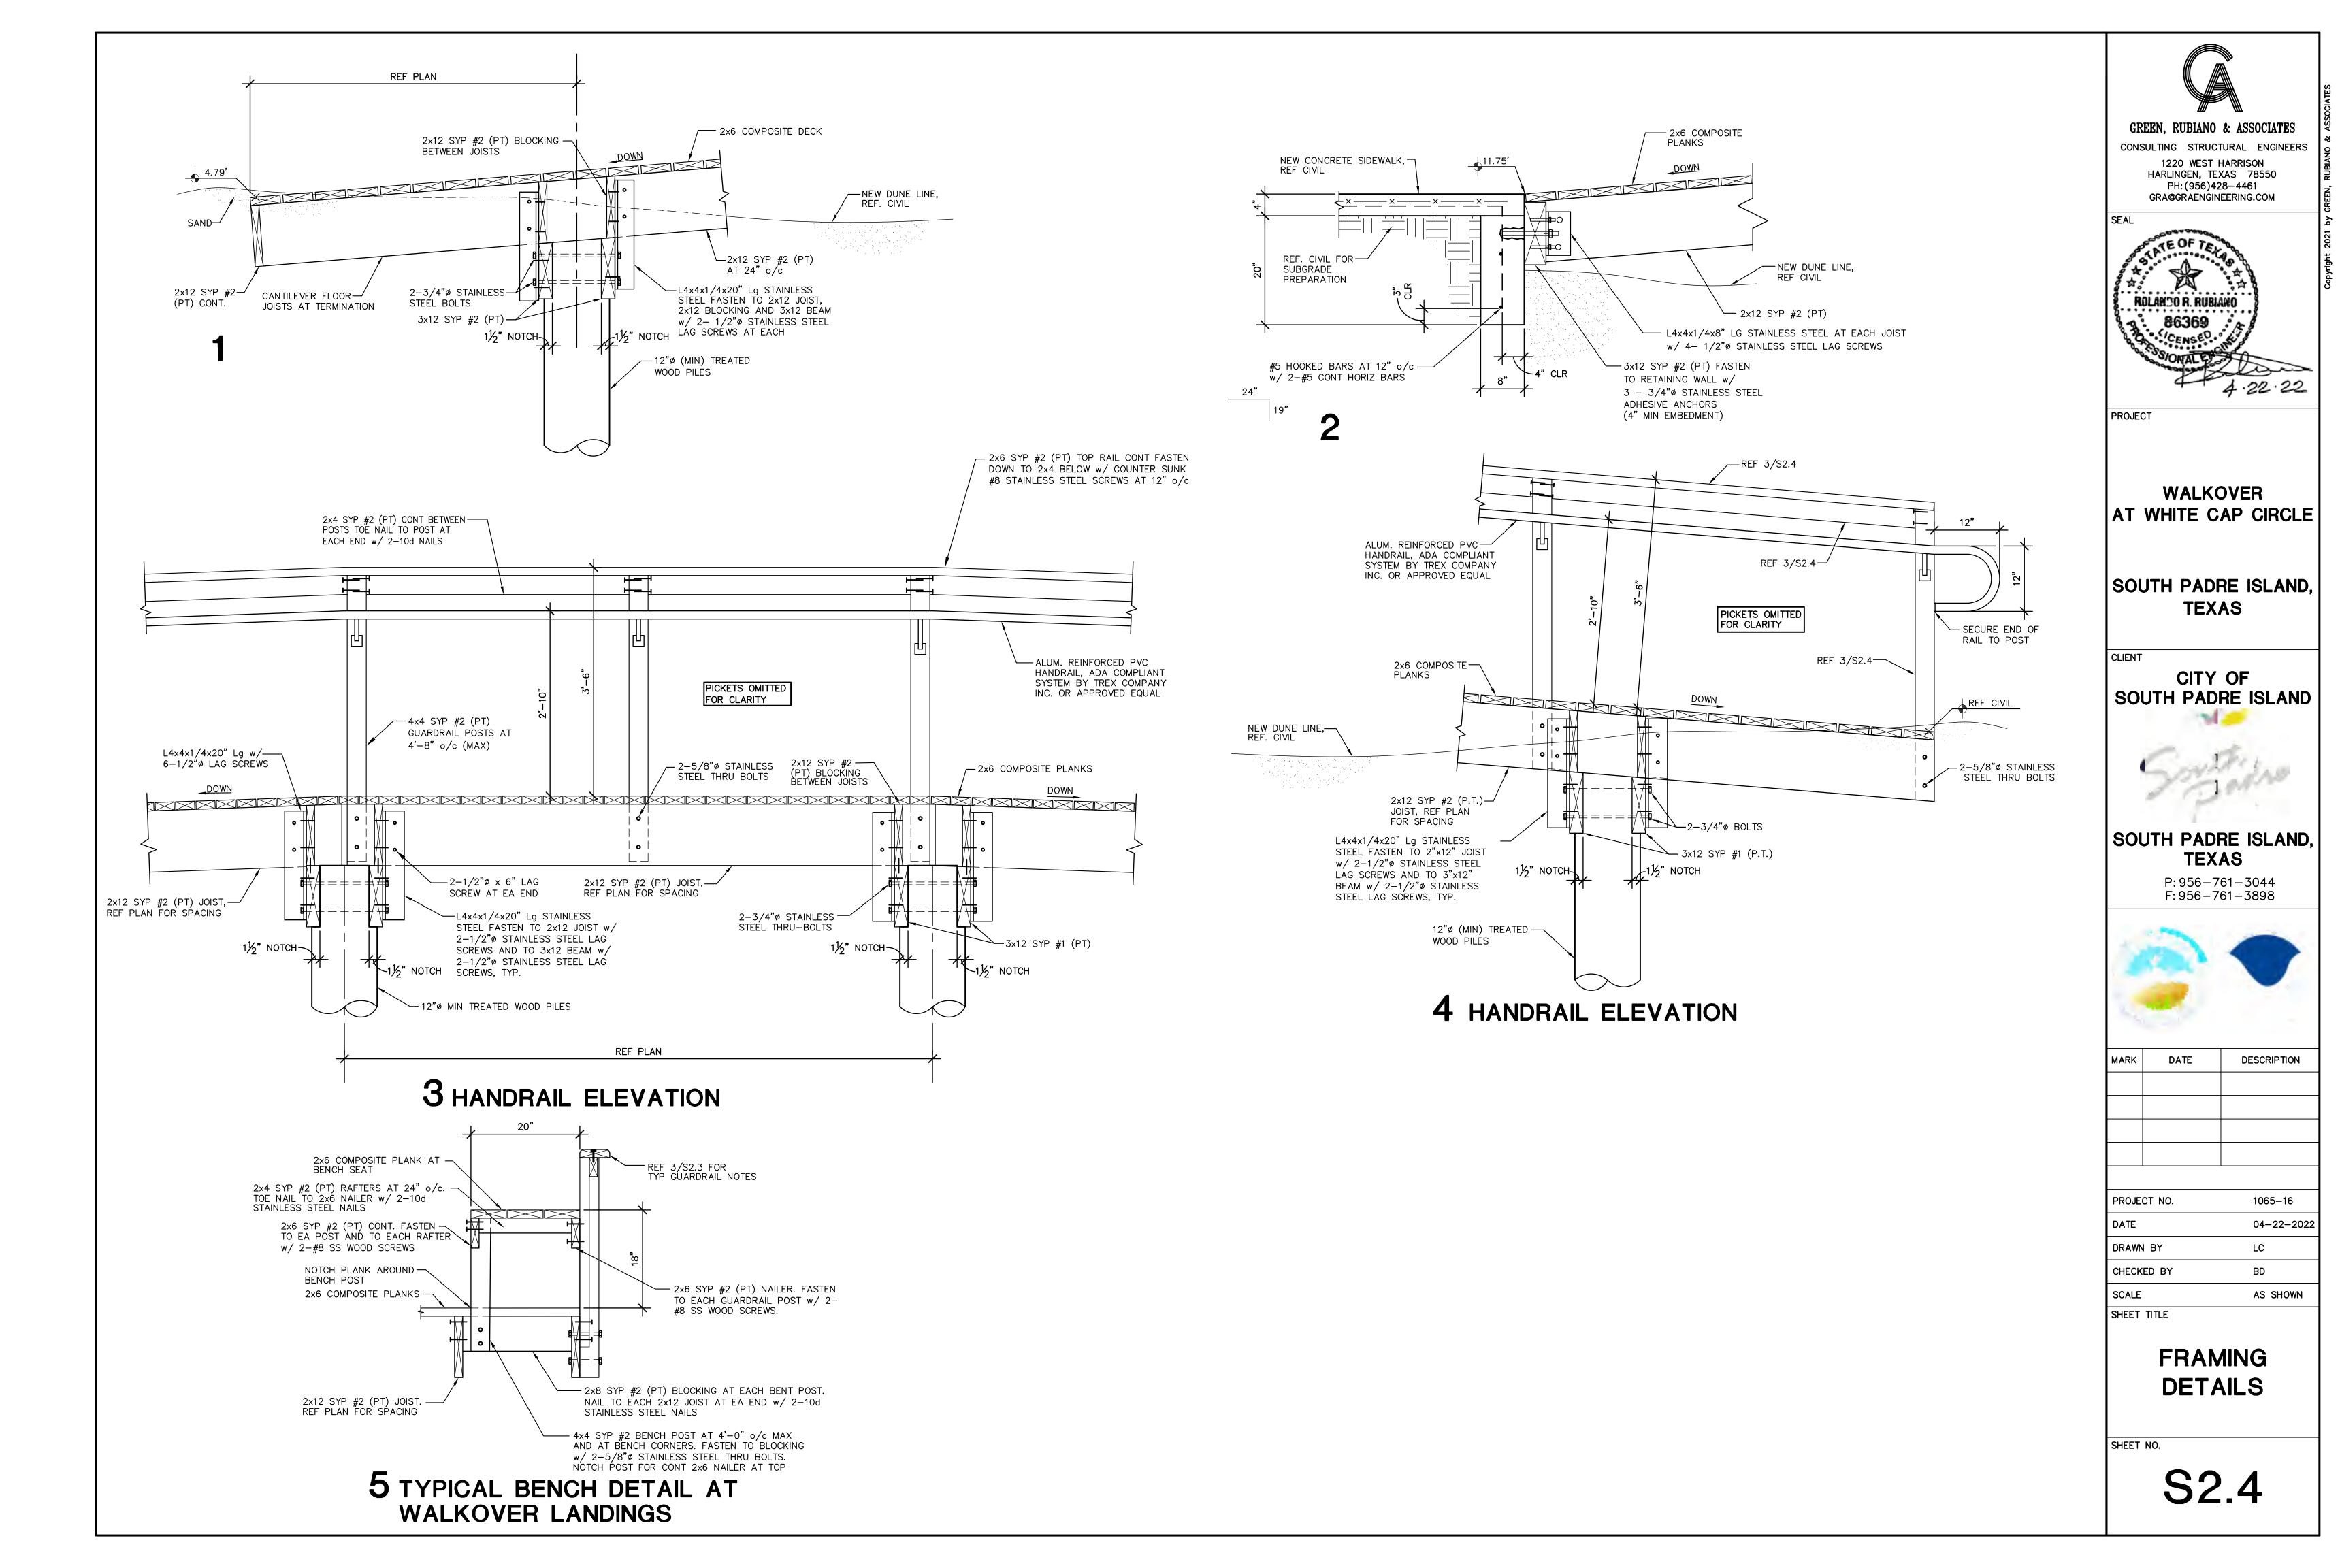
04-22-2022
LC
BD
AS SHOWN


SHEET TITLE

PEDESTRIAN WALKOVER FRAMING PLAN

SHEET NO.



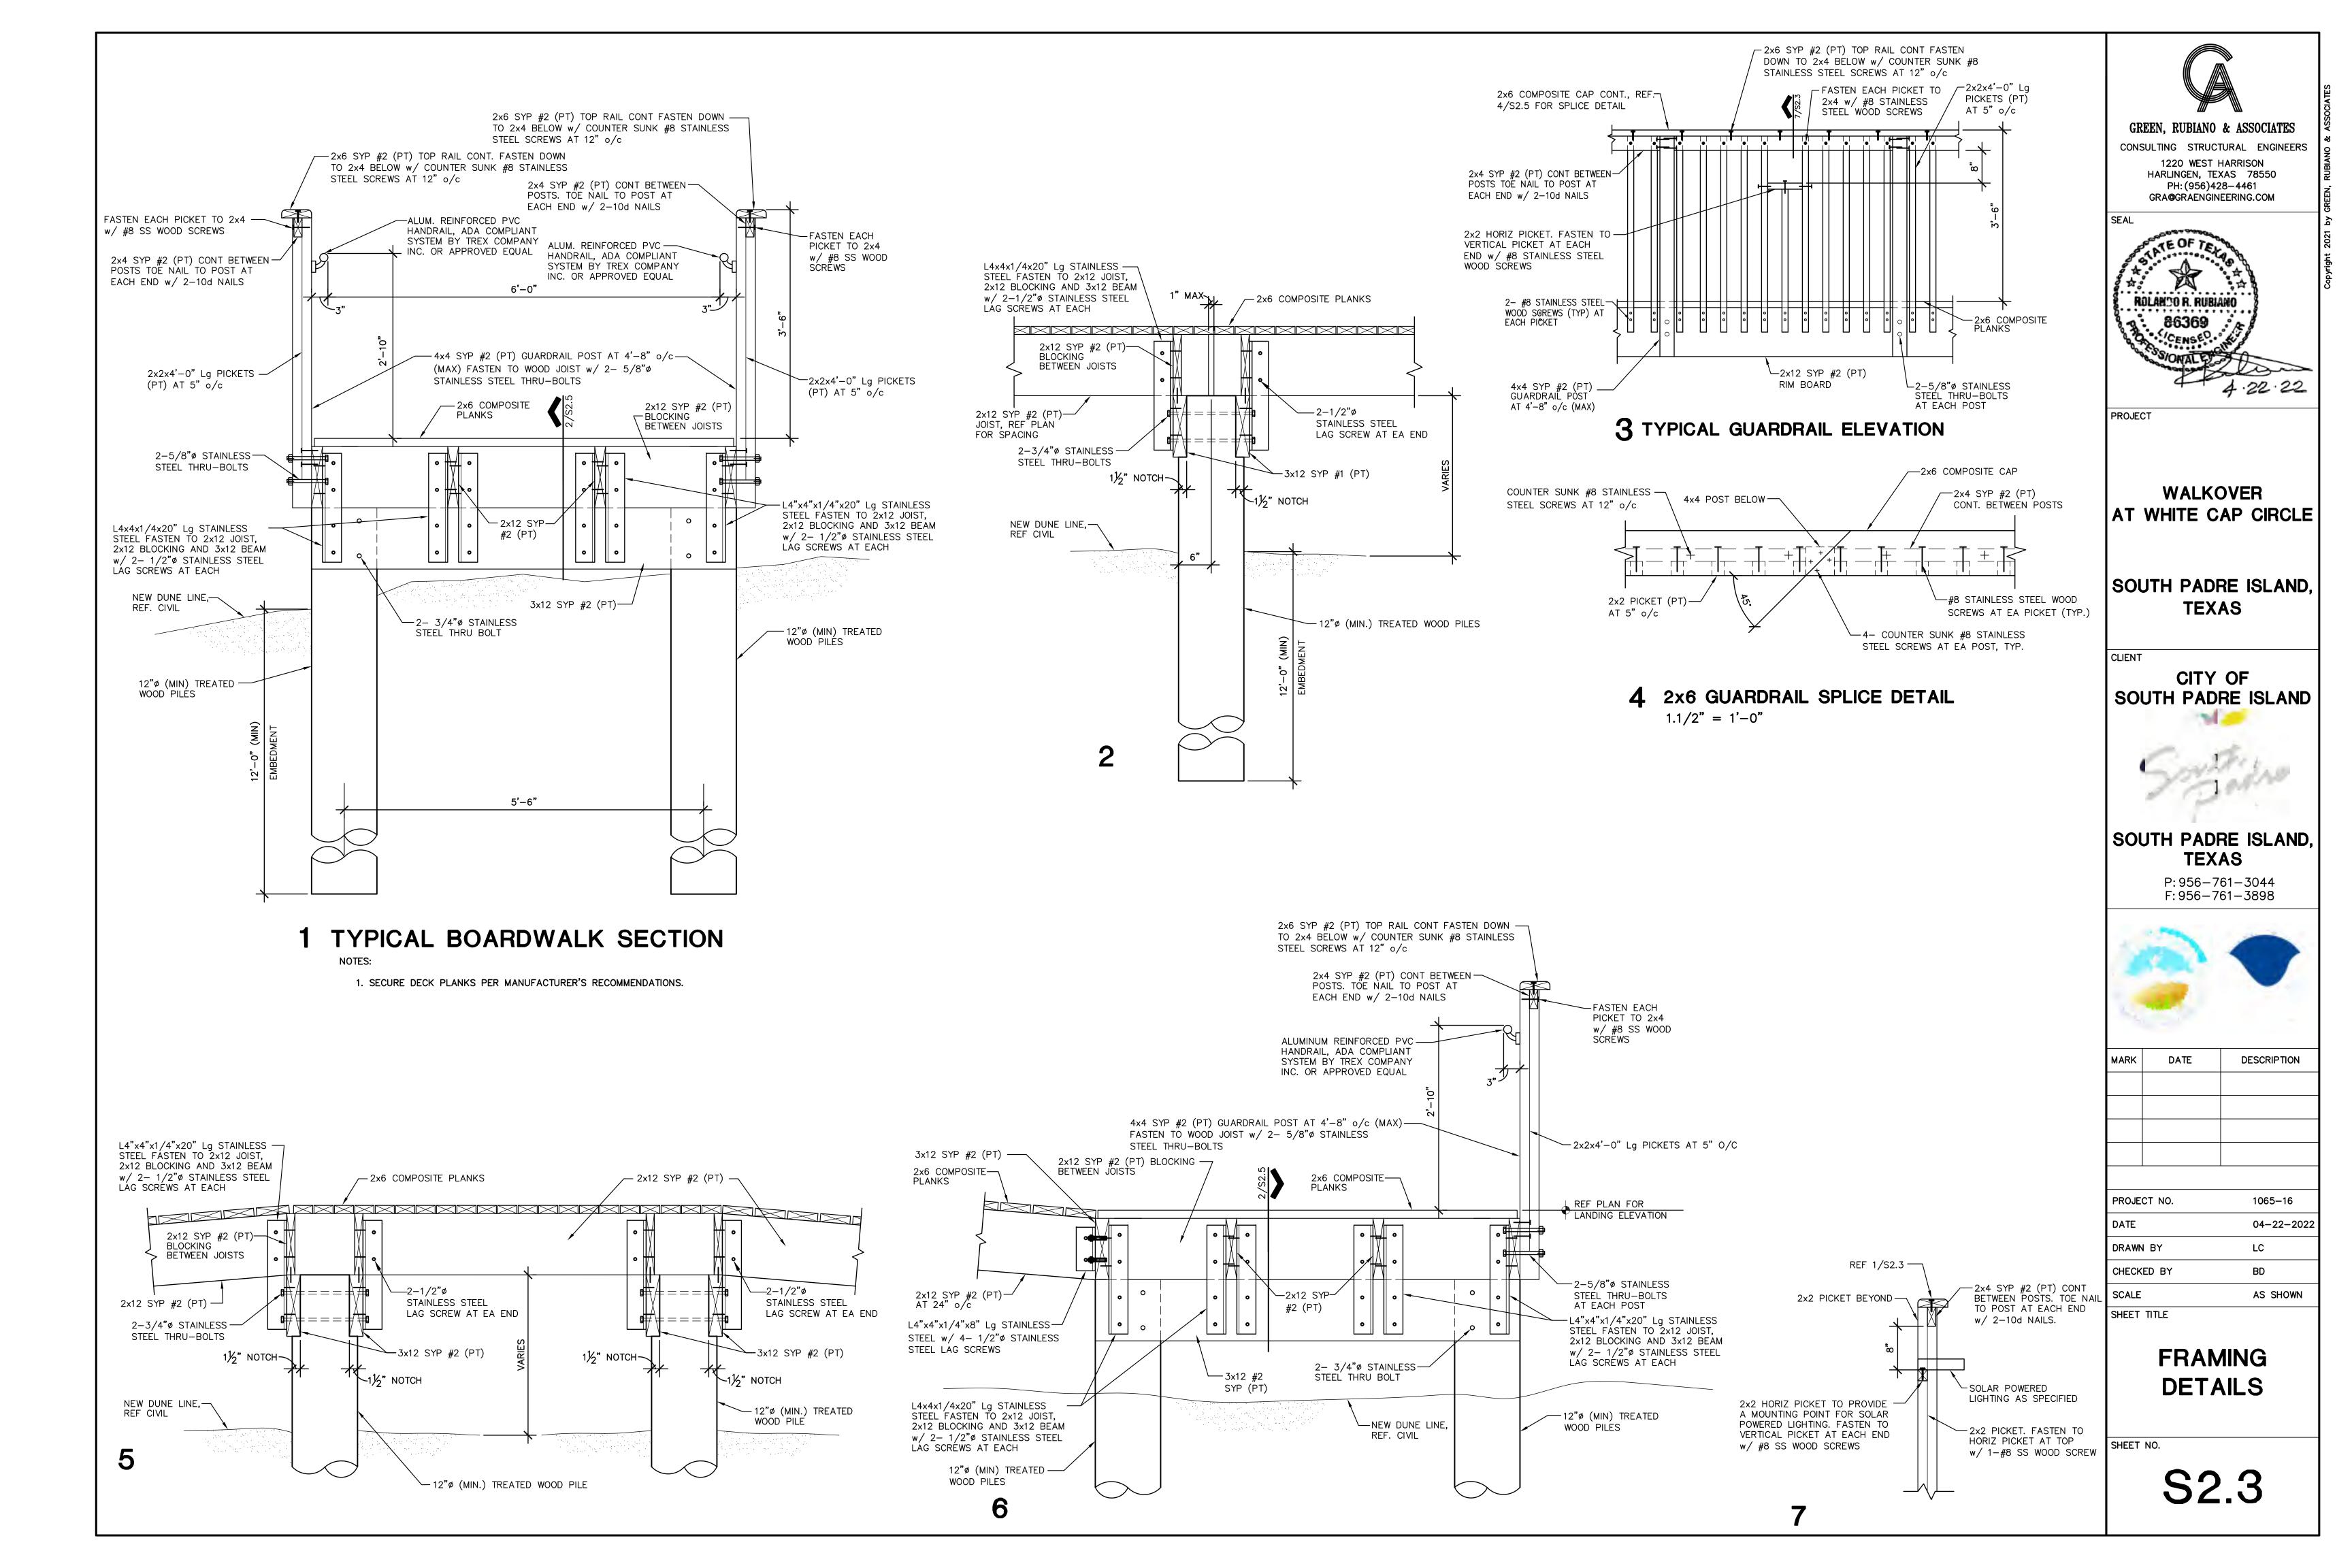


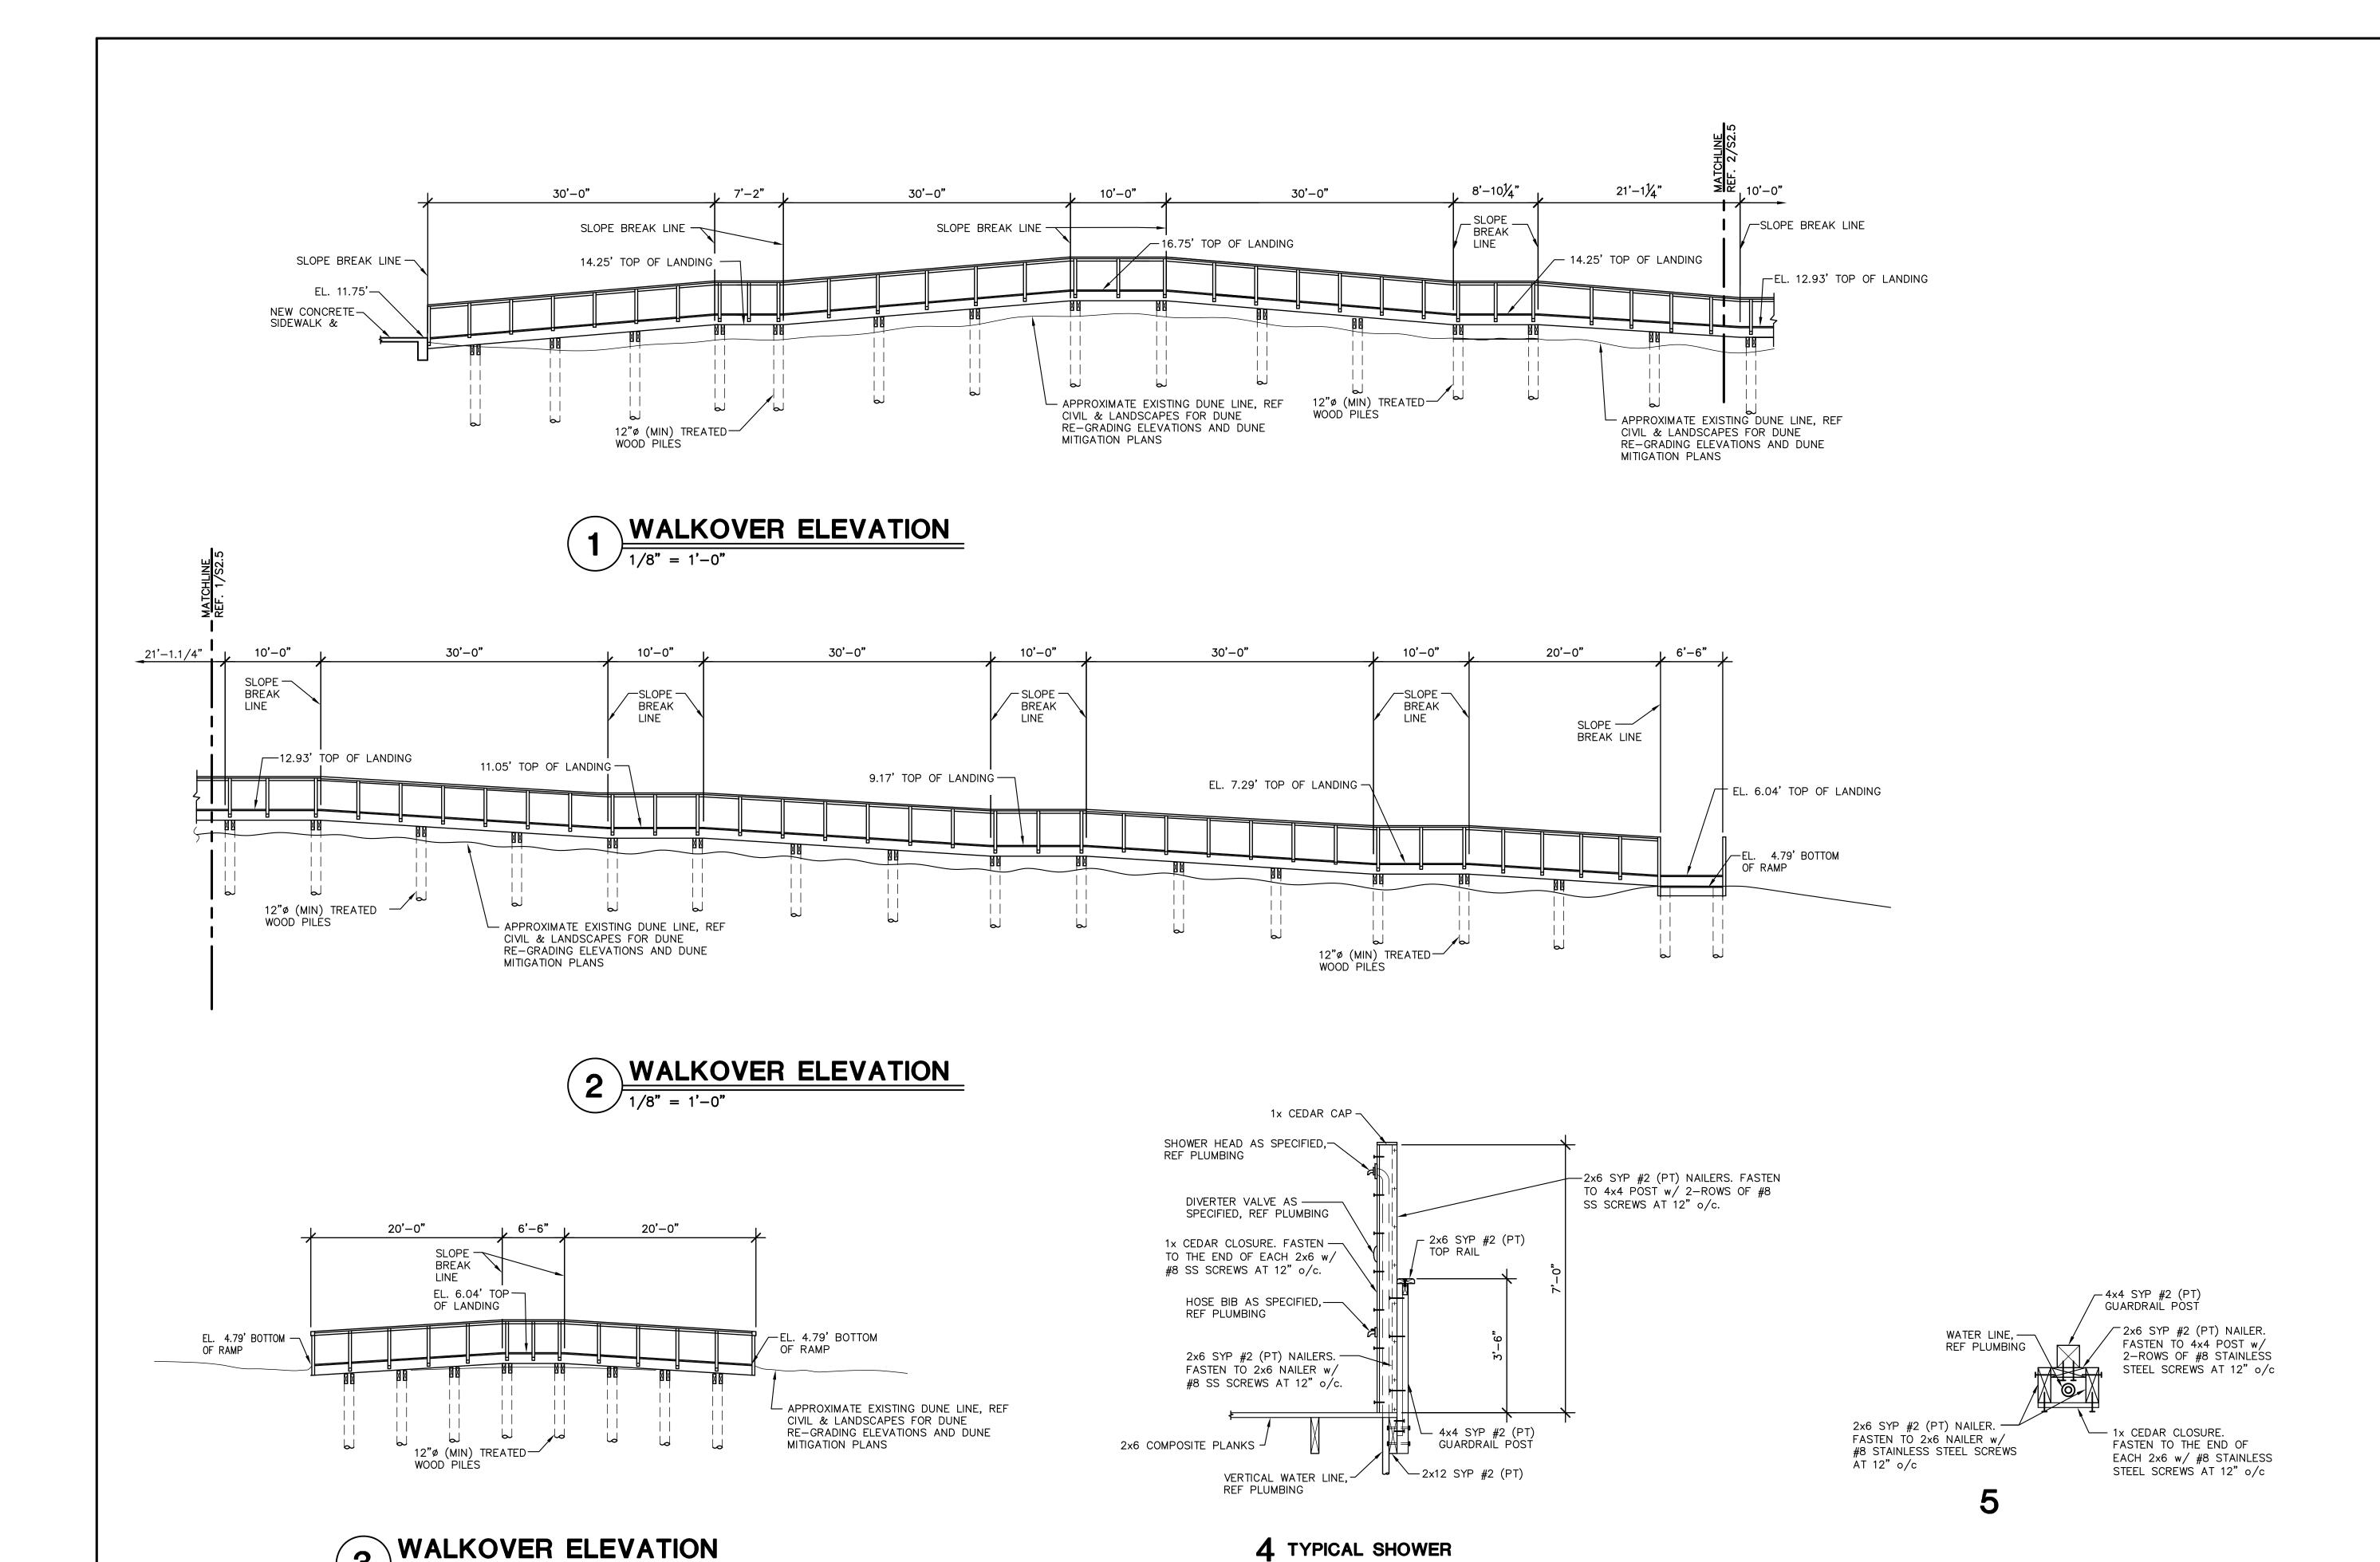

SUPPORT FRAMING DETAIL

GREEN, RUBIANO & ASSOCIATES

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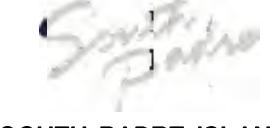
PROJECT

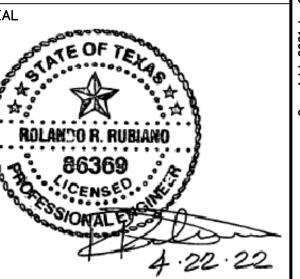WALKOVER AT WHITE CAP CIRCLE

SOUTH PADRE ISLAND, **TEXAS**

CLIENT

CITY OF SOUTH PADRE ISLAND



SOUTH PADRE ISLAND, **TEXAS**

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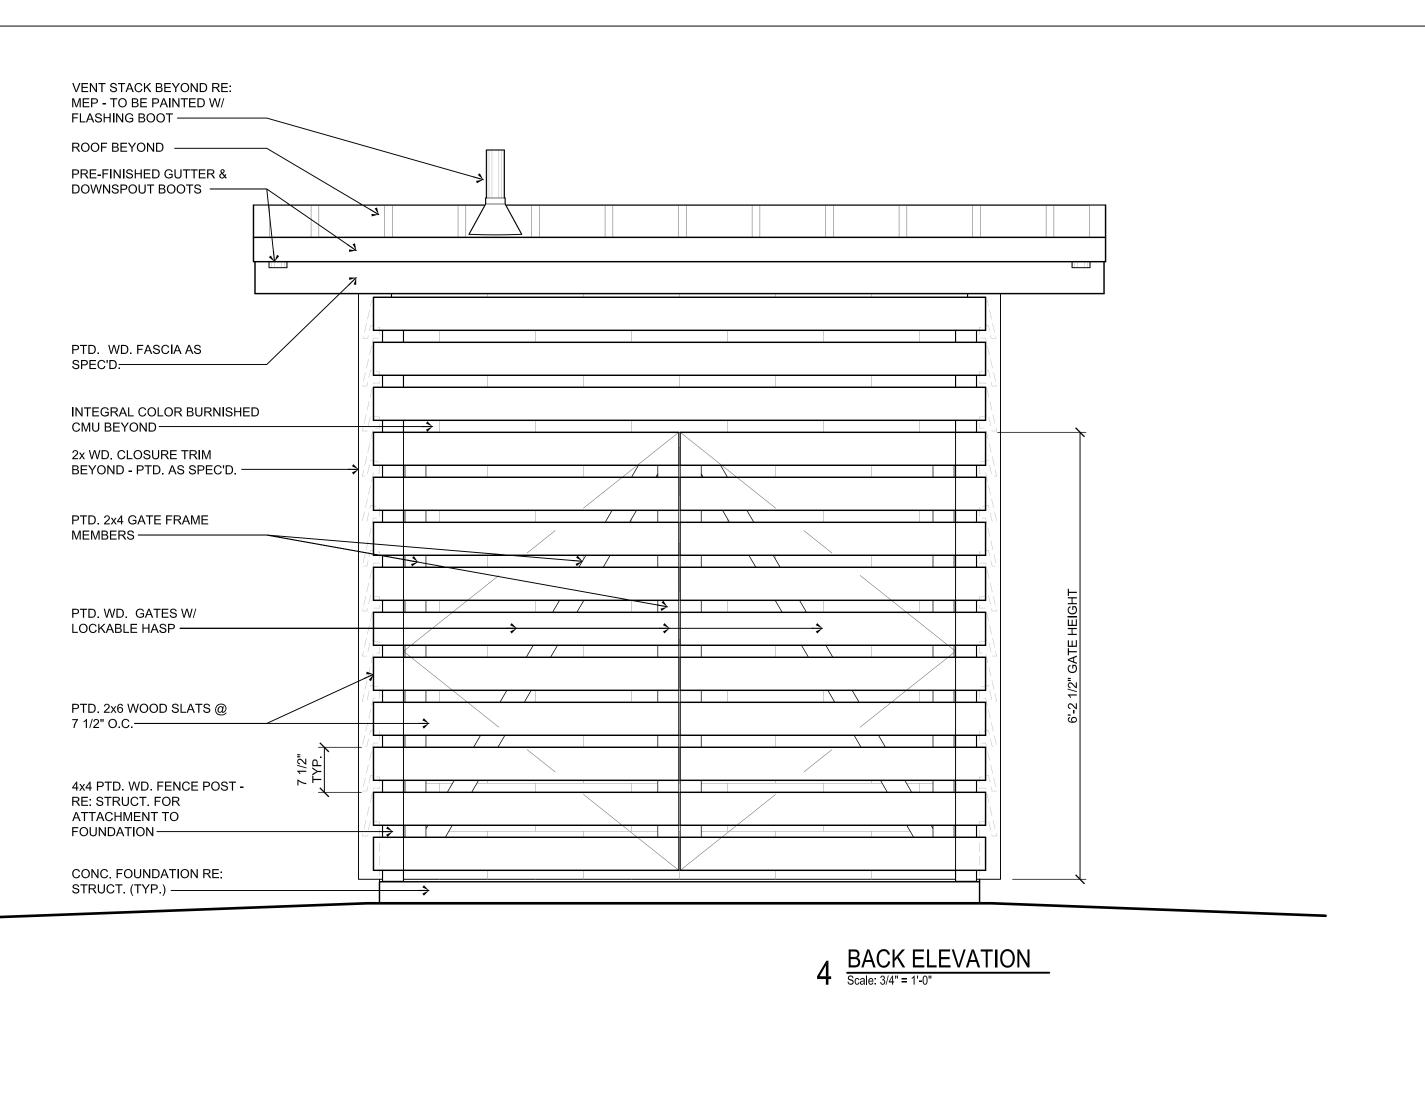



MARK	DATE	DESCRIPTION	

PROJECT NO.	1065–16
DATE	04-22-2022
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SCALE	AS SHOWN

SHEET TITLE WALKOVER **ELEVATIONS**

SHEET NO.



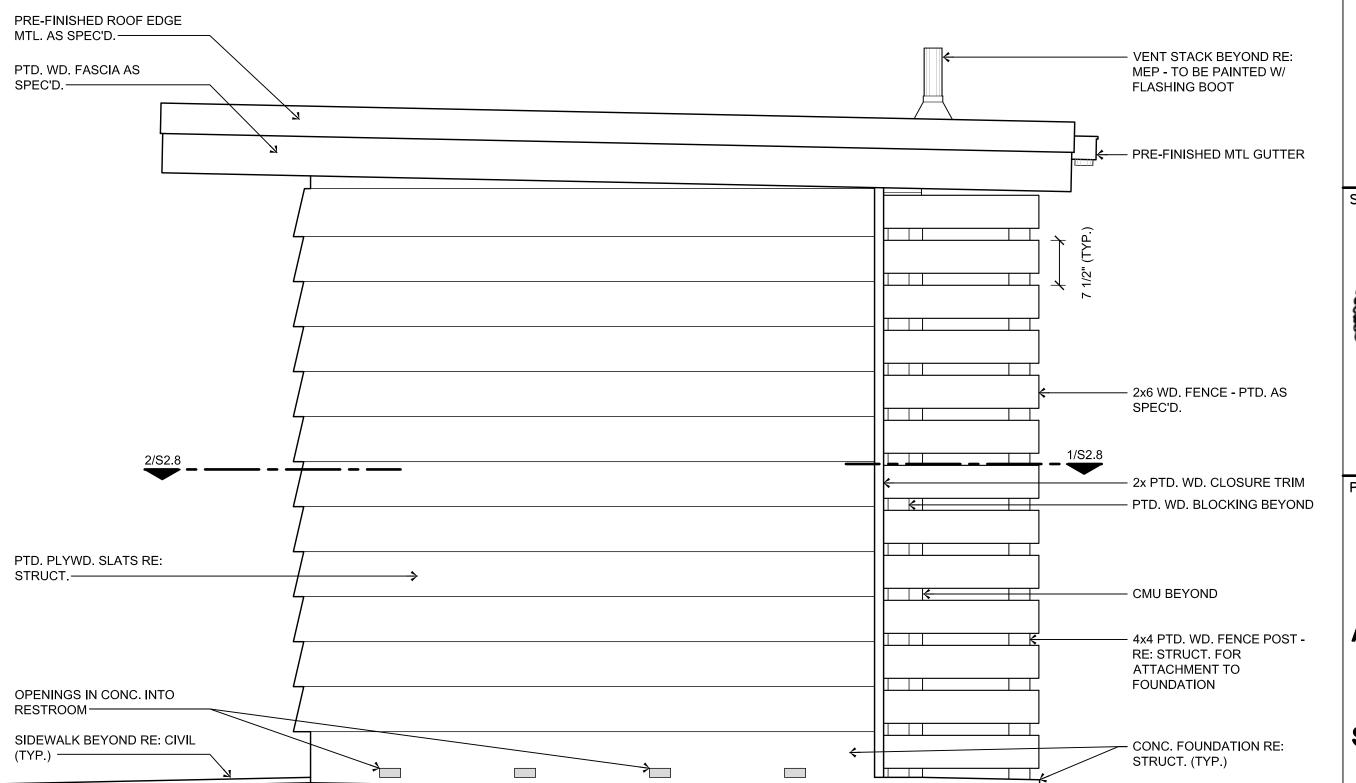

3 SIDE ELEVATION
Scale: 3/4" = 1'-0"



SEAL ROLANDO R. RUBIANO

PROJECT

WALKOVER AT WHITE CAP CIRCLE

SOUTH PADRE ISLAND, **TEXAS**

CLIENT CITY OF SOUTH PADRE ISLAND



TEXAS P: 956-761-3044 F: 956-761-3898







PROJECT NO.	1065–16
DATE	04-22-2022
DRAWN BY	LC
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SCALE	AS SHOWN

SHEET TITLE

MARK


RESTROOM PLAN AND **ELEVATIONS**

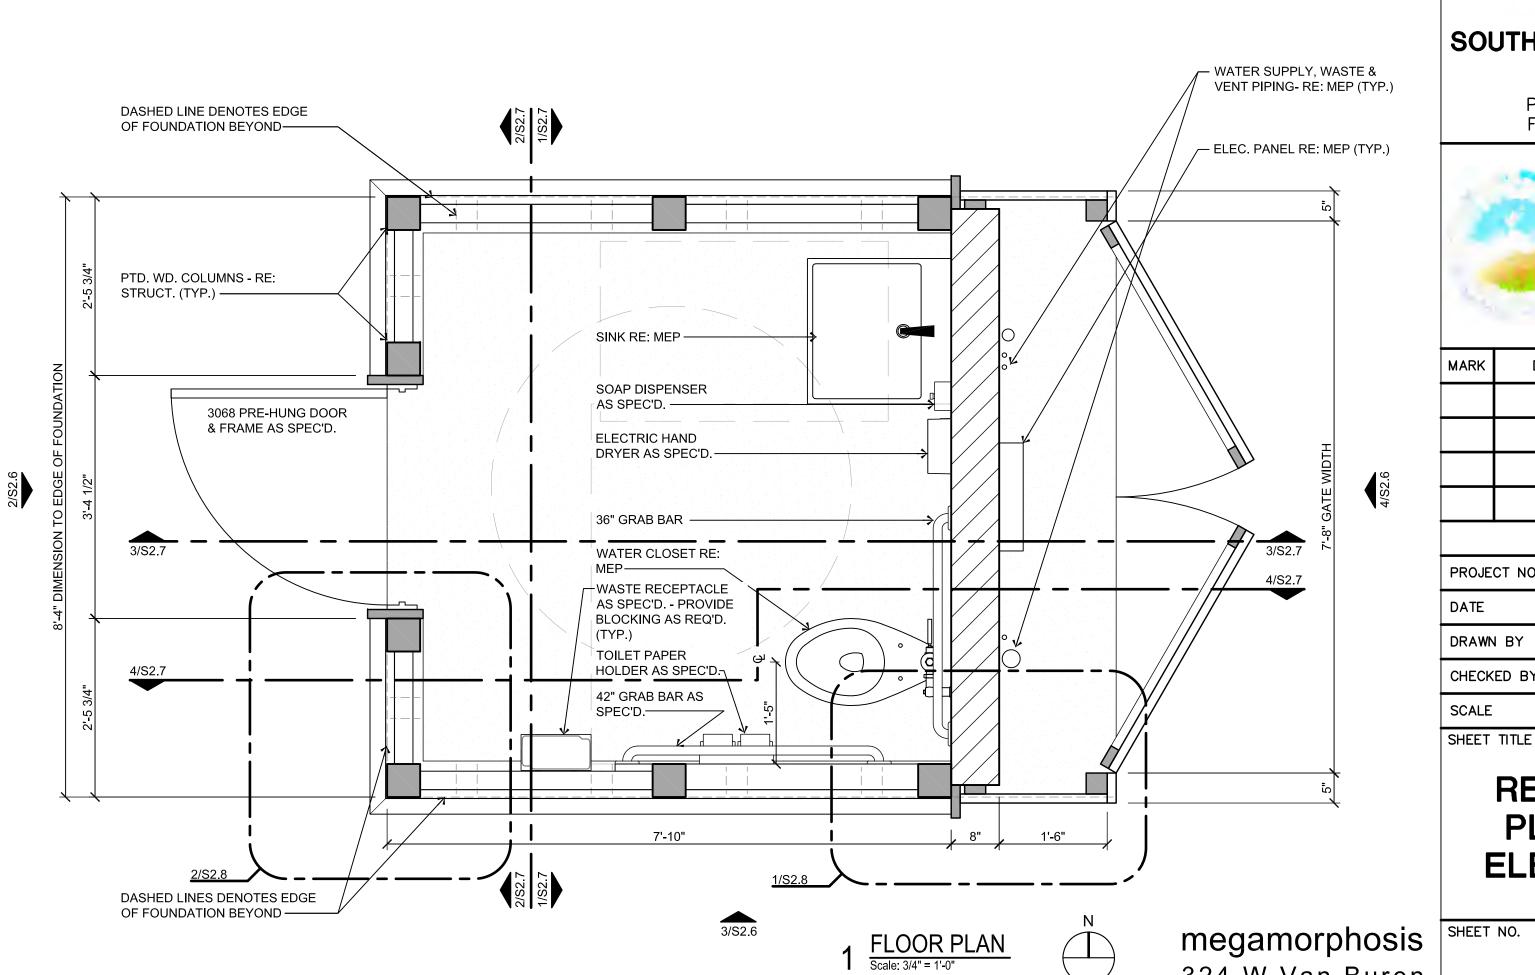


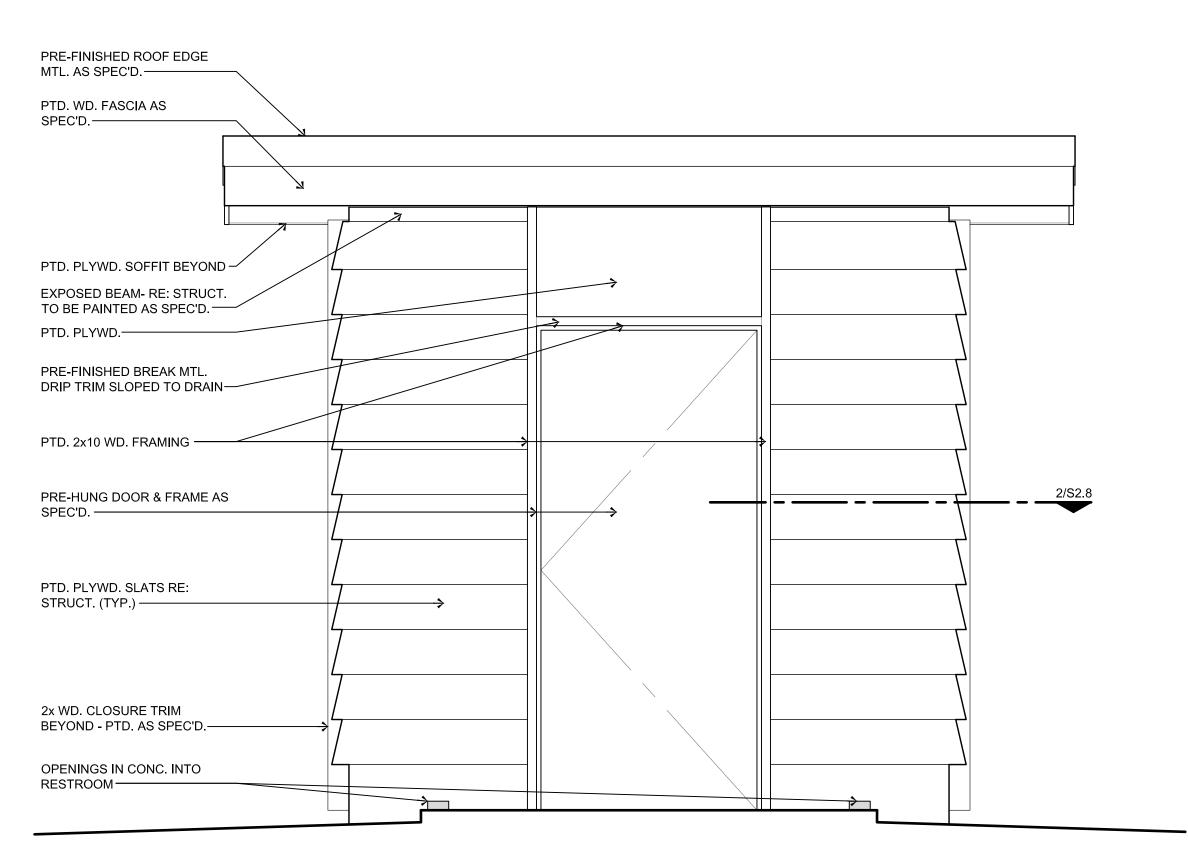


2 FRONT ELEVATION
Scale: 3/4" = 1'-0"


324 W Van Buren Harlingen, TX 78550 956.428.1779

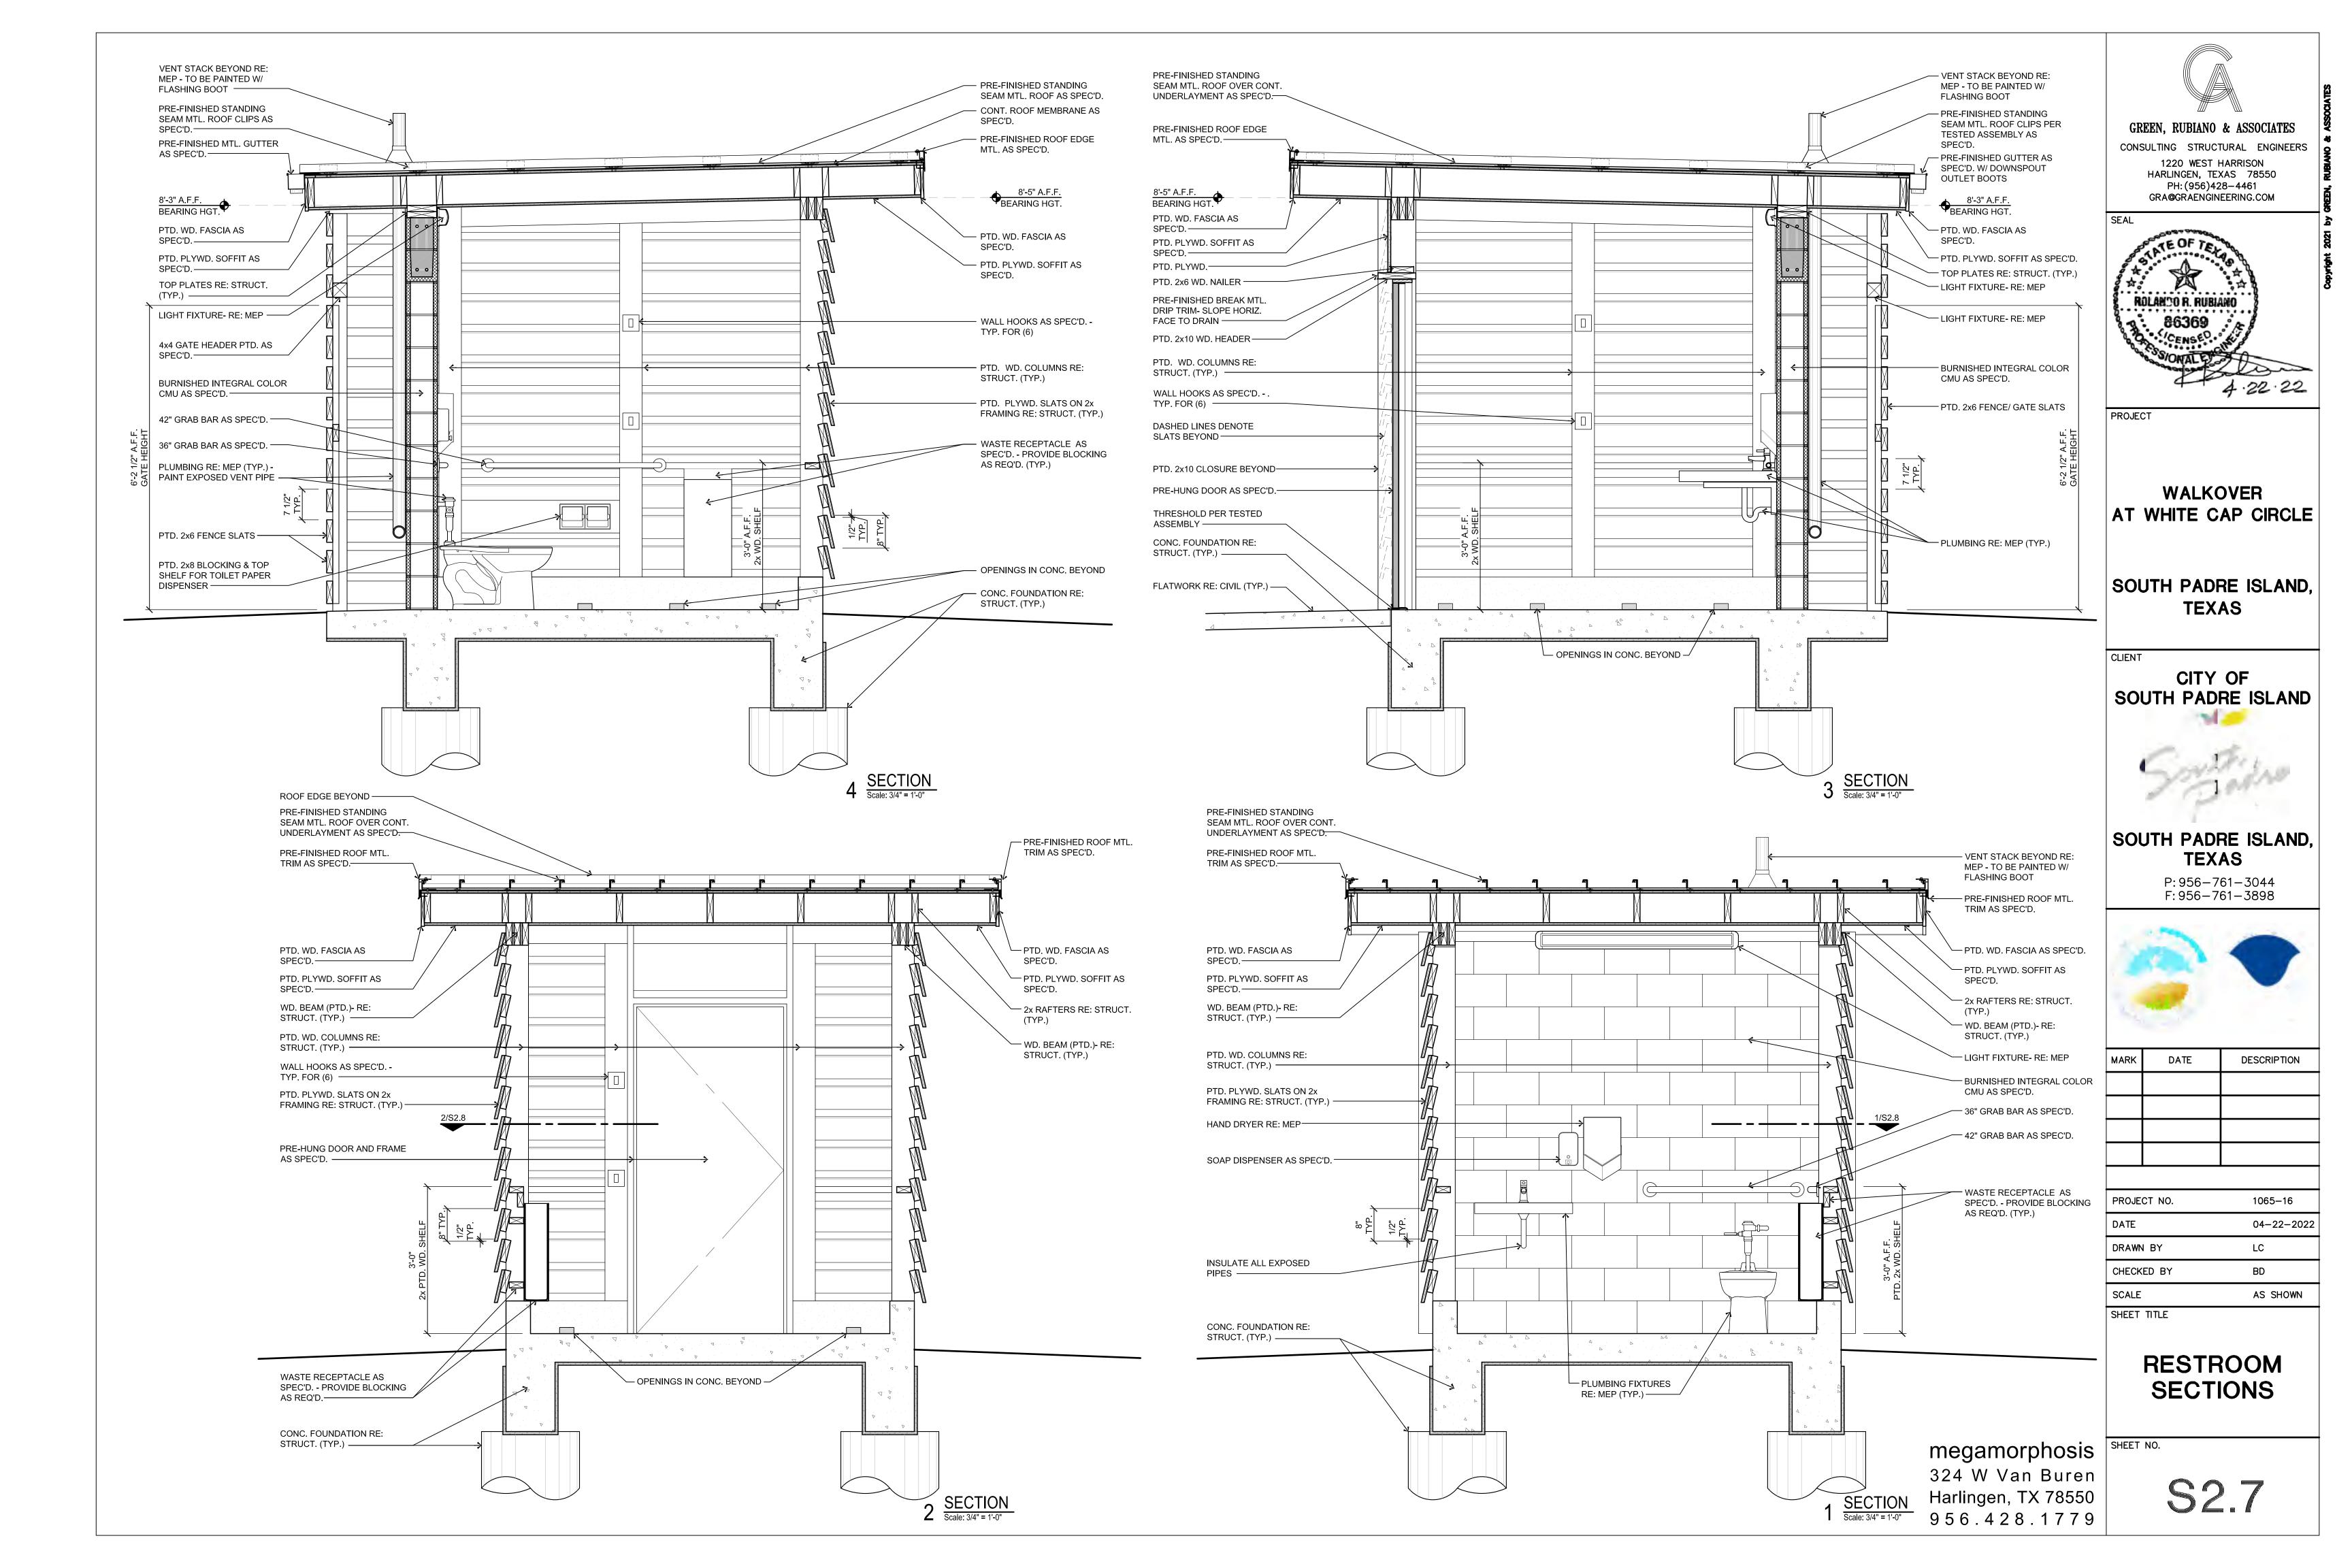

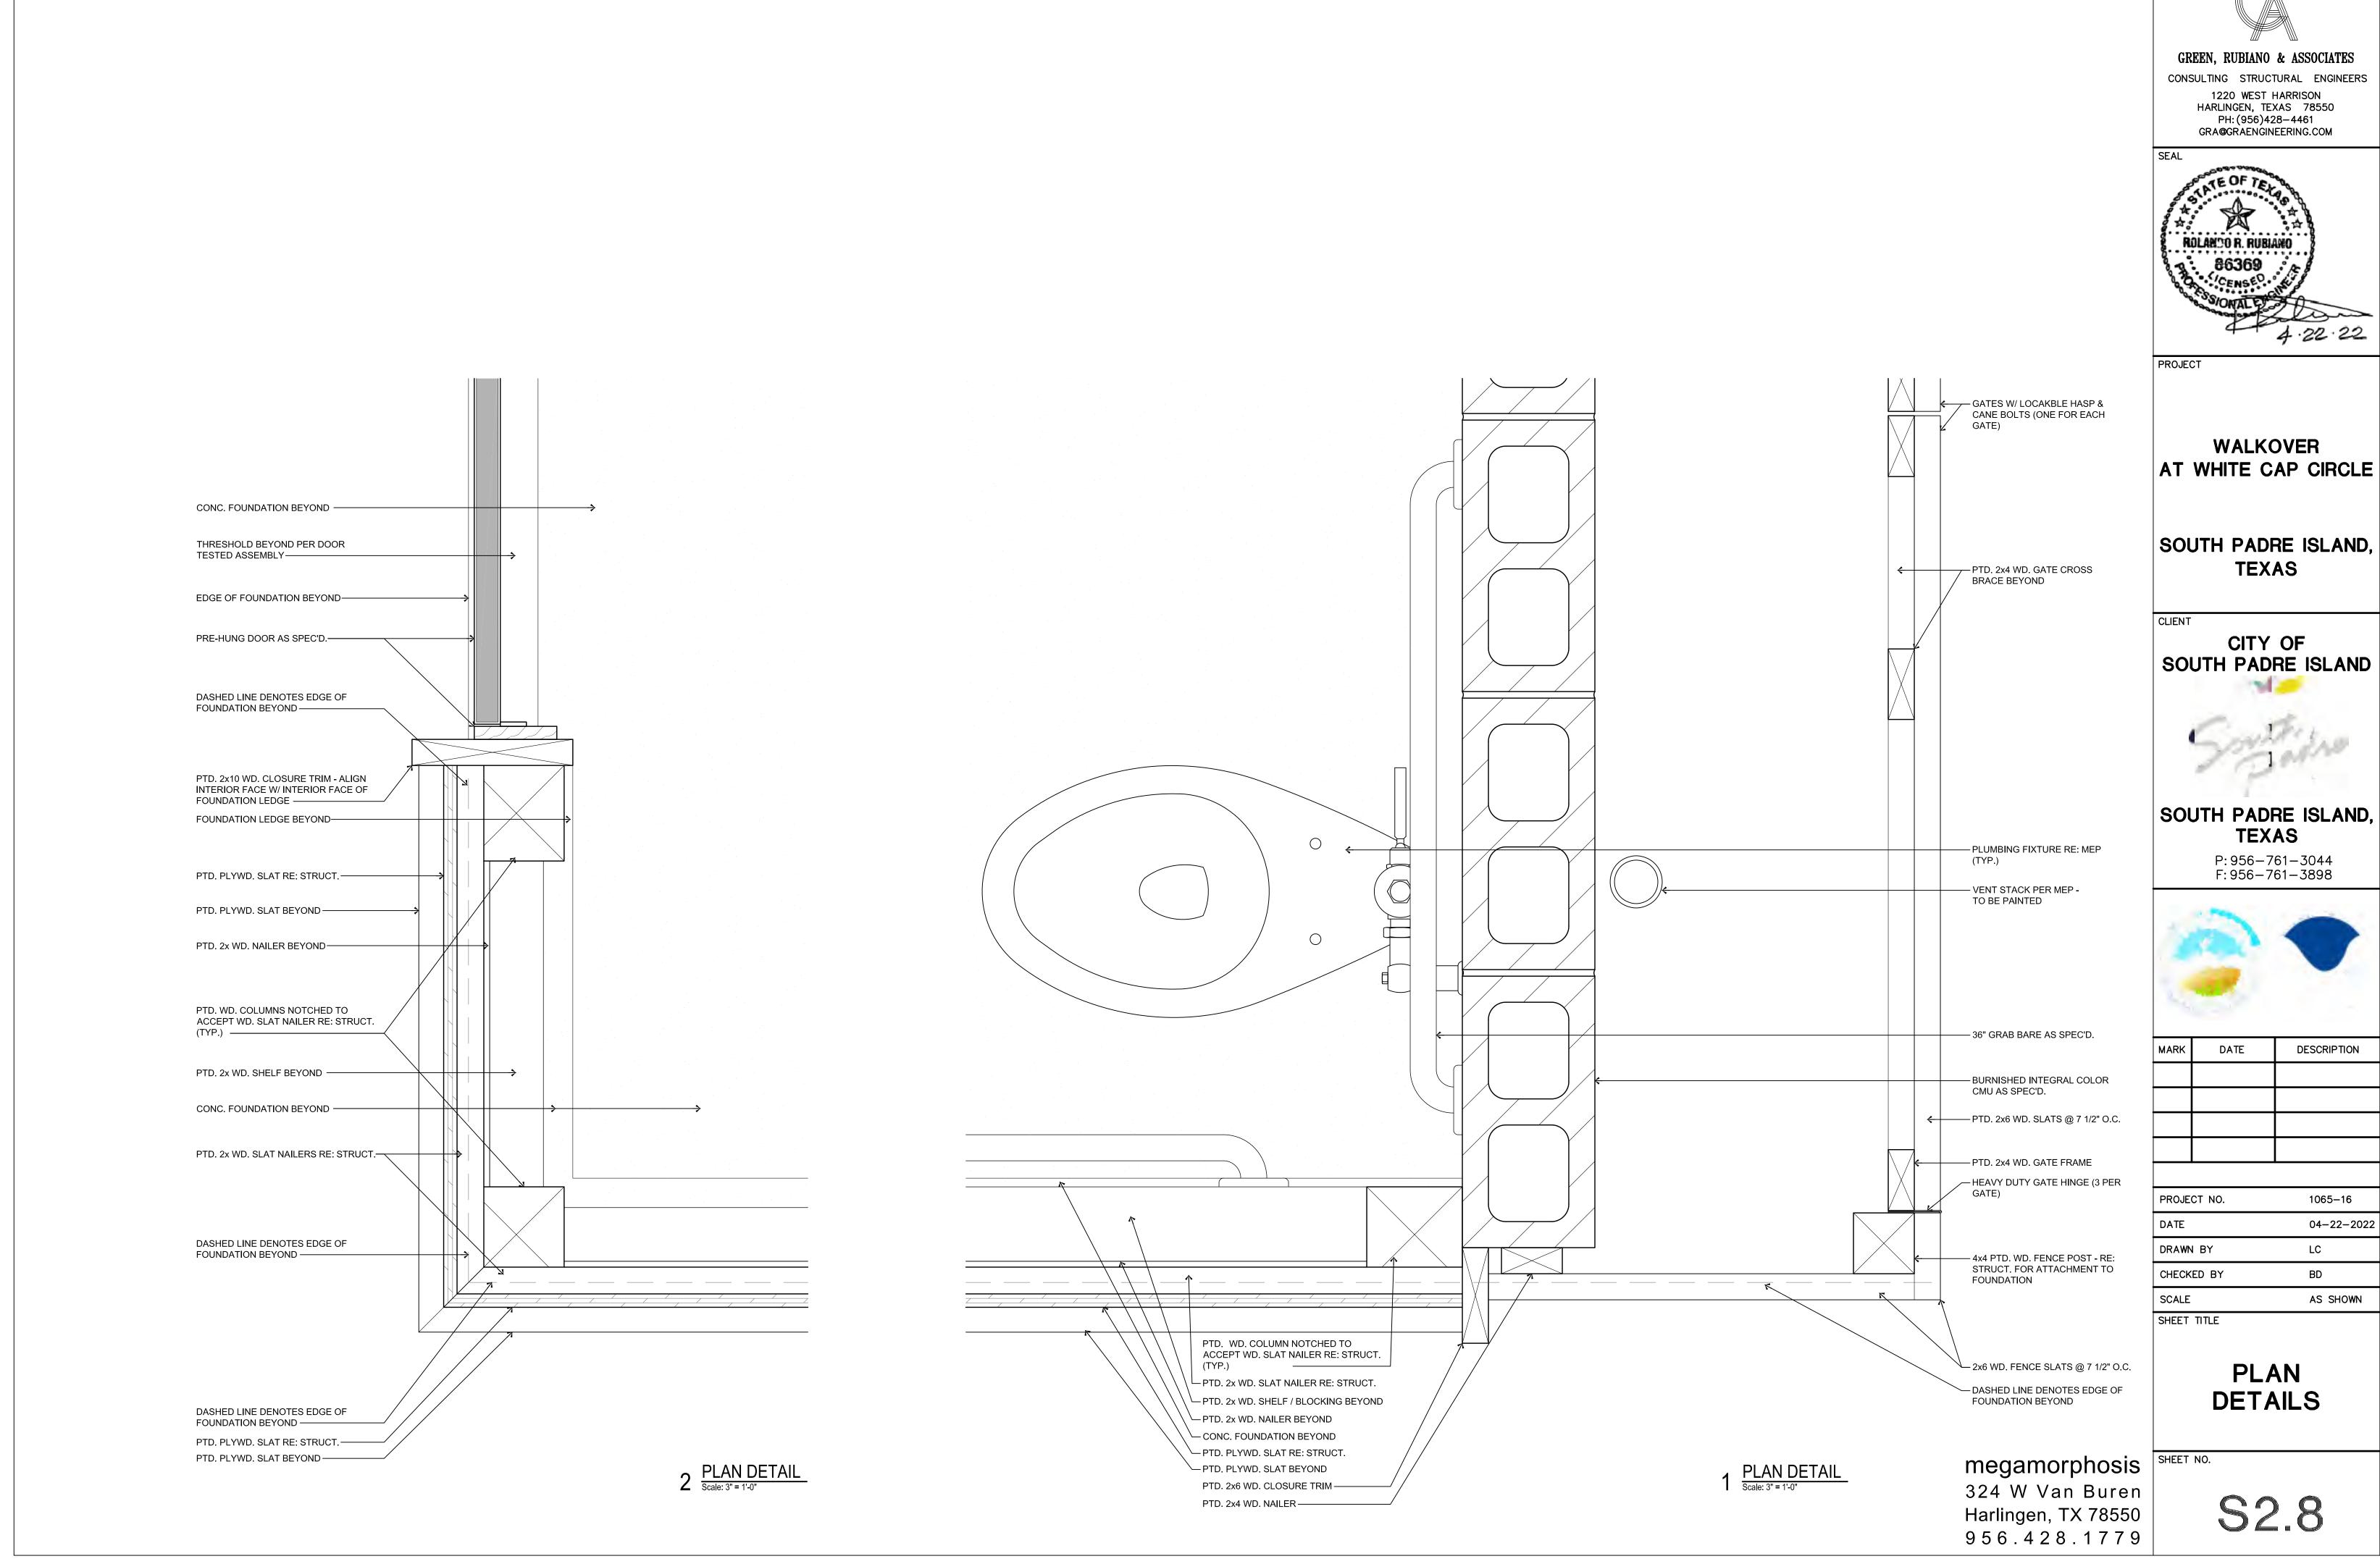




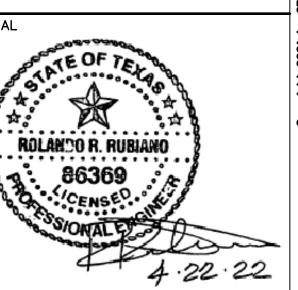

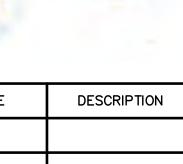


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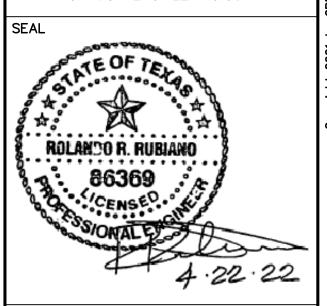


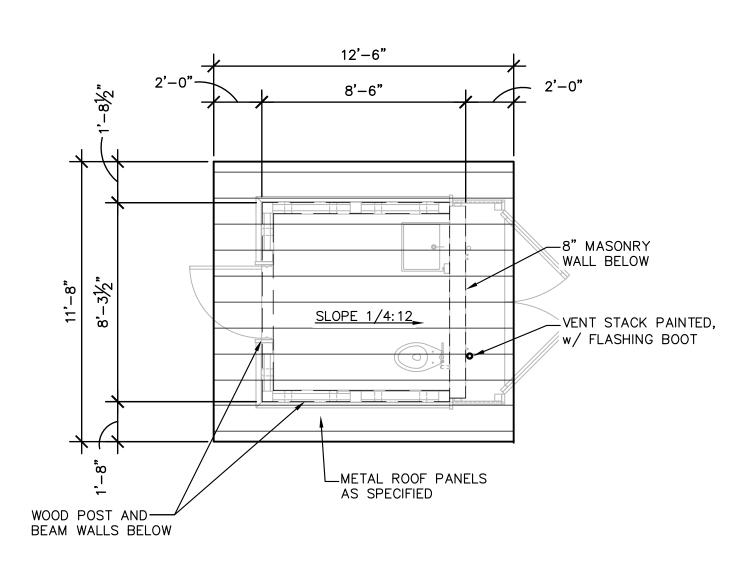



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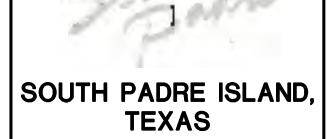
PROJECT

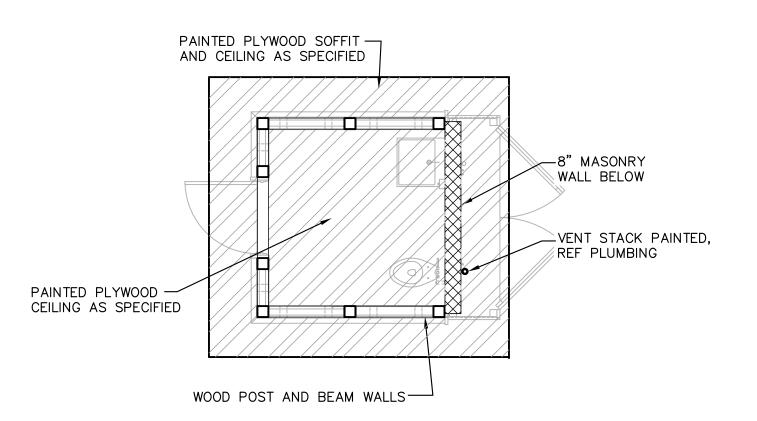WALKOVER AT WHITE CAP CIRCLE

SOUTH PADRE ISLAND, TEXAS

CLIENT

CITY OF SOUTH PADRE ISLAND



P: 956-761-3044 F: 956-761-3898






MARK	DATE	DESCRIPTION

PROJECT NO.	1065–16
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SHEET TITLE

RESTROOM ROOF AND CEILING PLAN

SHEET NO.



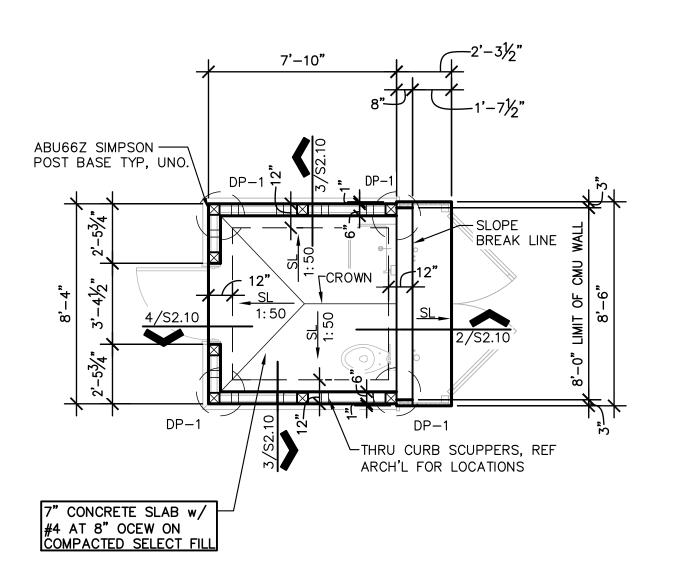



- 1. ALL SLABS & BEAMS ARE SUSPENDED. REFER TO SECTIONAL DETAILS FOR REINFORCEMENT.
- 2. SPLICE JOINTS FOR TOP BARS FOR REINFORCED CONCRETE SLABS AND BEAMS SHALL BE LOCATED AT MIDDLE THIRD OF THE SPAN OF SLABS OR BEAMS.
- 3. SPLICE JOINTS FOR BOTTOM BARS FOR REINFORCED CONCRETE SLAB AND BEAMS SHALL BE LOCATED AT SUPPORTS. 4. CONSTRUCTION JOINTS OF CONCRETE BEAMS/SLABS SHALL BE LOCATED WITHIN THE


MIDDLE THIRD OF THE SPAN. CONTRACTOR TO SUBMIT PROPOSED LOCATION OF


- CONSTRUCTION JOINTS TO ARCHITECT/ENGINEER FOR APPROVAL. 5. LAPPING OF SPLICE BARS AT SPLICE JOINTS SHALL BE 62 BAR DIAMETER OR A
- MINIMUM OF 36" LONG.

6. ALL CONDUIT GREATER THAN 1.1/2" IN DIAMETER (O.D.) SHALL BE RECESSED

- TO PROVIDE 1.1/2" CLEAR DISTANCE BETWEEN SLAB REBAR & CONDUIT. 7. MAINTAIN 2" MINIMUM CLEAR DISTANCE BETWEEN ALL CONDUIT IN SLAB.
- 8. A SINGLE CONDUIT (MAX 3" O.D.) MAY BE PLACED WITHIN THE BEAM CAGE. ALL CONDUIT IN BEAM CAGES TO BE TIED TO STIRRUPS MINIMUM OF 4"
- 9. ☑ INDICATES ABU66Z SIMPSON STAND-OFF POST BASE.
- 10. ALL MASONRY WALLS SHALL BE BURNISHED INTREGAL COLOR CMU AS SPECIFIED.

DRILLED PIER SCHEDULE			
MARK	SHAFT DIA. (INCHES)	VERTICAL REINFORCING	BEARING DEPTH BELOW MEAN SEA LEVEL (FEET MSL)
DP-1	18"	8-#7	-30.00'

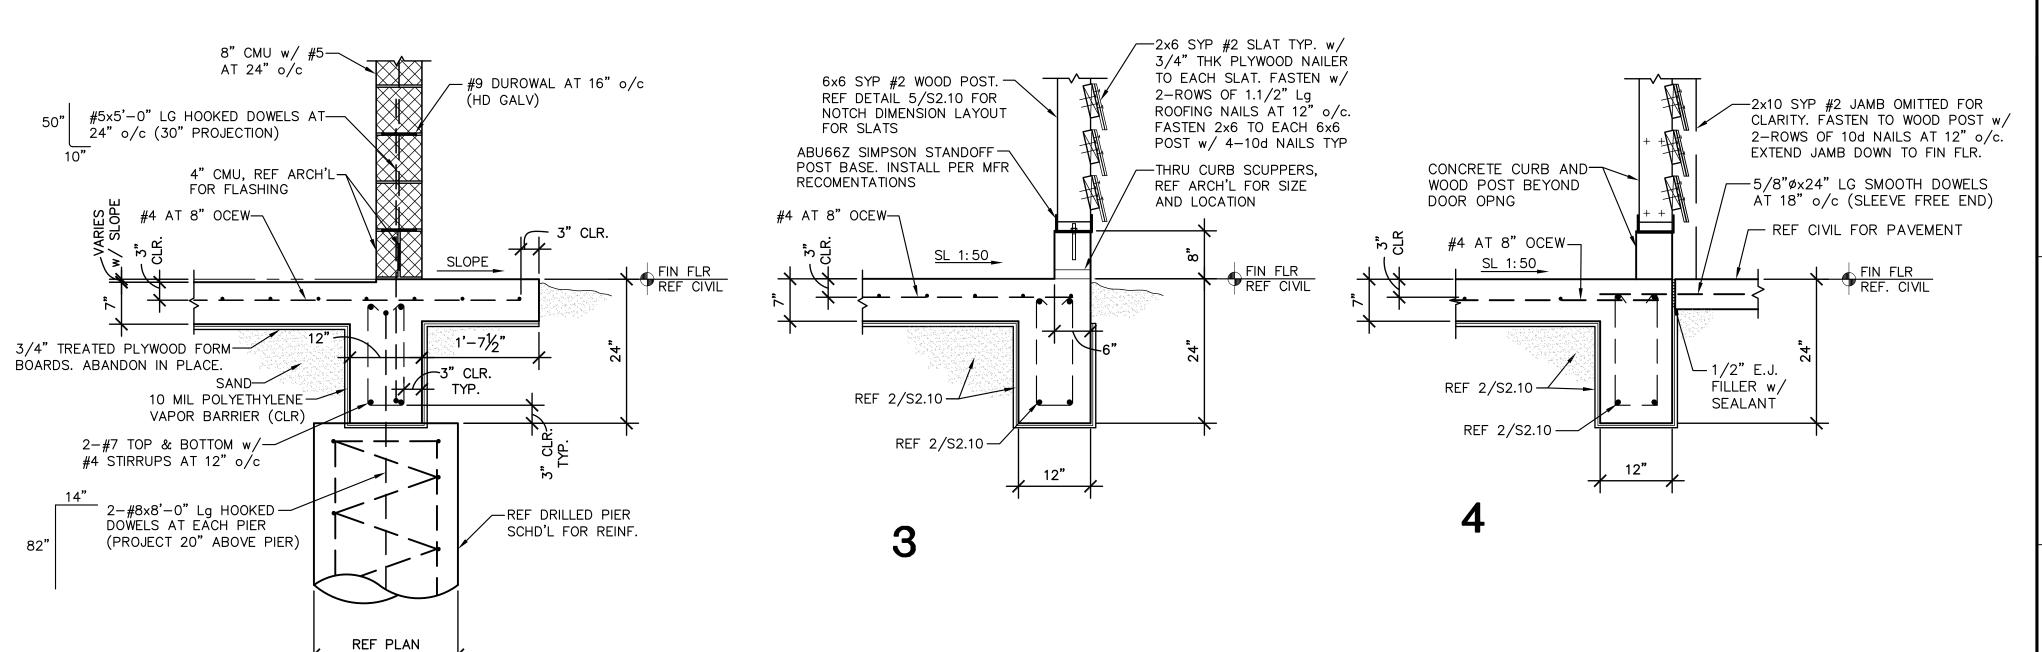

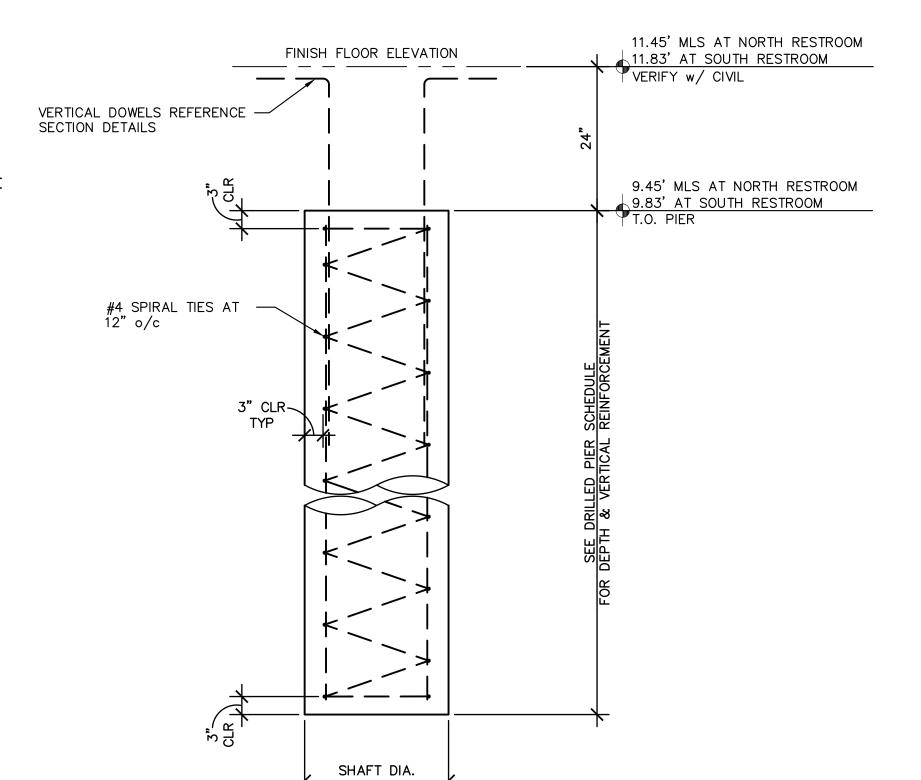





GREEN, RUBIANO & ASSOCIATES

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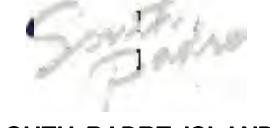
PROJECT

WALKOVER AT WHITE CAP CIRCLE

SOUTH PADRE ISLAND, **TEXAS**

CLIENT

CITY OF SOUTH PADRE ISLAND



SOUTH PADRE ISLAND, **TEXAS**

P: 956-761-3044 F: 956-761-3898




MARK	DATE	DESCRIPTION

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SHEET TITLE


FOUNDATION PLAN/DETAILS

SHEET NO.

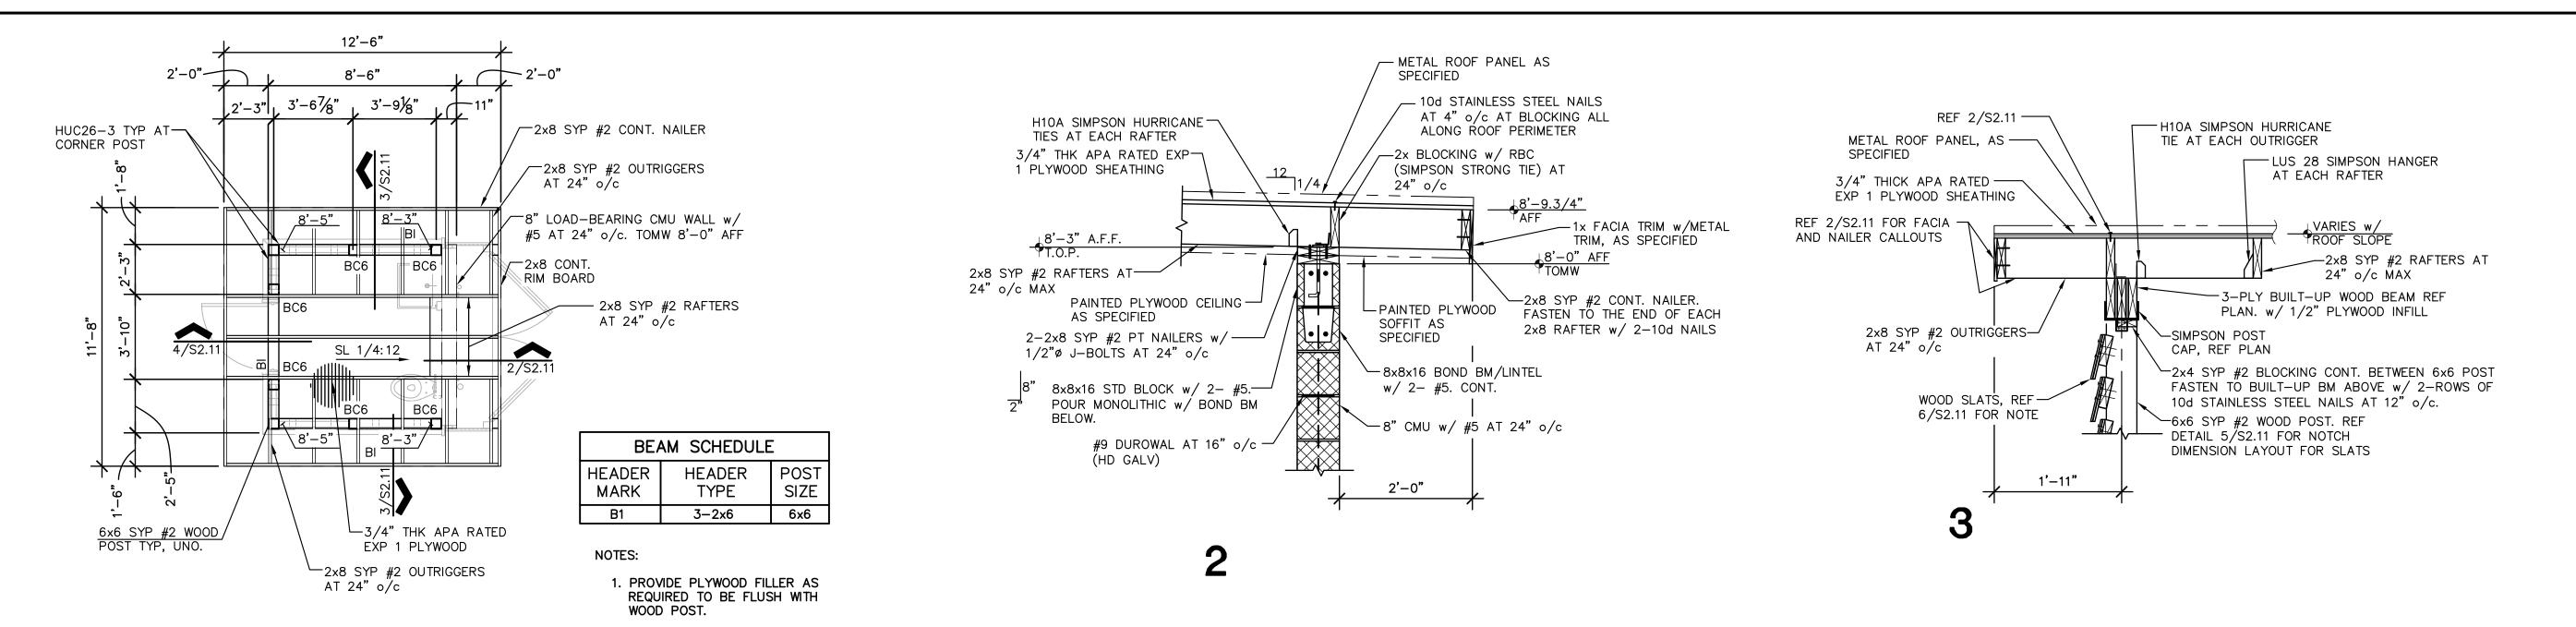

RESTROOM ROOF FRAMING PLAN 1/4" = 1'-0"2 REQUIRED


- 1. ROOF SHEATHING SHALL BE 3/4" APA RATED EXPOSURE 1. SPAN RATED 48/24.
- 2. REFERENCE ROOF SHEATHING NAILING SCHEDULE FOR PROPER PLYWOOD ATTACHMENT.
- 3. ALL HURRICANE TIES SHALL BE SIMPSON STRONG-TIE STAINLESS STEEL TYPE 316 OR APPROVED EQUAL. INSTALL PER MANUFACTURER'S RECOMMENDATIONS.
- 4. ALL MASONRY WALLS SHALL BE BURNISHED INTREGAL COLOR CMU AS SPECIFIED.

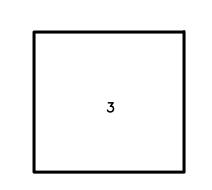


CITY OF SOUTH PADRE ISLAND WHITECAP WALKOVER RESTROOM ROOF DESIGN WIND PRESSURE DIAGRAM (SERVICE)

	GN WIND PRESSURE FOR COMPONENTS & CLADDING
ZONE	P- (UPLIFT)
3	-89 PSF

DOORS & WINDOWS MAXIMUM DESIGN WIND PRESSURES P+ = +29 PSF TOWARDS THE SURFACE P- = -38 PSF AWAY FROM THE SURFACE

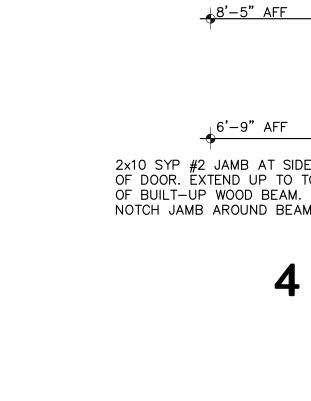

PLAN NORTH

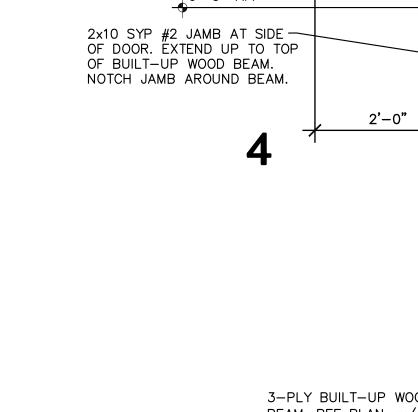

ROOF SHEATHING NAILING SCHEDULE

10d STAINLESS STEEL NAILS AT 4"


ALL 10d STAINLESS STEEL NAILS TO


MEET MINIMUM LENGTH/DIAMETER BELOW LENGTH 3"

SHANK DIAMETER 0.148"


o/c AT INTERIOR SUPPORTS

o/c ALONG EDGE OF SHEET AND 6"

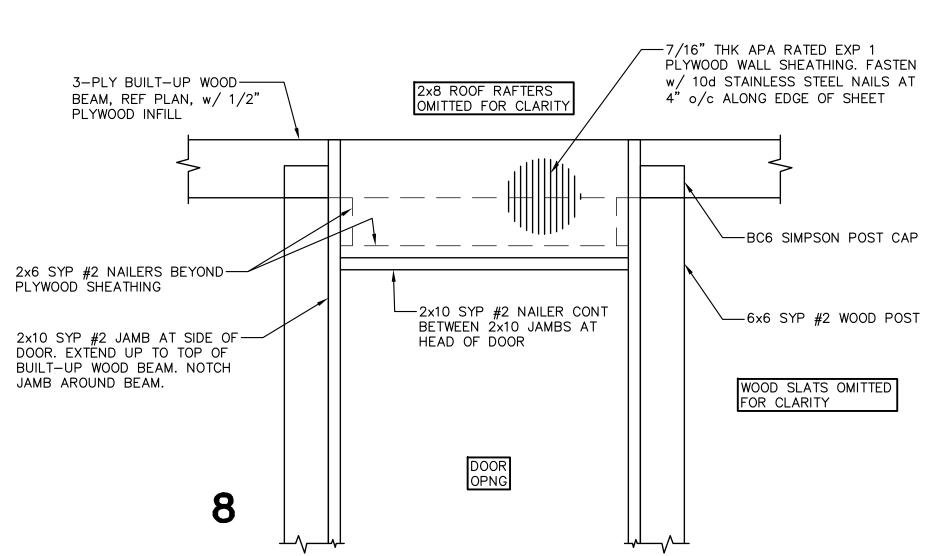

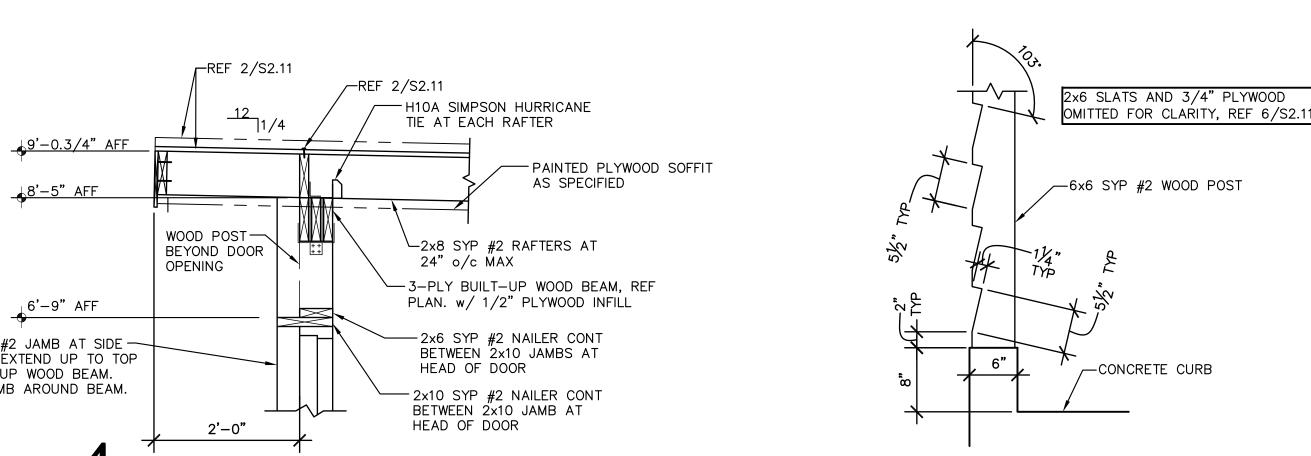

POST SIDE VIEW NOTCH DIMENSIONS 5

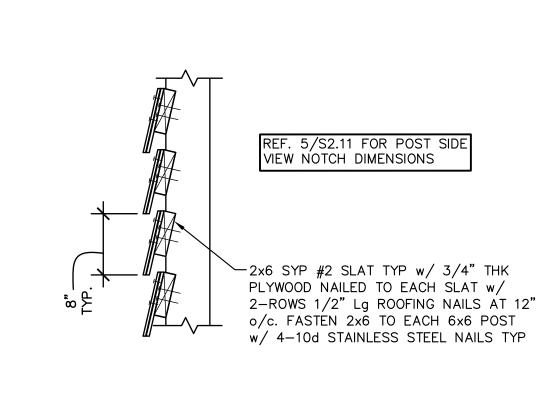


SLAT CONNECTION DETAIL



GREEN, RUBIANO & ASSOCIATES

CONSULTING STRUCTURAL ENGINEERS 1220 WEST HARRISON HARLINGEN, TEXAS 78550 PH: (956)428-4461 GRA@GRAENGINEERING.COM

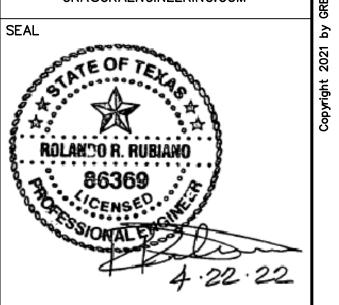

PROJECT

WALKOVER AT WHITE CAP CIRCLE

SOUTH PADRE ISLAND, **TEXAS**

CLIENT

CITY OF SOUTH PADRE ISLAND



SOUTH PADRE ISLAND, **TEXAS**

> P: 956-761-3044 F: 956-761-3898




MARK	DATE	DESCRIPTION

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SCALE	AS SHOWN

SHEET TITLE

FRAMING PLAN/DETAILS

SHEET NO.

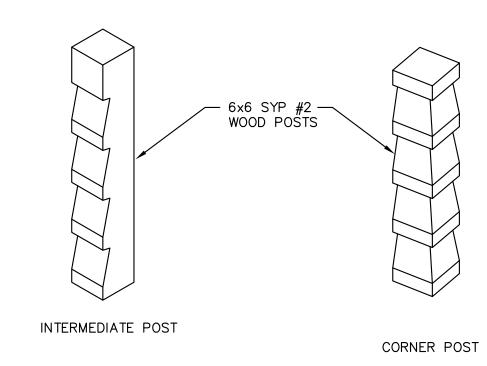



- 1. ALL MATERIALS, WORKMANSHIP AND IMPROVEMENTS SHALL BE IN ACCORDANCE WITH ALL LOCAL CODES, INCLUDING THE STANDARD CONSTRUCTION DETAILS AND TECHNICAL SPECIFICATIONS FROM THE CITY OF SOUTH PADRE ISLAND (THE OWNER), TEXAS DEPARTMENT OF TRANSPORTATION AND ALL OTHER GOVERNING AGENCIES.
- 2. PRIOR TO BEGINNING CONSTRUCTION, THE OWNER OR THEIR AUTHORIZED REPRESENTATIVE SHALL SCHEDULE A PRE—CONSTRUCTION CONFERENCE BETWEEN THE CONSULTING ENGINEER, CONTRACTOR, CITY OF SOUTH PADRE ISLAND, LAGUNA MADRE WATER DISTRICT, AND ALL AFFECTED PARTIES.
- 3. PRE-CONSTRUCTION PHOTOGRAPHS SHALL BE TAKEN THAT SHOW EXISTING CONDITIONS OF THE SITE AND ADJOINING STRUCTURES TO REMAIN. PHOTOS SHALL INCLUDE DAMAGE TO FINISH SURFACES THAT MIGHT BE MISCONSTRUED AS DAMAGE CAUSED BY DEMOLITION OPERATIONS. (NO SEPARATE PAY)
- 4. THE CONTRACTOR SHALL HAVE A PERSON ON CALL 24 HOURS A DAY TO ADDRESS CONSTRUCTION AREA MAINTENANCE ITEMS, TRAFFIC CONTROL, OR OTHER NEEDS NECESSARY FOR PUBLIC SAFETY. THIS PERSON SHALL HAVE AUTHORITY TO ACT ON BEHALF OF THE CONTRACTOR IN EMERGENCY CONDITIONS. THE PERSON SHALL BE STATIONED WITHIN 1/2 HOUR TRAVEL TIME FROM THE PROJECT SITE. THE PERSON SHALL BE IDENTIFIED IN WRITING PRIOR TO START OF CONSTRUCTION. THE ON—SITE REPRESENTATIVE SHALL HAVE ACCESS ALL EQUIPMENT AND MATERIAL AND HAVE FULL AUTHORITY NECESSARY TO CORRECT ANY PROBLEMS, DEFICIENCIES, OR EMERGENCIES WHICH MAY ARISE DURING NON—WORKING HOURS AND DURING THE ABSENCE OF THE SUPERINTENDENT.
- 5. STANDARD WORK HOURS:
- 5.1. THE STANDARD WORK HOURS FOR THE OWNER IS 8:00 AM TO 5:00 PM, MONDAY THROUGH FRIDAY. SHOULD THE CONTRACTOR ELECT TO WORK ON SATURDAY, SUNDAYS OR HOLIDAYS, HE SHALL BE RESPONSIBLE FOR PAYING OVERTIME CHARGES FOR THE OWNERS PERSONNEL INVOLVED. THESE CHARGES WILL BE AT COST AND WILL BE CALCULATED EITHER AT TIME AND A HALF OR DOUBLE TIME, AS APPLICABLE TO THE PARTICULAR DAY BEING WORKED. PRE—APPROVAL SHALL BE OBTAINED FROM THE ENGINEER OR ENGINEER'S REPRESENTATIVE BY COMPLETING AND SIGNING A OWNER'S FORM ENTITLED "CONSTRUCTION INSPECTORS OVERTIME COMPENSATION AUTHORIZATION", PRIOR TO COMMENCING ANY OVERTIME WORK.
- 5.2. ANY WORK DONE OUTSIDE THE STANDARD WORKDAY, WITHOUT PRIOR AUTHORIZATION, SHALL BE CONSIDERED UNDER UNAUTHORIZED WORK. THE CONTRACTOR IS REQUIRED TO PAY THE OVERTIME WAGES OF THE OWNER INSPECTORS THAT WORK OVERTIME MONDAYS THROUGH FRIDAYS AT TIME IN A HALF. THE CONTRACTOR IS RESPONSIBLE FOR THE OVERTIME WAGES OF THE ONWER INSPECTORS THAT WORK HOLIDAYS AT DOUBLE TIME. MINIMUM HOURS WILL BE BILLED TO CONTRACTOR FOR CALL OUTS OR FOR INSUFFICIENT NOTICE OF TWO (2) HOURS.
- 6. THE CONTRACTOR SHALL VERIFY ALL HORIZONTAL AND VERTICAL DIMENSIONS AND THE LOCATION OF EXISTING AND PROPOSED PROJECT ELEMENTS PRIOR TO CONSTRUCTION. ANY DISCREPANCIES BETWEEN PLAN DIMENSIONS AND ACTUAL FIELD CONDITIONS SHALL IMMEDIATELY BE BROUGHT TO THE ATTENTION OF THE ENGINEER AND OWNER. NO CONSTRUCTION ACTIVITY SHALL CONTINUE WITHOUT APPROVAL FROM THE OWNER.
- 7. ALL MATERIALS AND LABOR, WHETHER SPECIFICALLY INDICATED ON PLANS OR NOT, WHICH ARE NECESSARY FOR THE PROPER INSTALLATION AND FUNCTION OF THE SYSTEM SHALL BE FURNISHED BY THIS CONTRACTOR.
- 8. CONTRACTOR SHALL NOT PROCEED WITH ANY WORK INVOLVING A CHANGE IN PROJECT SCOPE, EQUIPMENT, MATERIALS OR COST WITHOUT FIRST HAVING OBTAINED ENGINEER'S AND/OR OWNER'S APPROVAL IN WRITING. IF APPROVAL HAS NOT BEEN OBTAINED IN WRITING PRIOR TO PROCEEDING WITH ANY CHANGE, CONTRACTOR WILL NOT BE REIMBURSED FOR SUCH CHANGE.
- 9. CONTRACTOR TO PLAN AND PERFORM THEIR WORK IN A MANNER THAT WILL PERMIT SAFE PUBLIC TRAFFIC MOVEMENT ON ALL STREETS.
- 10. THE CONTRACTOR SHALL PLAN AND SEQUENCE ALL CONSTRUCTION ACTIVITY IN SUCH A MANNER THAT WILL PERMIT SAFE PEDESTRIAN AND VEHICULAR MOVEMENT.
- 11. TEMPORARY TRAFFIC CONTROL DURING CONSTRUCTION SHALL BE IN ACCORDANCE WITH TXDOT SPECIFICATIONS. CONTRACTOR SHALL SUBMIT A TRAFFIC CONTROL PLAN, IN ACCORDANCE WITH SPECIFICATION 01 55 26 TRAFFIC CONTROL AND REGULATION FOR APPROVAL BY THE OWNER, PRIOR TO CONSTRUCTION. THE TRAFFIC CONTROL PLAN SHALL BE PREPARED BY A PROFESSIONAL ENGINEER LICENSED TO PRACTICE IN THE STATE OF TEXAS. ALL TRAFFIC CONTROL / TRAFFIC SAFETY SHALL BE IN ACCORDANCE WITH THE LATEST MANUAL ON UNIFORM TRAFFIC CONTROL DEVICES (MUTCD) CRITERIA.
- 12. CONTRACTOR SHALL PROVIDE PROTECTIVE DEVICES SUCH AS SIGNS, LIGHTS, SIGNALS, AND OTHER DEVICES. AS NEEDED FOR THE SAFETY OF THE PUBLIC AND WORKERS. (NO SEPARATE PAY)
- 13. CONTRACTOR SHALL BE RESPONSIBLE FOR PROTECTION AND SAFETY OF THE WORK SITE, WORKERS, SUBCONTRACTORS, MATERIALS AND EQUIPMENT.
- 14. THE DRAWINGS AND SPECIFICATIONS REPRESENT THE COMPLETED STRUCTURES/DESIGN. THEY DO NOT INDICATE THE METHOD OF CONSTRUCTION. THE CONTRACTOR SHALL PROVIDE ALL MEASURES AND MEANS NECESSARY TO PROTECT PERSONS AND STRUCTURES DURING CONSTRUCTION. OBSERVATION BY THE ENGINEER OR THE OWNER DOES NOT INCLUDE REVIEW OF THESE MEASURES.
- 15. THESE PLANS, PREPARED BY HALFF ASSOCIATES, INC., DO NOT EXTEND TO OR INCLUDE DESIGN OF SYSTEMS PERTAINING TO THE SAFETY OF THE CONSTRUCTION CONTRACTOR OR ITS EMPLOYEES, AGENTS OR REPRESENTATIVES IN THE PERFORMANCE OF THE WORK. THE SEAL OF HALFF ASSOCIATES, INC., REGISTERED PROFESSIONAL ENGINEER(S) HEREON DOES NOT EXTEND TO ANY SUCH SAFETY SYSTEMS THAT MAY NOW OR HEREAFTER BE INCORPORATED IN THESE PLANS. THE CONSTRUCTION CONTRACTOR SHALL PREPARE OR OBTAIN THE APPROPRIATE SAFETY SYSTEMS, INCLUDING THE PLANS AND SPECIFICATIONS REQUIRED BY THE HOUSE BILLS 662 AND 665 ENACTED BY THE TEXAS LEGISLATURE IN THE 70TH LEGISLATURE REGULAR SESSION.
- 16. CONTRACTOR SHALL PROVIDE A SEQUENCE OF WORK AND PERFORM ASSOCIATED GRADING THAT PROVIDES POSITIVE OUTFALLS AT ALL TIMES.
- 17. CONSTRUCTION STAKING AND SURVEYING SHALL BE PROVIDED BY THE CONTRACTOR AND AT CONTRACTOR'S EXPENSE. ALL DIMENSIONS ARE TO BACK OF CURB OR, WHERE NO CURB EXISTS, TO EDGE OF PAVEMENT UNLESS SHOWN OTHERWISE. ALL UTILITY DIMENSIONS AND STATIONS/COORDINATES ARE TO CENTER OF THE STRUCTURE UNLESS SHOWN OTHERWISE.
- 18. CONTRACTOR TO COORDINATE WITH THE OWNER ON WORK SCHEDULES, TESTING, GENERAL INSPECTION, AND OPERATION AND LOCATION OF EXISTING LINES.
- 19. THE CONTRACTOR IS RESPONSIBLE FOR SCHEDULING ALL CONSTRUCTION MATERIALS TESTING AND GENERAL INSPECTIONS. THE CONTRACTOR SHALL COORDINATE THROUGH THE OWNER'S DESIGNATED FIELD REPRESENTATIVE A MINIMUM OF 24—HOURS PRIOR TO TESTING OR INSPECTION. FAILURE TO BE PREPARED FOR TESTING MAY RESULT IN TRAVEL CHARGES. RE—TESTING WILL BE BORNE BY THE CONTRACTOR.
- 20. MATERIAL TESTING SHALL BE PROVIDED BY THE OWNER. RE-TEST TO BE AT CONTRACTOR'S EXPENSE.
- 21. THE CONTRACTOR SHALL INSPECT ALL MATERIALS AT DELIVERY AND NOTIFY THE OWNER OF ANY DAMAGED OR QUESTIONABLE MATERIALS. ANY DAMAGED OR QUESTIONABLE MATERIAL INSTALLED WITHOUT PRIOR INSPECTION BY THE OWNER SHALL BE REMOVED AT THE CONTRACTOR'S EXPENSE.
- 22. CONTRACTOR SHALL BE RESPONSIBLE FOR OBTAINING ALL PERMITS REQUIRED. (NO SEPARATE PAY)
- 23. THE CONTRACTOR IS ENCOURAGED TO INSPECT AND DOCUMENT THE PRE-CONSTRUCTION CONDITION OF ALL PRIVATE DRIVEWAYS, MAILBOXES, PAVEMENT AREAS, SIDEWALKS, CURB AND GUTTER, FENCES AND ALL OTHER ITEMS TO BE AFFECTED BY PROPOSED CONSTRUCTION PRIOR TO COMMENCING.

- 24. ANY DAMAGE TO EXISTING PAVEMENT OR EXISTING STRUCTURES SHALL BE REPAIRED TO PRE—CONSTRUCTION CONDITION OR BETTER AT CONTRACTOR'S EXPENSE. EXISTING STRUCTURES MAY INCLUDE BUT ARE NOT LIMITED TO INLETS, MANHOLES, POWER POLES, SIDEWALKS, CURB AND GUTTER, FENCES, SPRINKLER SYSTEMS, LAWNS OR PRIVATE PROPERTY IMPROVEMENTS.
- 25. NO TREES SHALL BE REMOVED WITHOUT PERMISSION OF THE OWNER OR ENGINEER, UNLESS OTHERWISE NOTED.
- 26. CONTRACTOR SHALL GIVE NOTICE TO ALL AUTHORIZED INSPECTORS, SUPERINTENDENTS, OR PERSONS IN CHARGE OF PRIVATE AND PUBLIC UTILITIES AFFECTED BY THEIR OPERATIONS PRIOR TO COMMENCEMENT OF WORK. NOTIFY TEXAS ONE CALL FOR UTILITY LOCATIONS PRIOR TO ANY AND ALL FXCAVATIONS
- 27. CONTRACTOR TO EXERCISE EXTREME CAUTION WHEN WORKING NEAR EXISTING FACILITIES AND/OR UTILITIES. ALL DAMAGE TO BE REPAIRED AT CONTRACTOR'S EXPENSE. ALL COSTS FOR INTERRUPTION OF GAS, ELECTRICAL, COMMUNICATIONS AND/OR WATER SERVICE DUE TO CONTRACTOR'S WORK SHALL BE BORNE BY THE CONTRACTOR.
- 28. INFORMATION ON EXISTING UTILITIES, AS SHOWN ON THESE PLANS, IS FROM BEST AVAILABLE INFORMATION OF RECORD AND SPOT FIELD LOCATIONS. ALTHOUGH EVERY EFFORT HAS BEEN MADE TO ACCURATELY DEPICT ALL UTILITIES, NOT ALL (PUBLIC AND PRIVATE) MAY BE SHOWN. CONTRACTOR IS RESPONSIBLE FOR FIELD VERIFICATION AND LOCATION OF THESE UNDERGROUND UTILITIES AS REQUIRED AT NO SEPARATE PAY. CONTRACTOR TO COORDINATE WITH ALL UTILITY COMPANIES.
- 29. ALL WORK SHALL BE PERFORMED WITHIN THE OWNER'S RIGHT-OF-WAY, EASEMENTS OR ON PUBLIC-OWNED PROPERTY. IT SHALL BE THE CONTRACTOR'S RESPONSIBILITY TO OBTAIN PERMISSION TO USE PRIVATE PROPERTY, IF NECESSARY, FOR THE PURPOSES OF STAGING, STOCKPILE, STORAGE OR REFUSE AREAS. THE CONTRACTOR SHALL PROVIDE WRITTEN EVIDENCE TO THE OWNER PRIOR TO USE.
- 30. THE CONTRACTOR SHALL NOTIFY ALL AFFECTED RESIDENTS OR BUSINESS OWNERS OF CONSTRUCTION ACTIVITY THROUGH THE USE OF BILINGUAL (ENGLISH AND SPANISH) DOOR TAGS, PAMPHLETS OR SIMILAR METHODS. ALL AFFECTED PARTIES MUST BE NOTIFIED A MINIMUM OF 48—HOURS PRIOR TO COMMENCING CONSTRUCTION. THE CONTRACTOR SHALL PROVIDE A SAMPLE OF THE NOTIFICATION TO THE OWNER PRIOR TO IMPLEMENTATION.
- 31. CONTRACTOR TO ENSURE SAME DAY ACCESS TO ALL RESIDENCES AND BUSINESSES ADJACENT TO CONSTRUCTION.
- 32. THE CONTRACTOR SHALL DO ALL NECESSARY CLEARING, EXCAVATION, TRENCHING, SHORING, DE-WATERING, DEMOLITION, GRADING, BACKFILLING, ETC. TO COMPLETE THE PROJECT. ASSOCIATED COSTS SHALL BE SUBSIDIARY TO THE RESPECTIVE BID ITEMS AS IDENTIFIED IN THE CONTRACT UNLESS NOTED OTHERWISE.
- 33. THE CONTRACTOR SHALL PROVIDE AN EMERGENCY PLAN, IN CASE OF A LARGE RAIN EVENT OR OTHER IMPACTFUL EVENT, FOR APPROVAL BY THE OWNER PRIOR TO CONSTRUCTION. THE PLAN SHALL BE DEVELOPED, SIGNED AND SEALED BY A LICENSED PROFESSIONAL ENGINEER IN THE STATE OF TEXAS. ADEQUACY AND IMPLEMENTATION OF THE PLAN IS THE SOLE RESPONSIBILITY OF THE CONTRACTOR. THE OWNER RESERVES THE RIGHT TO REJECT THE PLANS. (NO SEPARATE PAY)
- 34. ALL COMPACTION SHALL BE ACHIEVED BY MECHANICAL METHODS. NO WATER JETTING ALLOWED, UNLESS APPROVED BY THE OWNER.
- 35. ALL SPOIL MATERIAL AND DEBRIS SHALL BE DISPOSED OFFSITE BY THE CONTRACTOR IN A LEGAL MANNER. FURNISHING AND TRANSPORTATION OF ALL OFFSITE MATERIAL TO BE AT CONTRACTOR'S EXPENSE.
- 36. DEMOLITION, REMOVAL AND DISPOSAL OF ALL EXCESS CONCRETE, CURBS, RUBBLE, ETC. TO BE DONE IN A LEGAL MANNER AT CONTRACTOR'S EXPENSE.
- 37. THE CONTRACTOR SHALL KEEP THE CONSTRUCTION AREA AS CLEAN AS POSSIBLE. ALL ASSOCIATED DEBRIS SHALL BE COLLECTED AND PROPERLY DISPOSED OF AT THE END OF EACH WORKDAY.
- 38. UPON COMPLETION OF CONSTRUCTION, CONTRACTOR SHALL RETURN THE SITE TO ORIGINAL CONTOURS UNLESS DIFFERENT FINISHED ELEVATIONS ARE SHOWN ON PLANS. CONTRACTOR TO ENSURE NO AREAS OF PONDING ARE PRESENT.
- 39. CONCRETE NOTES (FOR CIVIL SITE WORK):
- 39.1. ALL CONCRETE WORK TO BE FORMED, UNLESS OTHERWISE APPROVED.
- 39.2. ALL CONCRETE TO BE 3000-PSI MINIMUM AT 28 DAYS, UNLESS OTHERWISE SHOWN.
- 39.3. STRENGTH TO BE DETERMINED BY CYLINDER BREAK TEST.
- 39.4. ALL REINFORCING STEEL TO BE ASTM A-615, GRADE 60, UNLESS OTHERWISE SHOWN.
- 39.5. ALL EXPOSED CONCRETE WORK TO BE CHAMFERED.
- 39.6. ALL CONCRETE USED FOR CURB AND GUTTER, CONCRETE PAVEMENT, DRIVEWAYS, SIDEWALKS AND OTHER FLAT WORK SHALL CONTAIN A MINIMUM OF 1.5 POUNDS OF FIBER MESH PER CUBIC YARD.
- 39.7. ALL EXPOSED CONCRETE SURFACES SHALL BE TREATED WITH CURING COMPOUND RESIN BASE ASTM C 309 TYPE 2 WITH PIGMENTED TINT OF FUGITIVE DYE.
- 39.8. EXPANSION JOINTS WILL BE PLACED AT CURB RETURNS, INLETS AND AT THE END OF EACH POUR WITH INTERVALS NOT TO EXCEED 40 FT. JOINTS SHALL CONSIST OF 1/2" PRE-MOLDED EXPANSION JOINT MATERIAL WITH 3, 36" X 1/2" DOWELS, ONE END GREASED AND WRAPPED. CARE MUST BE TAKEN THAT DOWELS ARE STRAIGHT AND LAID PARALLEL WITH CURB AND NO CONCRETE PLUGS OR OTHER MATERIAL BE ALLOWED THROUGH THE DOWEL HOLES OR EXPANSION MATERIAL WHICH WOULD PREVENT THE JOINT FROM OPERATION AS AN EXPANSION JOINT. EXPANSION JOINT MATERIALS SHALL BE PRE-MOLDED ASPHALT IMPREGNATED EXPANSION JOINT MATERIAL CONFORMING WITH ASTM D 994 (NOT WOOD FIBER TYPE)
- 39.9. CONTRACTION (DUMMY, SAWED OR GROVED) JOINTS SHALL BE 2" DEEP AND PLACED AT MAXIMUM OF 10-FOOT INTERVALS.
- 39.10. WHEN CONNECTING TO EXISTING CURB AND GUTTER, THE CONTRACTOR SHALL DRILL AND DOWEL TWO #6 X 16" TIE BARS A MINIMUM OF 6-INCHES DEEP INTO THE EXISTING CURB AND GUTTER SECTION
- 40. THE CONTRACTOR SHALL BE RESPONSIBLE FOR RECORDING ALL FIELD CHANGES AND FURNISHING A LEGIBLE SET OF "RECORD" DRAWINGS TO THE OWNER.
- 41. WHEN INSTALLING ANY MANUFACTURED PRODUCT, THE CONTRACTOR SHALL FOLLOW ALL MANUFACTURER'S RECOMMENDED INSTALLATION DIRECTIONS. IF ANY CONFLICTS OR DISCREPANCIES BETWEEN MANUFACTURER'S DIRECTIONS AND THE CONTRACT DOCUMENTS ARE FOUND, THE CONTRACTOR SHALL NOTIFY THE ENGINEER IN WRITING AND SHALL NOT PERFORM ANY WORK ON ANY ITEM UNTIL SUCH CONFLICT HAS BEEN RESOLVED IN WRITING.
- 42. INDEMNIFICATION: TO THE FULLEST EXTENT PERMITTED BY APPLICABLE LAWS AND REGULATIONS, CONTRACTOR SHALL INDEMNIFY AND HOLD HARMLESS OWNER, ENGINEER, ENGINEER'S SUBCONSULTANTS AND THE OFFICERS, DIRECTORS, EMPLOYEES, AGENTS, AND OTHER CONSULTANTS OF EACH AND ANY OF THEM FROM AND AGAINST ALL CLAIMS, COSTS, LOSSES, AND DAMAGES (INCLUDING BUT NOT LIMITED TO ALL FEES AND CHARGES OR ENGINEERS, ARCHITECTS, ATTORNEYS, AND OTHER PROFESSIONALS AND ALL COURT OR ARBITRATION OR OTHER DISPUTE RESOLUTION COSTS) CAUSED BY, ARISING OUT OF, OR RESULTING FROM, THE PERFORMANCE OF THE WORK, PROVIDED THAT ANY SUCH CLAIM, COST, LOSS OR DAMAGE:

- 42.1. IS ATTRIBUTABLE TO BODILY INJURY, SICKNESS, DISEASE, OR DEATH, OR TO INJURY TO OR DESTRUCTION OF TANGIBLE PROPERTY (OTHER THAN THE WORK ITSELF), INCLUDING THE LOSS OF USE RESULTING THEREFROM, AND
- 42.2. IS CAUSED IN WHOLE OR IN PART BY ANY NEGLIGENT ACT OR OMISSION OF CONTRACTOR, ANY SUBCONTRACTOR, ANY SUPPLIER, ANY PERSON, OR ORGANIZATION DIRECTLY OR INDIRECTLY EMPLOYED BY ANY OF THEM TO PERFORM OR FURNISH ANY OF THE WORK, OR ANYONE FOR WHOSE ACTS ANY OF THEM MAY BE LIABLE, REGARDLESS OF WHETHER OR NOT CAUSED IN PART BY ANY NEGLIGENCE OR OMISSION OF A PERSON OR ENTITY INDEMNIFIED HEREUNDER OR WHETHER LIABILITY IS IMPOSED UPON SUCH INDEMNIFIED PARTY BY LAWS AND REGULATIONS REGARDLESS OF THE NEGLIGENCE OF ANY SUCH PERSON OR ENTITY. CLAIMS, COSTS, LOSSES, DAMAGES, SUITS AND CAUSES OF ACTION, AND ANY AND ALL LIABILITY, COSTS, EXPENSES, SETTLEMENTS, DAMAGES, AND JUDGMENTS INCURRED IN CONNECTION THEREWITH (INCLUDING BUT NOT LIMITED TO ALL FEES AND CHARGES OF ENGINEERS, ARCHITECTS, ATTORNEYS, AND OTHER PROFESSIONALS, AND ALL COURT OR ARBITRATION OR OTHER DISPUTES RESOLUTION COSTS) WHETHER ARISING IN EQUITY, AT COMMON LAW, OR BY STATUTE, INCLUDING THE TEXAS DECEPTIVE TRADE PRACTICES ACTOR SIMILAR STATUTE OF OTHER JURISDICTIONS, OR UNDER THE LAW OF CONTRACTS, TORTS (INCLUDING WITHOUT LIMITATION, NEGLIGENCE AND STRICT LIABILITY WITHOUT REGARD TO FAULT) OR PROPERTY, OF EVERY KIND OR CHARACTER
- 42.3. IS CAUSED IN WHOLE OR IN PART BY ANY NEGLIGENT ACT OR OMISSION, OTHER FAULT, BREACH OF CONTRACT OR WARRANTY, VIOLATION OF THE TEXAS DECEPTIVE TRADE PRACTICES ACT, OR STRICT LIABILITY WITHOUT REGARD TO FAULT OF CONTRACTOR. REGARDLESS OF WHETHER OR NOT CAUSED IN PART BY ANY NEGLIGENCE OR OMISSION, OTHER FAULT, BREACH OF CONTRACT OR WARRANTY, VIOLATION OF THE TEXAS DECEPTIVE TRADE PRACTICES ACT, OR STRICT LIABILITY WITHOUT REGARD TO FAULT OF A PERSON OR ENTITY INDEMNIFIED HEREUNDER.

CONTRACTOR'S OBLIGATIONS OF INDEMNIFICATION UNDER THIS PARAGRAPH SHALL NOT BE LIMITED BY THE AMOUNT OF ANY INSURANCE.

UTILITY NOTES:

1. THE TYPE, SIZE AND LOCATION OF ALL UNDERGROUND UTILITIES DEPICTED ON THE CONSTRUCTION PLANS WERE RESEARCHED WITH RESPECT TO THE BEST AVAILABLE DATA AND THEREFORE SHOWN APPROXIMATE. ALTHOUGH EVERY EFFORT HAS BEEN MADE TO ACCURATELY DEPICT ALL UTILITIES, NOT ALL (PUBLIC AND PRIVATE) MAY BE SHOWN. NEITHER THE ENGINEER NOR THE OWNER IS RESPONSIBLE FOR THE ACCURACY OF THE LOCATION OF THE UTILITIES SHOWN ON THE CONSTRUCTION PLANS. IT SHALL BE THE RESPONSIBILITY OF THE CONTRACTOR TO CONTACT ALL UTILITY COMPANIES WITH JURISDICTION WITHIN THE LIMITS OF CONSTRUCTION FOR FIELD VERIFICATION AT NO ADDITIONAL EXPENSE TO THE OWNER. UTILITY COMPANIES TO INCLUDE BUT NOT LIMITED TO THE FOLLOWING:

- 1.1. SOUTH PADRE ISLAND PUBLIC WORKS DEPT. (956) 761-8159
- 1.2. CITY (HALL) OF SOUTH PADRE ISLAND (956) 761-6456
- 1.3. LAGUNA MADRE WATER DISTRICT OFFICE (956) 943-2626
- 1.4. LAGUNA MADRE WATER DISTRICT EMERGENCIES AFTER HOURS (956) 572-1716
- 1.5. TXDOT BROWNSVILLE OFFICE (956) 542-2260
- 1.6. TEXAS 811
- 1.7. TEXAS GAS SERVICE (800) 700-2443
- 1.8. SPECTRUM/TIME WARNER CABLE/AT&T/VERIZON/CHARTER COMMUNICATIONS/FRONTIER COMMUNICATIONS
- 1.9. AMERICAN ELECTRIC AND POWER (AEP) TEXAS/MAGIC VALLEY ELECTRICAL COOPERATIVE
- 2. CONTRACTOR SHALL EXPOSE ANY EXISTING UTILITY THAT MAY BE IN CONFLICT PRIOR TO COMMENCING CONSTRUCTION AND EXCAVATION.
- 3. THE CONTRACTOR SHALL NOTIFY ALL AUTHORIZED INSPECTORS, SUPERINTENDENTS, OR PERSONS RESPONSIBLE FOR PUBLIC AND PRIVATE UTILITIES AFFECTED BY HIS/HER OPERATIONS PRIOR TO COMMENCING CONSTRUCTION.
- 4. CONTRACTOR SHALL AT ALL TIMES ALLOW ACCESS TO EXISTING DRIVEWAY OR PROVIDE/MAINTAIN ALTERNATIVE ALL—WEATHER ROUTES.
- 5. IN ACCORDANCE WITH HOUSE BILLS 662 AND 665 ENACTED BY THE TEXAS LEGISLATURE (70th REGULAR LEGISLATIVE SESSION), THE CONTRACTOR SHALL MEET THE REQUIREMENTS FOR TRENCH SAFETY AS OUTLINED IN THE CURRENT VERSION OF THE UNITED STATES DEPARTMENT OF LABOR, OCCUPATIONAL SAFETY AND HEALTH ADMINISTRATION (OSHA) STANDARDS, 29 CFR, PART 1926, SUBPART P-EXCAVATIONS.
- 6. PRIOR TO COMMENCING ANY EXCAVATION, THE CONTRACTOR SHALL PROVIDE A TRENCH SAFETY PLAN. ALL PLANS SHALL BE PREPARED BY A PROFESSIONAL ENGINEER LICENSED TO PRACTICE IN THE STATE OF TEXAS. THE PLAN SHALL BE SUBMITTED TO THE OWNER FOR APPROVAL.
- 7. IN THE EVENT CONDITIONS ENCOUNTERED IN THE FIELD REQUIRE TRENCH SAFETY SYSTEMS OUTSIDE OF THE EXTENTS SUGGESTED TRENCH PROTECTION SHOWN ON THE CONSTRUCTION PLANS, ALL EXCAVATION SHALL CEASE AND THE CONTRACTOR SHALL IMMEDIATELY NOTIFY THE OWNER. THE CONTRACTOR SHALL BE RESPONSIBLE FOR SUBMITTING A REVISED TRENCH SAFETY PLAN. NO EXCAVATION SHALL RESUME UNTIL THE REVISED TRENCH SAFETY PLAN HAS BEEN APPROVED. (NO SEPARATE PAY)
- 8. THE CONTRACTOR SHALL ENSURE APPROVED TRENCH SAFETY PLANS ARE IMPLEMENTED. FAILURE TO ADHERE TO THE TRENCH SAFETY PLAN WILL RESULT IN A STOP WORK ORDER. NON-COMPLIANCE INCIDENTS MAY BE REPORTED TO OSHA.
- 9. TRENCHES OR EXCAVATIONS MAY NOT BE LEFT OPEN OVERNIGHT UNLESS AUTHORIZED IN WRITING BY THE OWNER. IN CASES WHERE TRENCHES ARE LEFT OPEN, THE CONTRACTOR MUST PROVIDE TRAFFIC—RATED, ANCHORED STEEL PLATE COVERS APPROVED BY THE OWNER.
- 10. CONTRACTOR SHALL PROTECT AND SUSPEND ALL EXISTING UTILITIES TO REMAIN.
- 11. ALL UTILITIES SHALL REMAIN IN SERVICE AT ALL TIMES. THE PROTECTION, TEMPORARY BYPASS PUMPING, ETC. OF ALL UTILITY LINES SHALL BE INCIDENTAL TO THE INSTALLATION OF THE PROPOSE UTILITIES. CONTRACTOR SHALL COORDINATE WITH UTILITY OWNERS.
- 12. ALL CONSTRUCTION OPERATIONS TO BE ACCOMPLISHED IN ACCORDANCE WITH APPLICABLE REGULATIONS OF THE U.S. OCCUPATIONAL SAFETY AND HEALTH ADMINISTRATION. COPIES OF OSHA STANDARDS MAY BE PURCHASED FROM THE U.S. GOVERNMENT PRINTING OFFICE.
- 13. ELECTRICAL LINES ARE LOCATED IN THE PROJECT AREA. THE ATTENTION OF THE CONTRACTOR IS DIRECTED TO STATE LAW (VERNON'S ANNOTATED TEXAS STATUTES, ARTICLE 1436 (C)) CONCERNING CONSTRUCTION OPERATIONS IN THE VICINITY OF ELECTRICAL LINES AND THE NEED FOR EFFECTIVE PRECAUTIONARY MEASURES.
- 14. ANY CHANGES OR REVISIONS TO THE UTILITY DESIGN MUST FIRST BE SUBMITTED TO THE LAGUNA MADRE WATER DISTRICT FOR REVIEW AND WRITTEN APPROVAL.
- 15. THE CONTRACTOR SHALL GIVE THE LAGUNA MADRE WATER DISTRICT 24 HOUR ADVANCE NOTICE PRIOR TO PLACEMENT OF ANY CONCRETE, TO PERMIT THE REVIEW OF FORMS. REINFORCING STEEL PLACEMENT, AND OTHER PREPARATIONS.



HALFF PROJECT NO. (AVO): 42852.001



GREEN, RUBIANO & ASSOCIATES

CONSULTING STRUCTURAL ENGINEERS

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SEAL



PROJECT

WALKOVER AT WHITECAP CIRCLE

SOUTH PADRE ISLAND, TEXAS


CLIENT

CITY OF SOUTH PADRE ISLAND

SOUTH PADRE ISLAND, TEXAS

> P: 956-761-3044 F: 956-761-3898



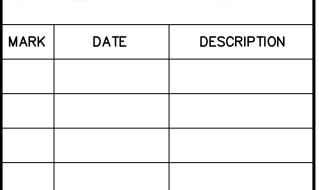

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GENERAL NOTES

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17. UNLESS OTHERWISE SPECIFIED BY THE ENGINEER, ALL UTILITY CONCRETE IS TO BE CLASS "A" (4000 PSI @ 28 DAYS). AND ALL REINFORCING STEEL TO BE ASTM A615 GRADE 60.

- 18. MAXIMUM LENGTH OF OPEN TRENCH TO BE 60', OR AS DIRECTED BY THE OWNER.
- ALL PIPE BEDDING MATERIAL SHALL CONFORM TO DETAILS AND THE MANUFACTURER'S RECOMMENDATION.

20. EXISTING SANITARY SEWER LINES SHALL BE KEPT IN SERVICE UNTIL PROPOSED SANITARY SEWER SYSTEM IMPROVEMENTS HAVE BEEN COMPLETED AND APPROVED BY THE OWNER.

WATER NOTES:

- WATER AND SEWER SERVICE LINE INSTALLATION SHALL MEET THE TCEQ AND INTERNATIONAL BUILDING CODE SEPARATION CONDITIONS AND PIPING REQUIREMENTS.
- 2. WHERE NEW WATERLINES ARE LESS THAN 9 FEET SEPARATION DISTANCE FROM WASTEWATER LINES, IN ANY DIRECTION, THE WATERLINE PIPE MATERIAL, MINIMUM SEPARATION DISTANCE, AND NECESSARY CASING SHALL BE IN ACCORDANCE WITH SPECIFICATION 33 14 13 WATERLINE PIPE WORK.
- 3. NO WATER JETTING ALLOWED; MECHANICAL COMPACTION REQUIRED.
- 4. THE FOLLOWING GUIDELINES AND PROCEDURES SHALL BE FOLLOWED BY ANY CONTRACTOR. SUB-CONTRACTOR, OR ANY PERSON OR PERSONS DOING ANY WORK ON LAGUNA MADRE WATER DISTRICT (LMWD) WATER LINES. TO INCLUDE WATER LINE EXTENSIONS. WATERLINE UPGRADES. WATER TAPS. OR ANY PHYSICAL WORK AND OR CONNECTIONS TO EXISTING WATERLINES OR ANY NEW WATERLINES THAT ARE TO BE ADOPTED BY LMWD.
- GENERAL CONTRACTOR (GC) MUST BE LICENSED/BONDED, GC WILL BE RESPONSIBLE FOR THE WORK AND MATERIALS ON WATERLINE UPGRADE.
- CONTRACTOR/COMPANY PROPOSING TO WORK ON LMWD WATERLINES WILL MAKE CONTACT AND MEET WITH LMWD PERSONNEL, TO BE WATER DISTRIBUTION MANAGER, WATER DISTRIBUTION ASSISTANT MGR AND DIRECTOR OF OPERATIONS, TO REVIEW ALL DOCUMENTS AND SHARE INFORMATION AS NEEDED. ALL LINE EXTENSIONS AND/OR UPGRADES WILL BE 6" MINIMUM.
- CONTRACTOR/COMPANY WILL ONLY USE LMWD APPROVED PARTS AND MATERIALS: LIST OF VENDORS USED BY LMWD PROVIDED:
- 1. HD SUPPLY (956) 350-0771
- 2. FERGUSON WATER WORKS (956) 584-8199
- 3. ACT PIPE & SUPPLY (956) 583-1558
- 4. AGUAWORKS PIPE (956) 831-2500
- CONTRACTOR INSTALLING NEW LINE IS RESPONSIBLE FOR REPLACING ANY EXISTING SERVICE CONNECTIONS WHERE ONE EXISTS. TO INCLUDE TAPPING SADDLE. CORPORATION STOP WITH CUT-OFF VALVE, MUNICIPEX TUBBING AND ANGLE VALVE WITH CUT-OFF. CONTRACTOR WILL ALSO PREP NEW WATERLINE TO CONNECT TO ANY AND ALL OTHER EXISTING WATERLINE.
- CONTRACTOR, SHALL FOLLOW STANDARD RULES OF WATER LINE INSTALLATIONS, TO INCLUDE PREPPING WATERLINE FOR HYDROSTATIC TESTING, BACTERIOLOGICAL SAMPLE COLLECTION, AND A FLUSHING POINT AS NEEDED.
- 10. CONTRACTOR WILL BE REQUIRED TO USE DEWATERING (WELL-POINT) SYSTEM, WHEN WORKING AT OR NEAR GROUND WATER TABLE.
- 11. CONTRACTOR WILL BE RESPONSIBLE TO RESTORE AREAS TO ORIGINAL CONDITIONS OR BETTER AS REQUIRED BY CITY/TOWN AND STATE CODES/ORDINANCES.
- 12. CONTRACTOR WILL BE RESPONSIBLE TO PERFORM A HYDRO-STATIC TEST (PRESSURE TEST) ON NEWLY INSTALLED LINE, USING THERE, OWN EQUIPMENT. LMWD PERSONNEL MUST BE PRESENT TO WITNESS TEST FROM BEGINNING TO END. STANDARD TEST IS (150 PSI FOR 2 HOURS), FAILURE TO MAINTAIN PRESSURE, IS A FAILED TEST.
- 13. LMWD WILL COLLECT THE BACTERIA-LOGICAL SAMPLE AND SUBMIT IT FOR TESTING. IF TEST IS NEGATIVE, INSPECTION OF WATERLINE IS COMPLETE AND LINE CAN BE PUT INTO SERVICE. AS REQUIRED BY TCEQ.
- 14. OFF-SITE TAP FEES MAY APPLY, IF LINE EXTENSION REQUIRES A 6" TAP.
- 15. LMWD WILL SUBMIT TX-DOT PERMITS AS NEEDED.
- 16. GC WILL SUBMIT A 1 YEAR WARRANTY ON NEWLY INSTALLED LINES, TO INCLUDE ANY AND ALL TYPE OF WORK CONTRACTOR DID ON EXISTING LINE AT TIE-IN. DATE OF NEWLY INSTALLED WATERLINE WILL BE WHEN IT IS PUT INTO SERVICE.
- 17. WITH THE EXCEPTION OF TX-DOT PERMITS, CONTRACTOR WILL BE RESPONSIBLE FOR ANY AND ALL PERMITS, PERMIT FEES, ADMINISTRATIVE FEES THAT MAY APPLY WITH THE WATERLINE UPGRADE/EXTENSION. LMWD PROVIDES WATER SERVICES TO PORT ISABEL, SOUTH PADRE ISLAND, LAGUNA VISTA.
- 18. CONTRACTOR INSTALLING/UPGRADING LINES WILL SIGN OFF ON;
 - A) HYDROSTATIC TEST
 - B) BACTERIOLOGICAL SAMPLE (PASSING SAMPLE)
 - C) RESTORED AREAS AS APPLICABLE
 - D) MET ALL REQUIREMENTS AS SET FORTH BY LMWD
- 19. LAGUNA MADRE WATER DISTRICT WILL PROVIDE SIGN OFF SHEET ON ALL ITEMS REQUESTED.
- 20. APPROVED CONTRACTORS
- 1. 5125 COMPANY (956) 867-5125
- 2. GNT PAVING (956) 592-1744
- 3. CORNETT CONSTRUCTION (956) 245-1009
- 4. CLOSNER CONSTRUCTION (956) 472-8613
- 5. PEDERSON CONSTRUCTION (956) 233-4471

POLLUTION PREVENTION / EROSION CONTROL NOTES:

- 1. CONTRACTOR SHALL OBTAIN A SWPPP PERMIT AND POST IT AT THE CONSTRUCTION SITE, IN ACCORDANCE WITH SPECIFICATION 01 57 13 TEMPORARY EROSION AND SEDIMENTATION CONTROL AND 01 57 23 TPDES REQUIREMENTS, PRIOR TO CONSTRUCTION.
- 2. ALL EROSION AND SEDIMENT CONTROL MEASURES SHALL BE IN PLACE PRIOR TO COMMENCING ANY EARTH DISTURBING ACTIVITY.
- 3. ALL EFFORTS SHALL BE MADE TO CONTAIN DISTURBED SOILS WITHIN THE EXTENTS OF PERIMETER EROSION AND SEDIMENT CONTROL MEASURES.
- 4. THE CONTRACTOR SHALL SEQUENCE ALL CONSTRUCTION IN SUCH A MANNER AS TO MINIMIZE THE AMOUNT AND EXTENTS OF DISTURBED EARTH.
- 5. A STABILIZED CONSTRUCTION EXIT IS REQUIRED AT ALL POINTS OF DESIGNATED EGRESS FROM THE LIMITS OF CONSTRUCTION. THE CONTRACTOR SHALL BE RESPONSIBLE FOR DETERMINING THE LOCATION(S) UNLESS OTHERWISE NOTED ON THE PLANS. THE LOCATION(S) OF THE STABILIZED CONSTRUCTION EXIT(S) MAY BE MODIFIED WITH RESPECT TO THE SEQUENCE OF CONSTRUCTION.
- 6. ALL EROSION AND SEDIMENT CONTROL MEASURES SHALL BE PROPERLY MAINTAINED DURING THE COURSE OF THEIR INTENDED USE.
- 7. ALL STAGING, MATERIAL STORAGE, STOCKPILE AND REFUSE AREAS SHALL REQUIRE APPLICABLE EROSION AND SEDIMENT CONTROL MEASURES.
- 8. ALL CONSTRUCTION DEBRIS SHALL BE CONTAINED WITHIN APPROPRIATE RECEPTACLES(ROLL-OFF CONTAINERS, DUMPSTERS, TRASH CANS, WIRE-MESH CAGES, ETC.) AND CONFINEDWITHIN PERIMETER EROSION AND SEDIMENT CONTROLS.
- 9. ALL EROSION AND SEDIMENT CONTROL MEASURES SHALL REMAIN IN PLACE DURING THE COURSE OF EARTH DISTURBING ACTIVITY AND UNTIL FINAL STABILIZATION IS ACHIEVED. STRUCTURAL MEASURES MAY BE REMOVED ONLY UPON FINAL PROJECT ACCEPTANCE BY THE OWNER OR AS DIRECTED BY THE
- 10. PERMANENT STABILIZATION SHALL BEGIN AS SOON AS PRACTICABLE OR AS DIRECTED BY THE OWNER.
- 11. DUST CONTROL SHALL BE IMPLEMENTED AS NECESSARY OR AS DIRECTED BY THE OWNER. DUST CONTROL MAY CONSIST OF WATERING OR OTHER METHODS APPROVED BY THE OWNER. DUST CONTROL AND ASSOCIATED WATERING OR OTHER METHOD SHALL BE SUBSIDIARY TO THE EROSION CONTROL BID ITEM IN THE UNIT PRICE SCHEDULE.
- 12. TRACKED DEBRIS SHALL BE SWEPT AT THE END OF EACH WORKDAY OR AS DIRECTED BY THE
- 13. ALL DISCHARGES ASSOCIATED WITH DEWATERING OPERATIONS SHALL IMPLEMENT APPROPRIATE EROSION AND SEDIMENT CONTROL MEASURES. MEASURES MAY INCLUDE BUT ARE NOT LIMITED TO SEDIMENTATION BASINS OR FILTER SOCKS.
- 14. CONCRETE WASH-WATER SHALL NOT BE DISCHARGED DIRECTLY INTO A STORM SEWER SYSTEM OR RECEIVING STREAM. ALL WASH ACTIVITIES MUST BE PERFORMED WITHIN THE EXTENTS OF ESTABLISHED EROSION AND SEDIMENT CONTROL MEASURES OR DESIGNATED AREAS APPROVED BY THE OWNER.
- 15. SEDIMENT SHALL BE CLEARED FROM ALL STORM SEWER PIPES, CULVERTS AND APPURTENANCES WITHIN THE LIMITS OF CONSTRUCTION PRIOR TO FINAL PROJECT ACCEPTANCE. SEDIMENT SHALL BE PROPERLY DISPOSED.
- 16. STAGING, STOCKPILE AND EQUIPMENT STORAGE AREAS SHALL NOT BE LOCATED WITHIN THE EXTENTS OF ANY TREE DRIPLINES.

LAGUNA MADRE WATER DISTRICT SUBDIVISION AND EXTENSION STANDARDS:

- 1. UTILITY BONDS: COPY OF BONDS FROM SUBDIVISION JURISDICTION
- 2. WARRANTY: 1 YEAR FROM DATE OF PROJECT COMPLETION
- 3. AS BUILT DRAWINGS: FURNISH AND CERTIFIED BY PE OR RPLS
- 4. PRE CONSTRUCTION MEETING REQUIRED
- NOTIFICATION ONE CALL
- 6. TESTING REQUIREMENTS:
- 6.1. TO BE COMPLETE AFTER ALL UTILITIES INSTALLED
- 6.2. 150 PSI FOR 2 HOURS FOR WATER LINES, HYDROSTATIC TESTED
- 6.3. 100 PSI FOR 2 HOURS FOR FORCE MAIN LINES, HYDROSTATIC TESTED
- 6.4. 4 PSI FOR 10 MINUTES FOR SEWER GRAVITY LINES, AIR TESTED
- 6.5. WATER LINES TO BE STERILIZED (HTH) 24 HOURS, THEN FLUSHED, AND BACTERIOLOGICAL
- 6.6. AFTER BACTERIOLOGICAL TEST APPROVED, THEN INTERCONNECT TO MAIN LINE.
- 7. METERS
- 7.1.METERS ARE PROVIDED BY DISTRICT PAID FOR BY DEVELOPER
- 7.2.METER BOX ARE PROVIDED BY DISTRICT ON 5/8", 1", AND 2" METERS.
- 7.3.METER VAULT MUST BE INSTALLED BY THE DEVELOPER FOR 4", 6", 8", 10" METERS OR LARGER.
- 8. BACKFLOW ASSEMBLY
- 8.1. REQUIRED BY DISTRICT PER STATE REGULATIONS ON FIRELINE METERS, FIRE PROTECTION METERS, IRRIGATIONS METERS,
- 8.2. MOTEL/HOTELS OVER 4 STORIES HIGH, RESTAURANTS WITH FOUNTAIN DRINKS, ASSEMBLY TESTED BY CERTIFIED TESTER
- 8.3. WHEN INSTALLED AND ONCE A YEARTHEREAFTER, REPORT TURNED IN TO BACKFLOW PREVENTION DEPARTMENT AT DISTRICT.
- 8.4. BACKFLOW ASSEMBLY PAID BY THE DEVELOPER INSTALLED AFTER THE METER BEFORE ANY SPIGOT OR SINK OUTFLOW.
- 8.5. BACKLOW ASSEMBLY APPROVED BY THE DISTRICT ON EACH APPLICATION.



GENERAL LEGEND

PROPOSED

XX=XX.XX

— WTR —

EXISTING

_____ STORM SEWER

-- w -- water

--- ww --- SAN. SEWER GRAVITY / FORCEMAIN

XX=XX.XX SPOT ELEVATION

ASPHALT PAVEMENT

CONCRETE PAVEMENT

PARKING LOT PAVERS

LANDSCAPE / SOD

DRINKING FOUNTAIN

CONCRETE ADA RAMP WITH **DETECTABLE WARNING**

TRASH CAN

BENCH

BIKE RACK

PROPOSED

0

EXISTING

0

INLET

SANITARY SEWERMANHOLE

WATER GATE VALVE & BOX

WATER METER

FIRE HYDRANT

LIGHT POLE

POWER POLE

TRAFFIC SIGN

GUY WIRE

—EX UGE — UNDERGROUND ELECTRIC

FENCE

— — EX OHE — OVERHEAD ELECTRIC

SANITARY CLEAN OUT

SANITARY SERVICE

BIKE LANE DELINEATOR

TELEPHONE PEDISTAL

HALFF PROJECT NO. (AVO): 42852.001





GREEN. RUBIANO & ASSOCIATES

CONSULTING STRUCTURAL ENGINEERS 1220 WEST HARRISON HARLINGEN, TEXAS 78550 PH: (956)428-4461 FAX: (956)428-0287

FIRM REGISTRATION #F-4145

SEAL



PROJECT

WALKOVER AT WHITECAP CIRCLE

SOUTH PADRE ISLAND **TEXAS**

CLIENT

CITY OF SOUTH PADRE ISLAND



SOUTH PADRE ISLAND, TEXAS P: 956-761-3044




MARK	DATE	DESCRIPTION

PROJECT NO.	1065–16
DATE	04-22-2022
DRAWN BY	TE
CHECKED BY	RA
SCALE	AS SHOWN
SHEET TITLE	

GENERAL NOTES AND LEGEND

SHEET NO.

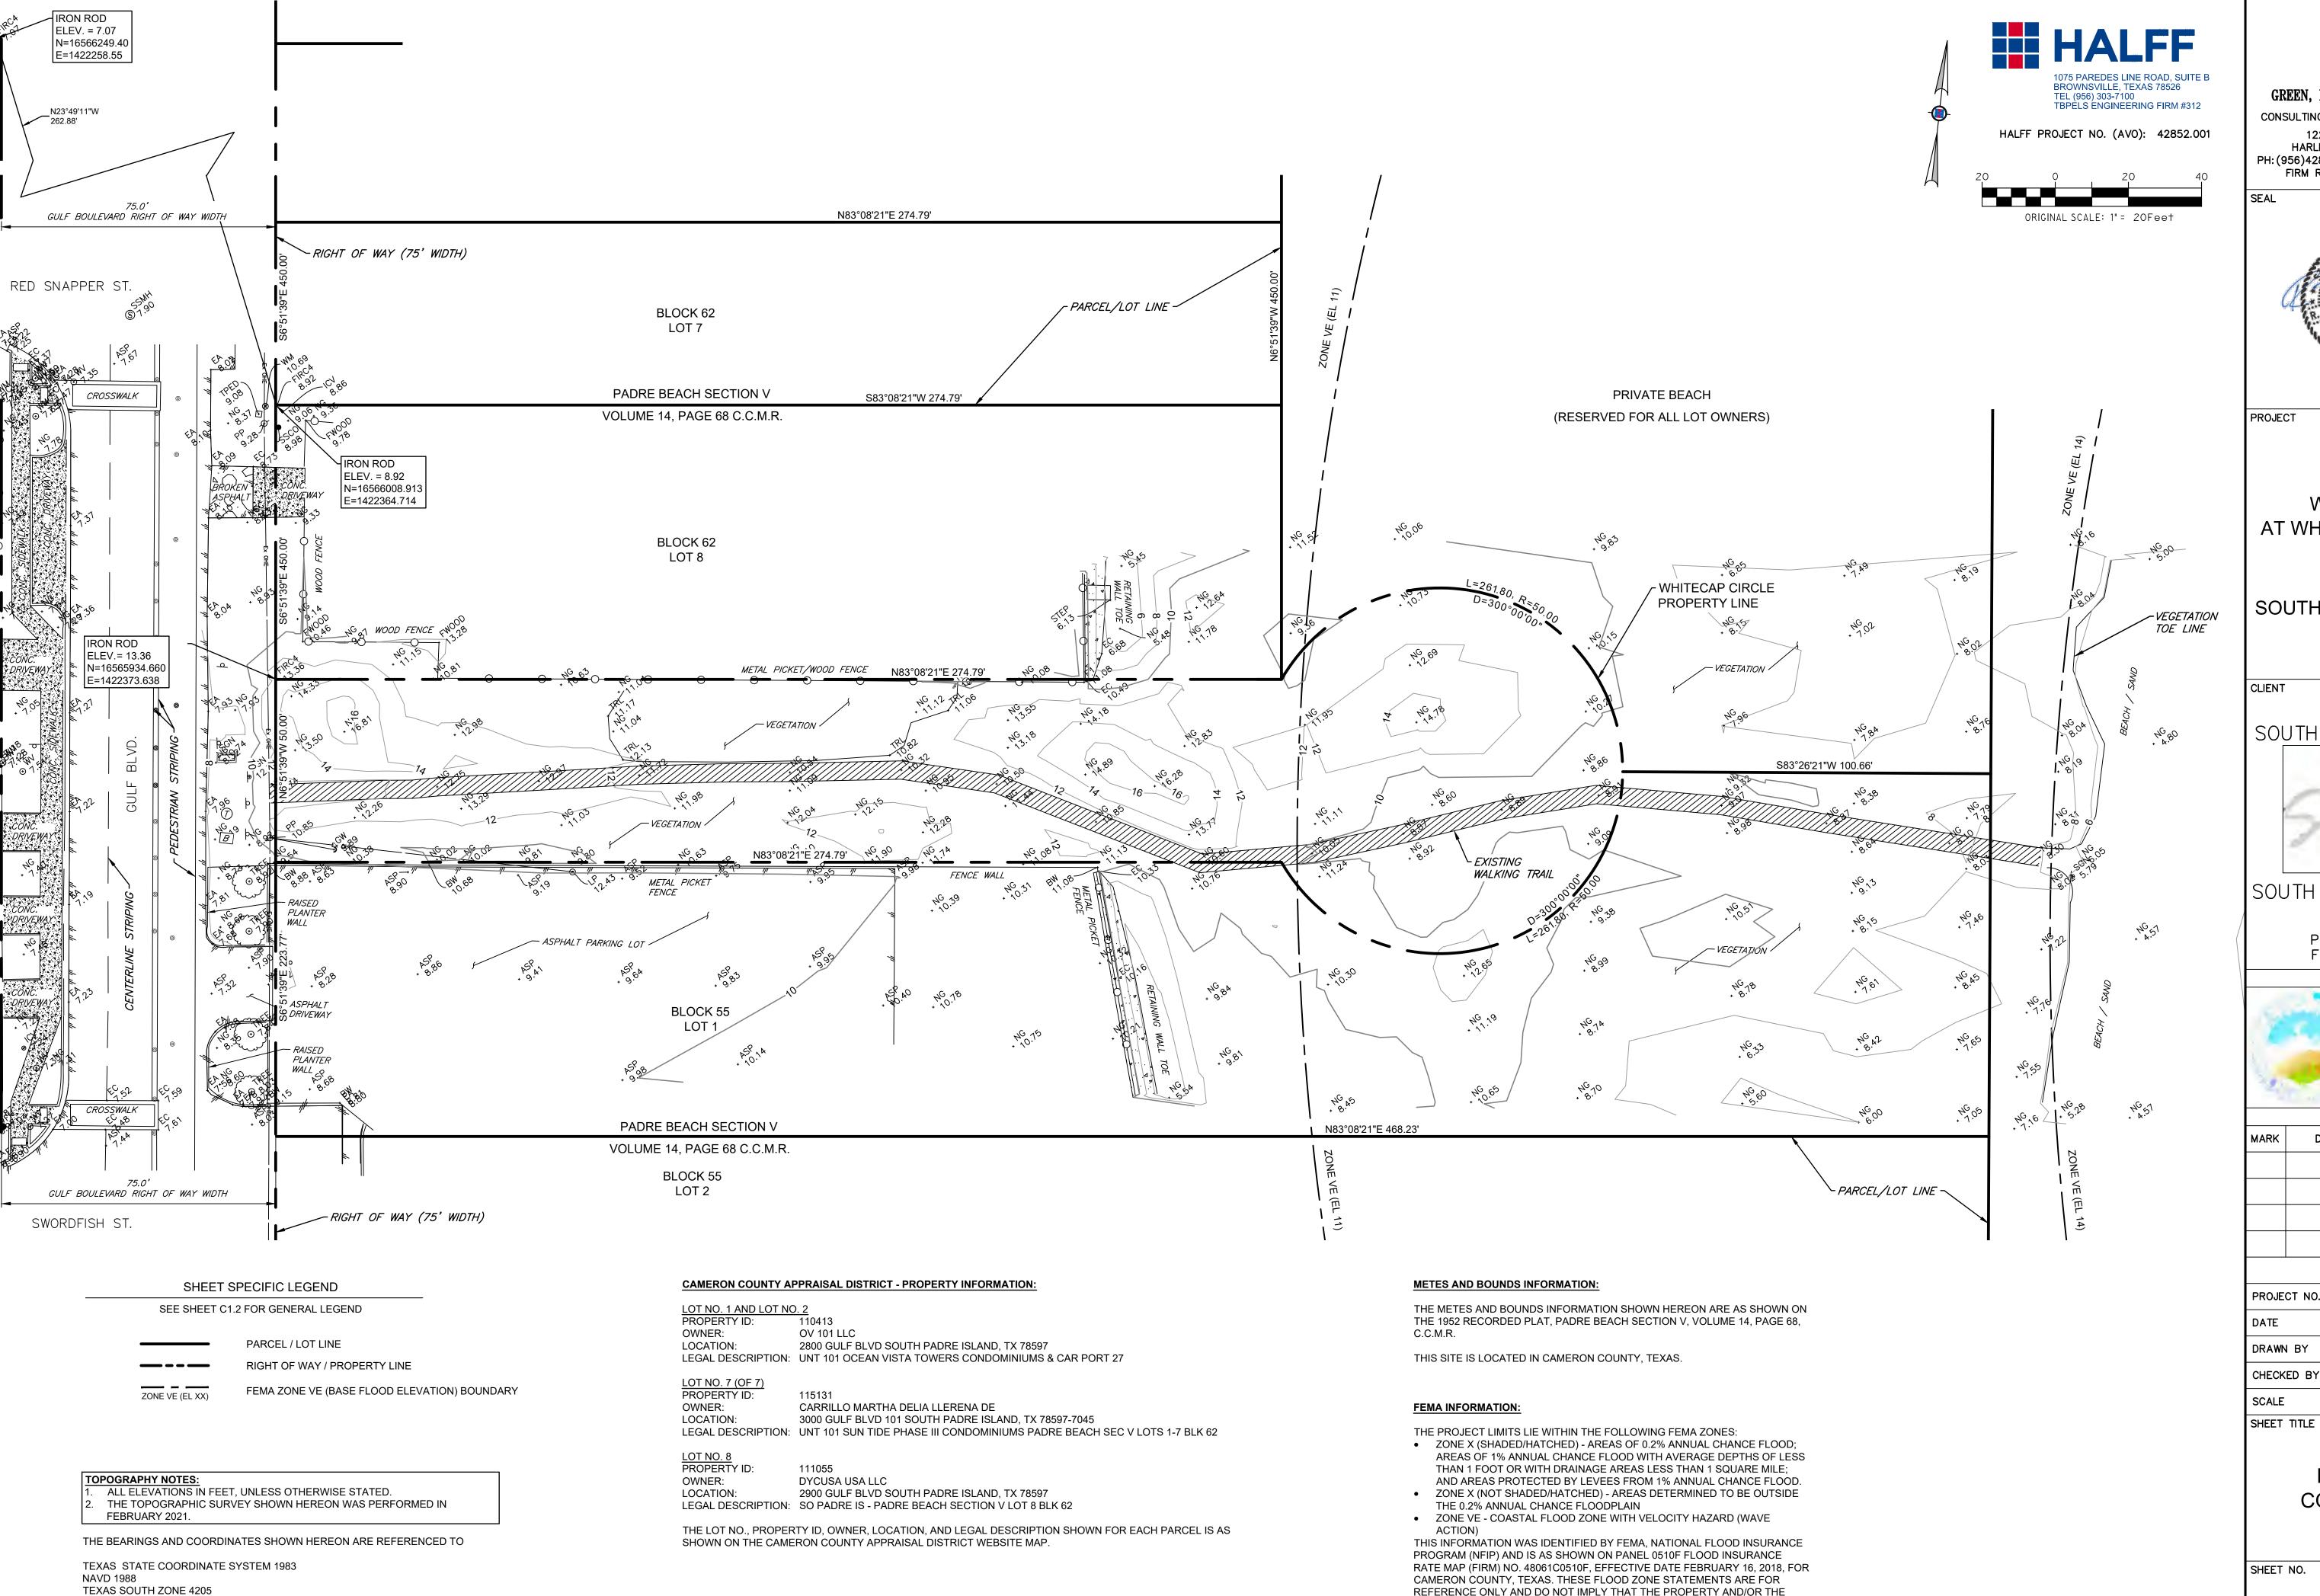

REFERENCE ONLY AND DO NOT IMPLY THAT THE PROPERTY AND/OR THE STRUCTURES WITHIN THE PROJECT LIMITS WILL BE FREE FROM FLOODING

OR FLOOD DAMAGE.

GREEN, RUBIANO & ASSOCIATES


CONSULTING STRUCTURAL ENGINEERS 1220 WEST HARRISON HARLINGEN, TEXAS 78550 PH: (956)428-4461 FAX: (956)428-0287 FIRM REGISTRATION #F-4145



WALKOVER AT WHITECAP CIRCLE

SOUTH PADRE ISLAND, **TEXAS**


CITY OF

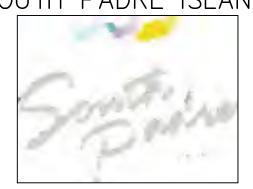

SOUTH PADRE ISLAND, TEXAS


P: 956-761-3044 F: 956-761-3898




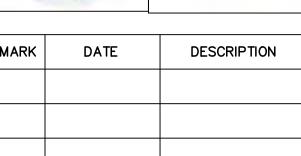



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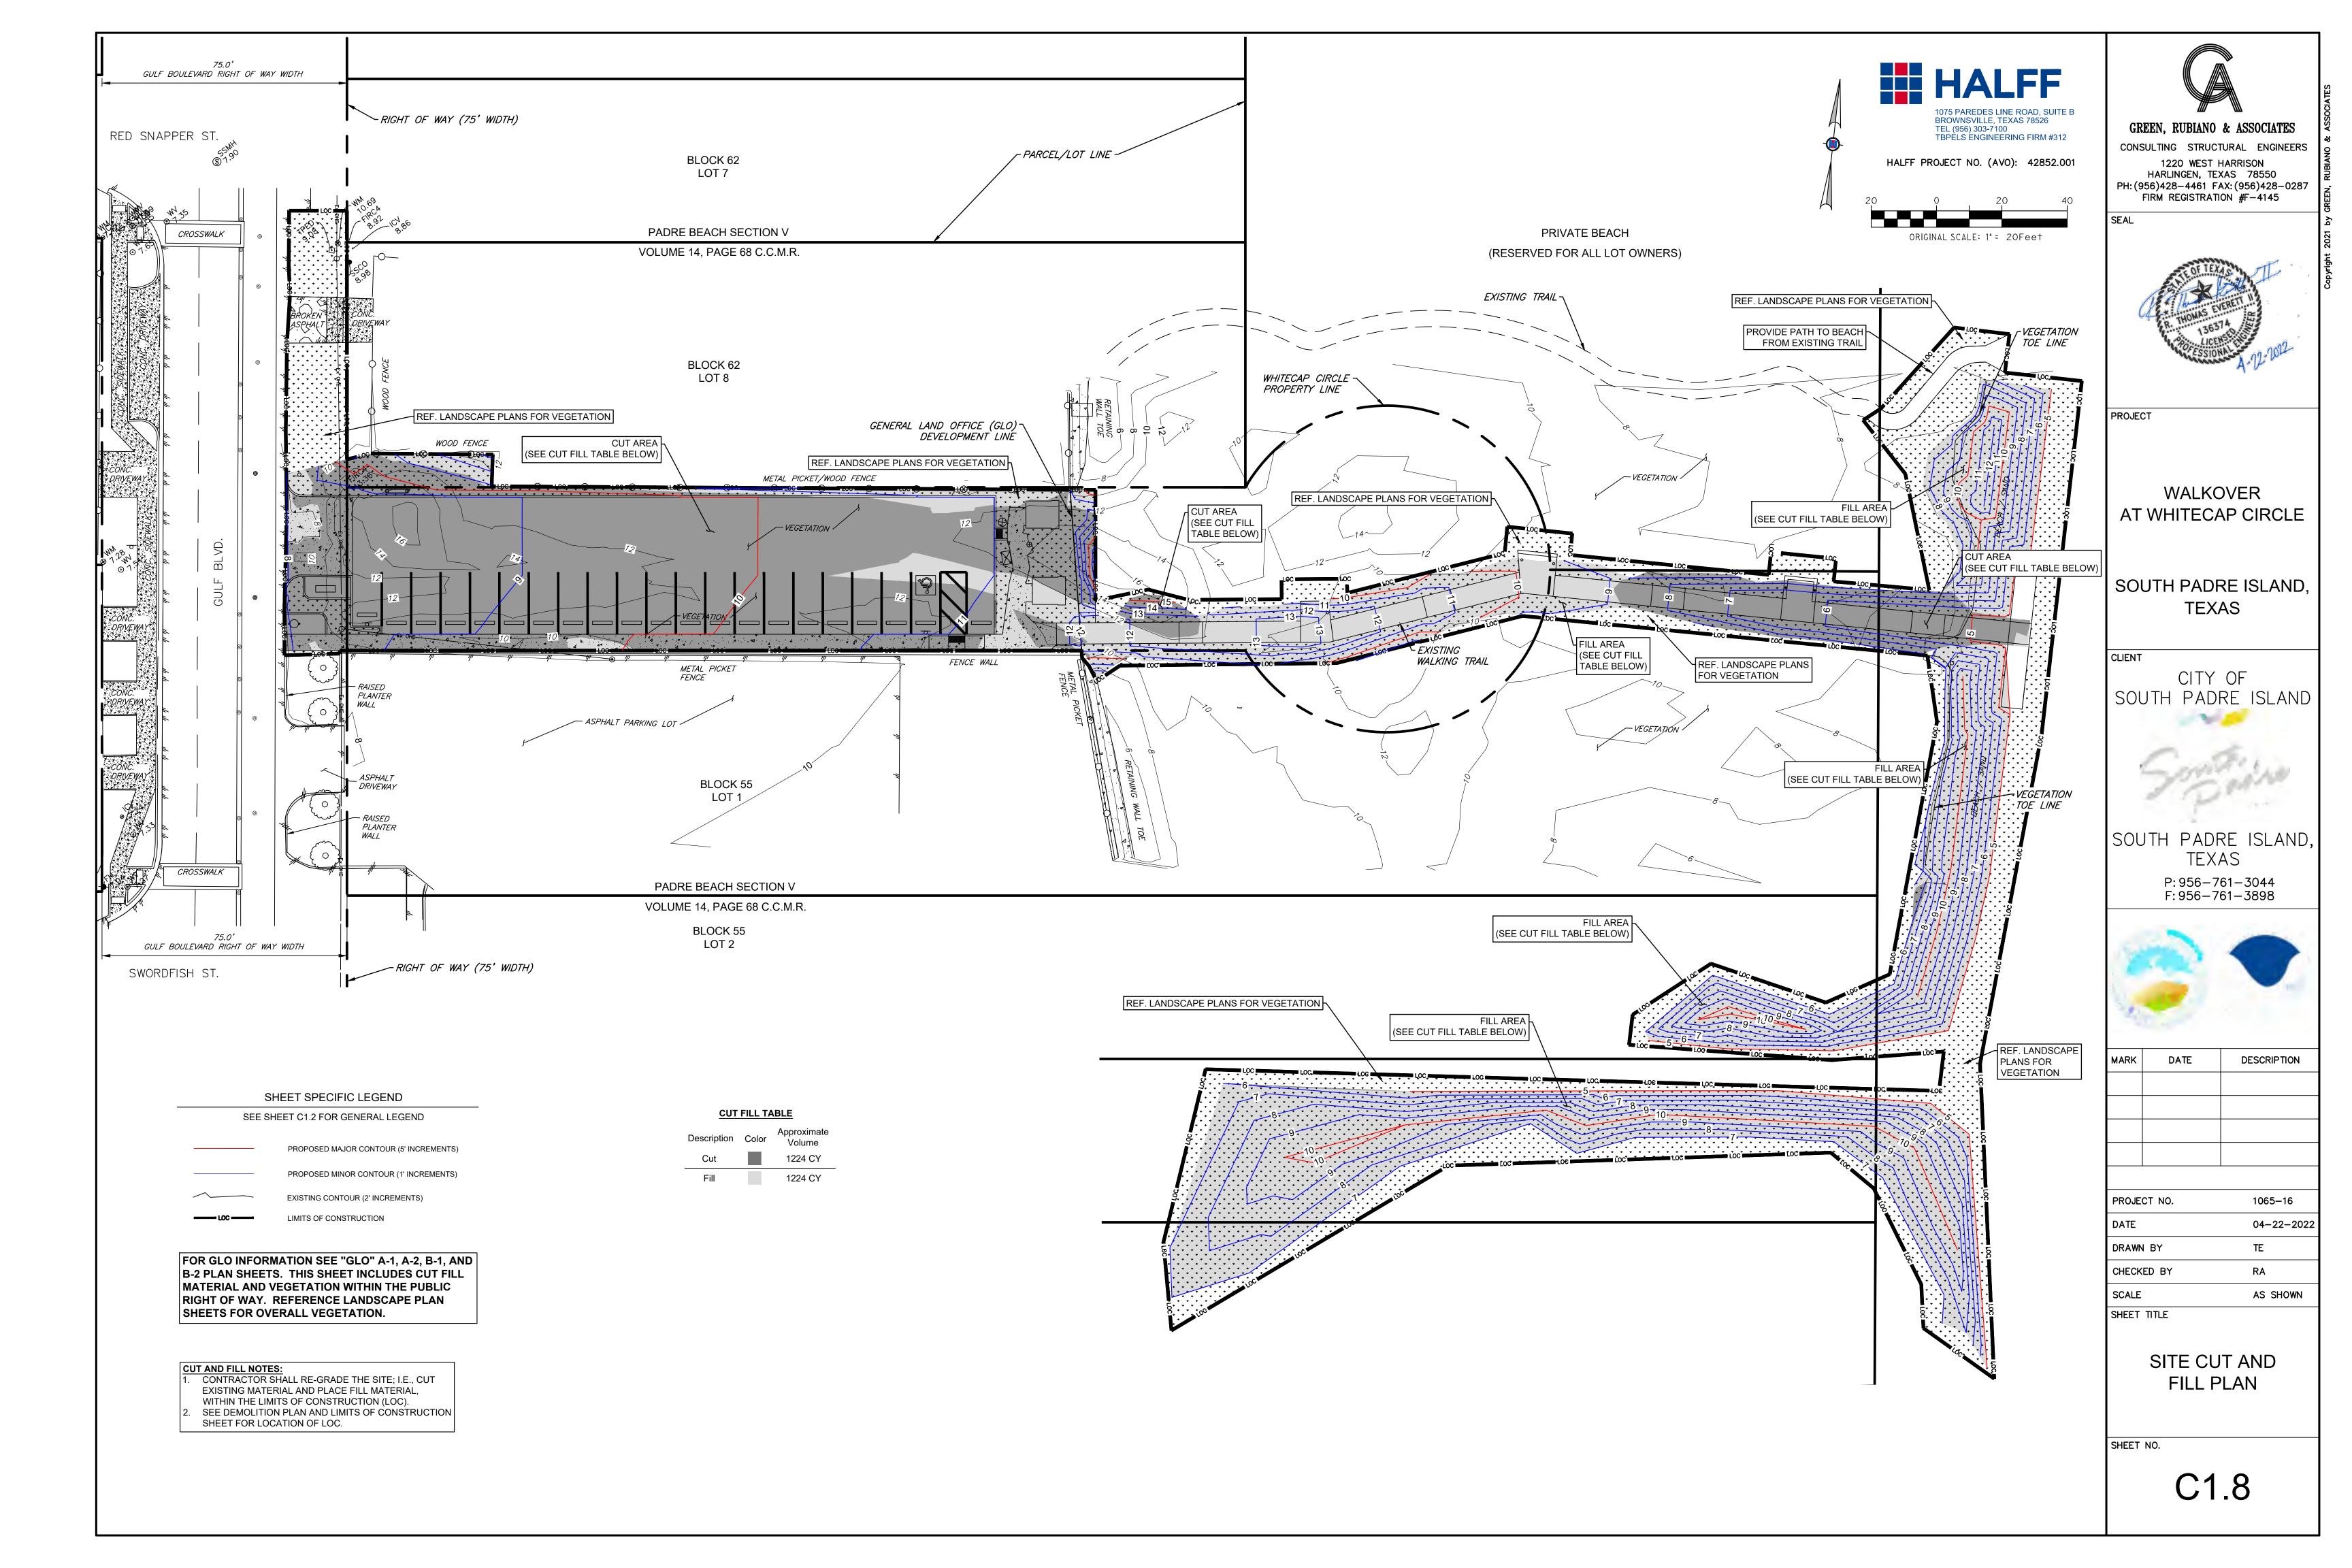
EXISTING CONDITIONS




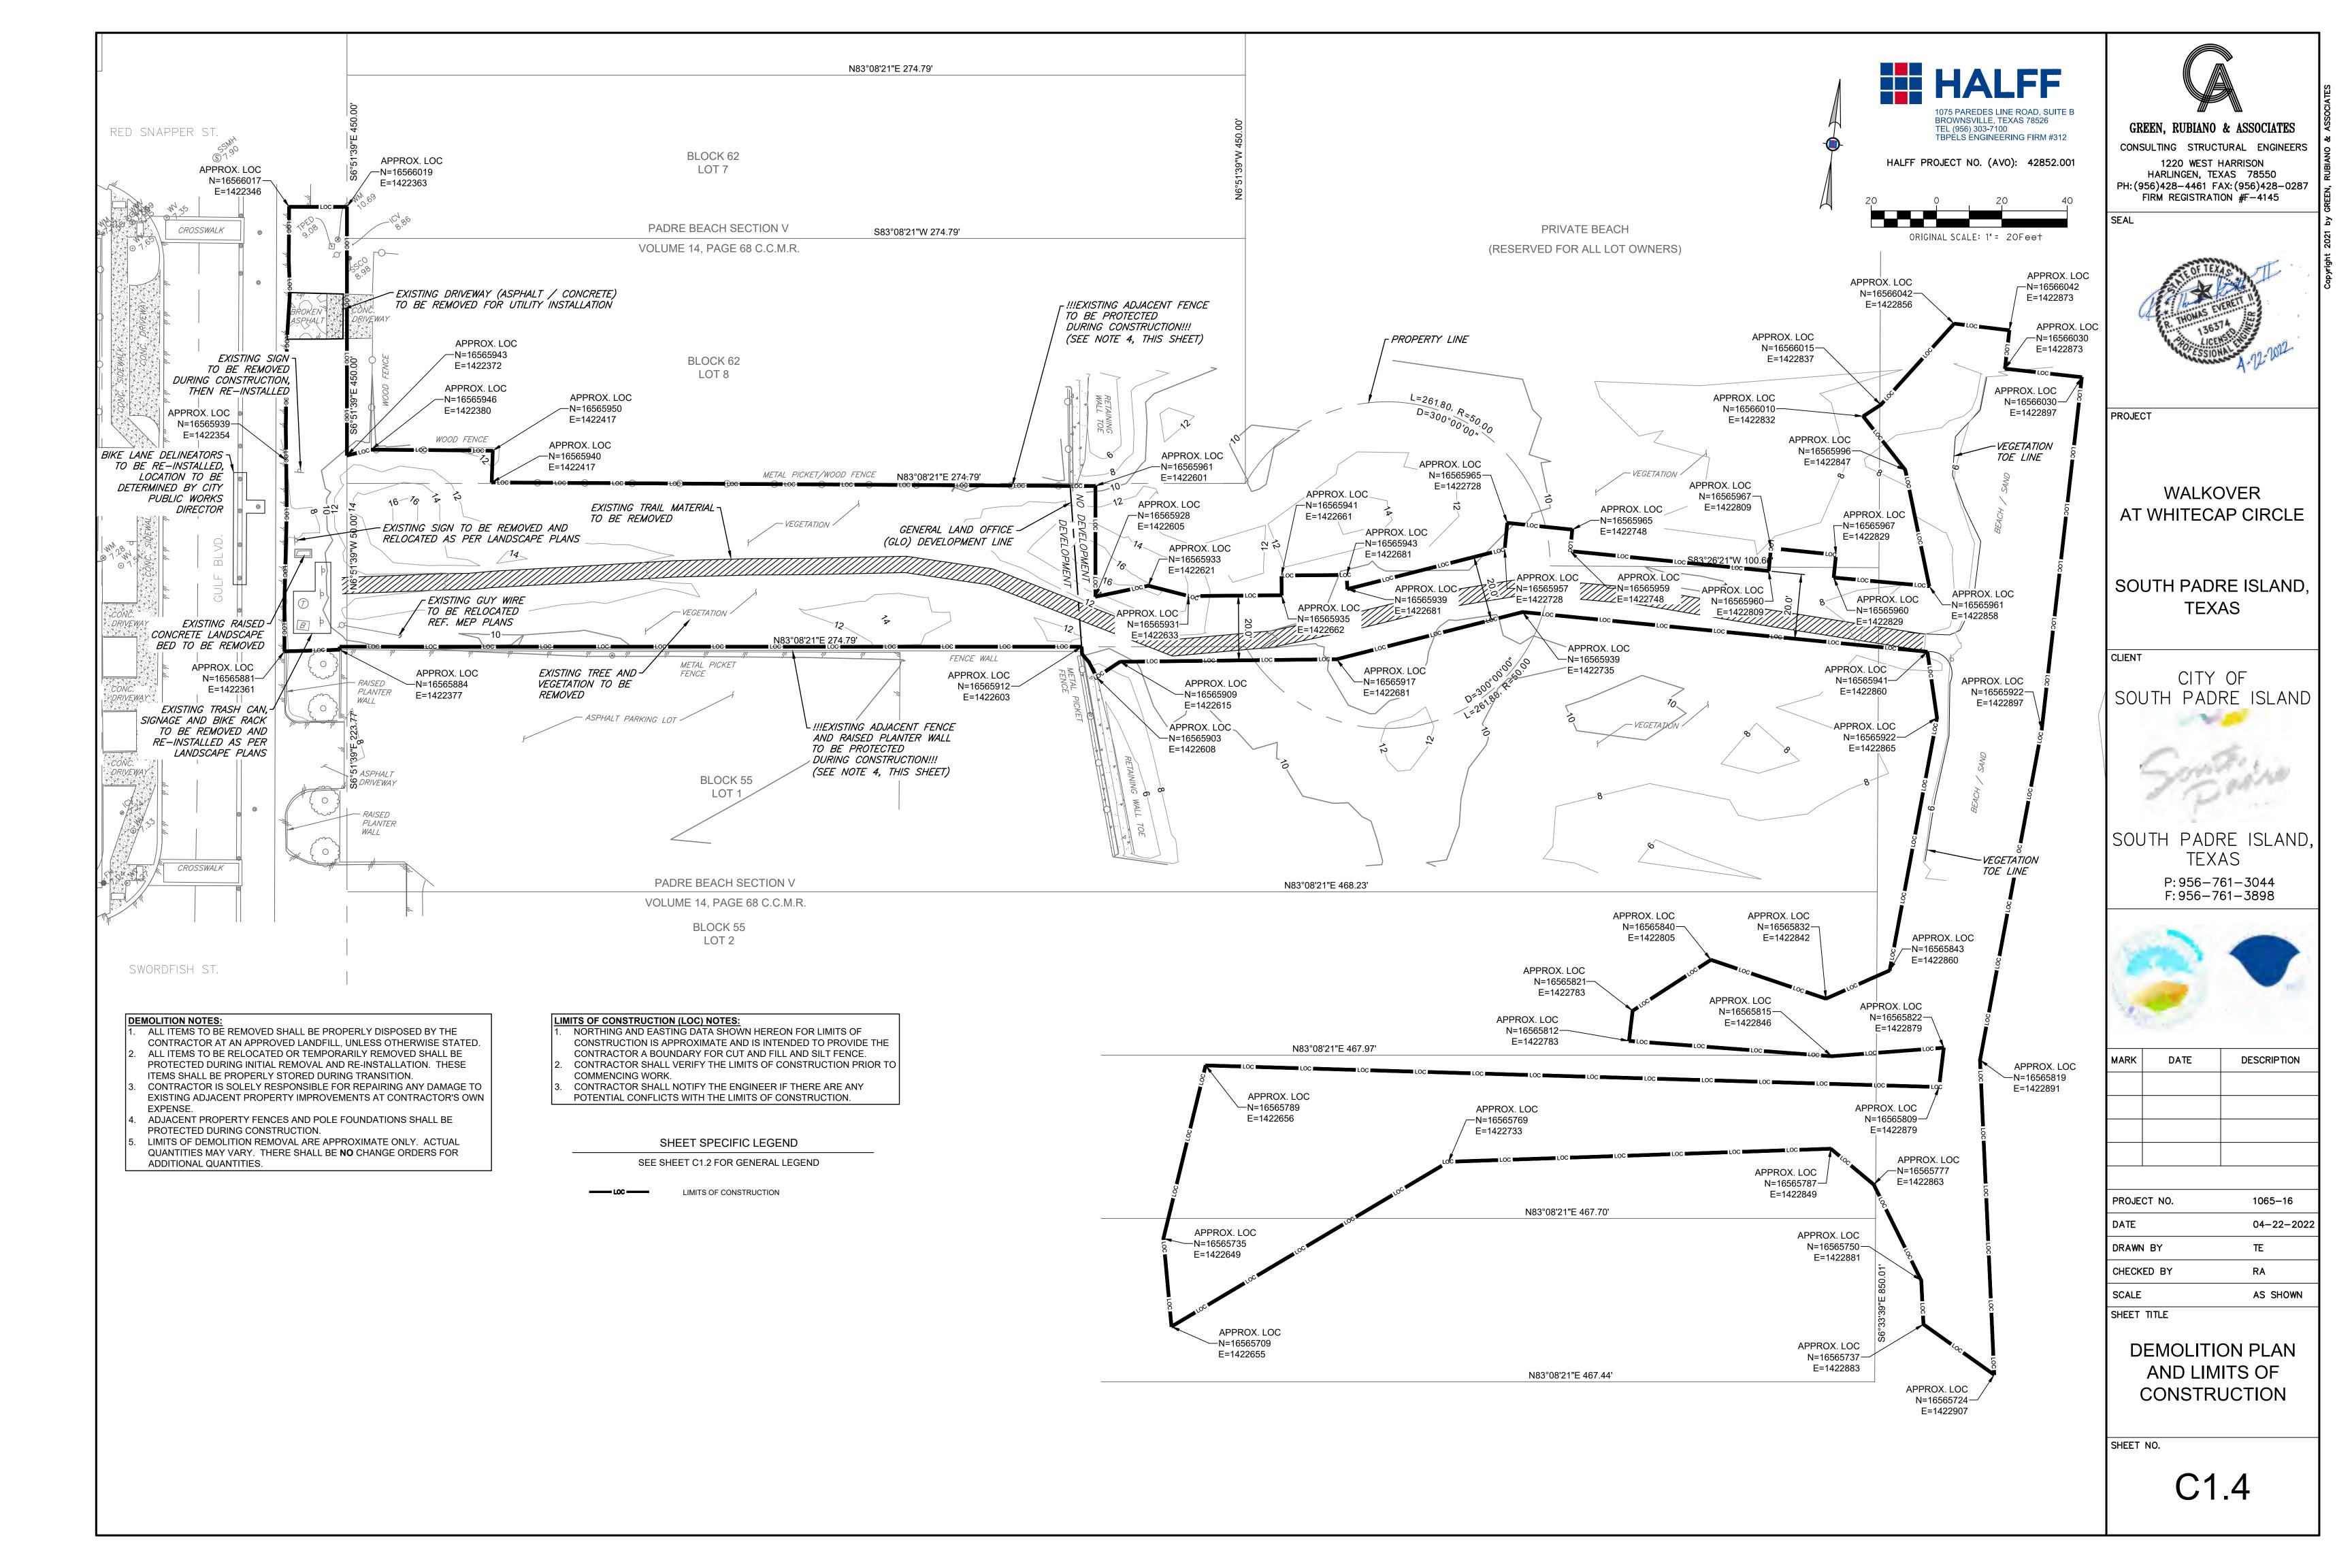


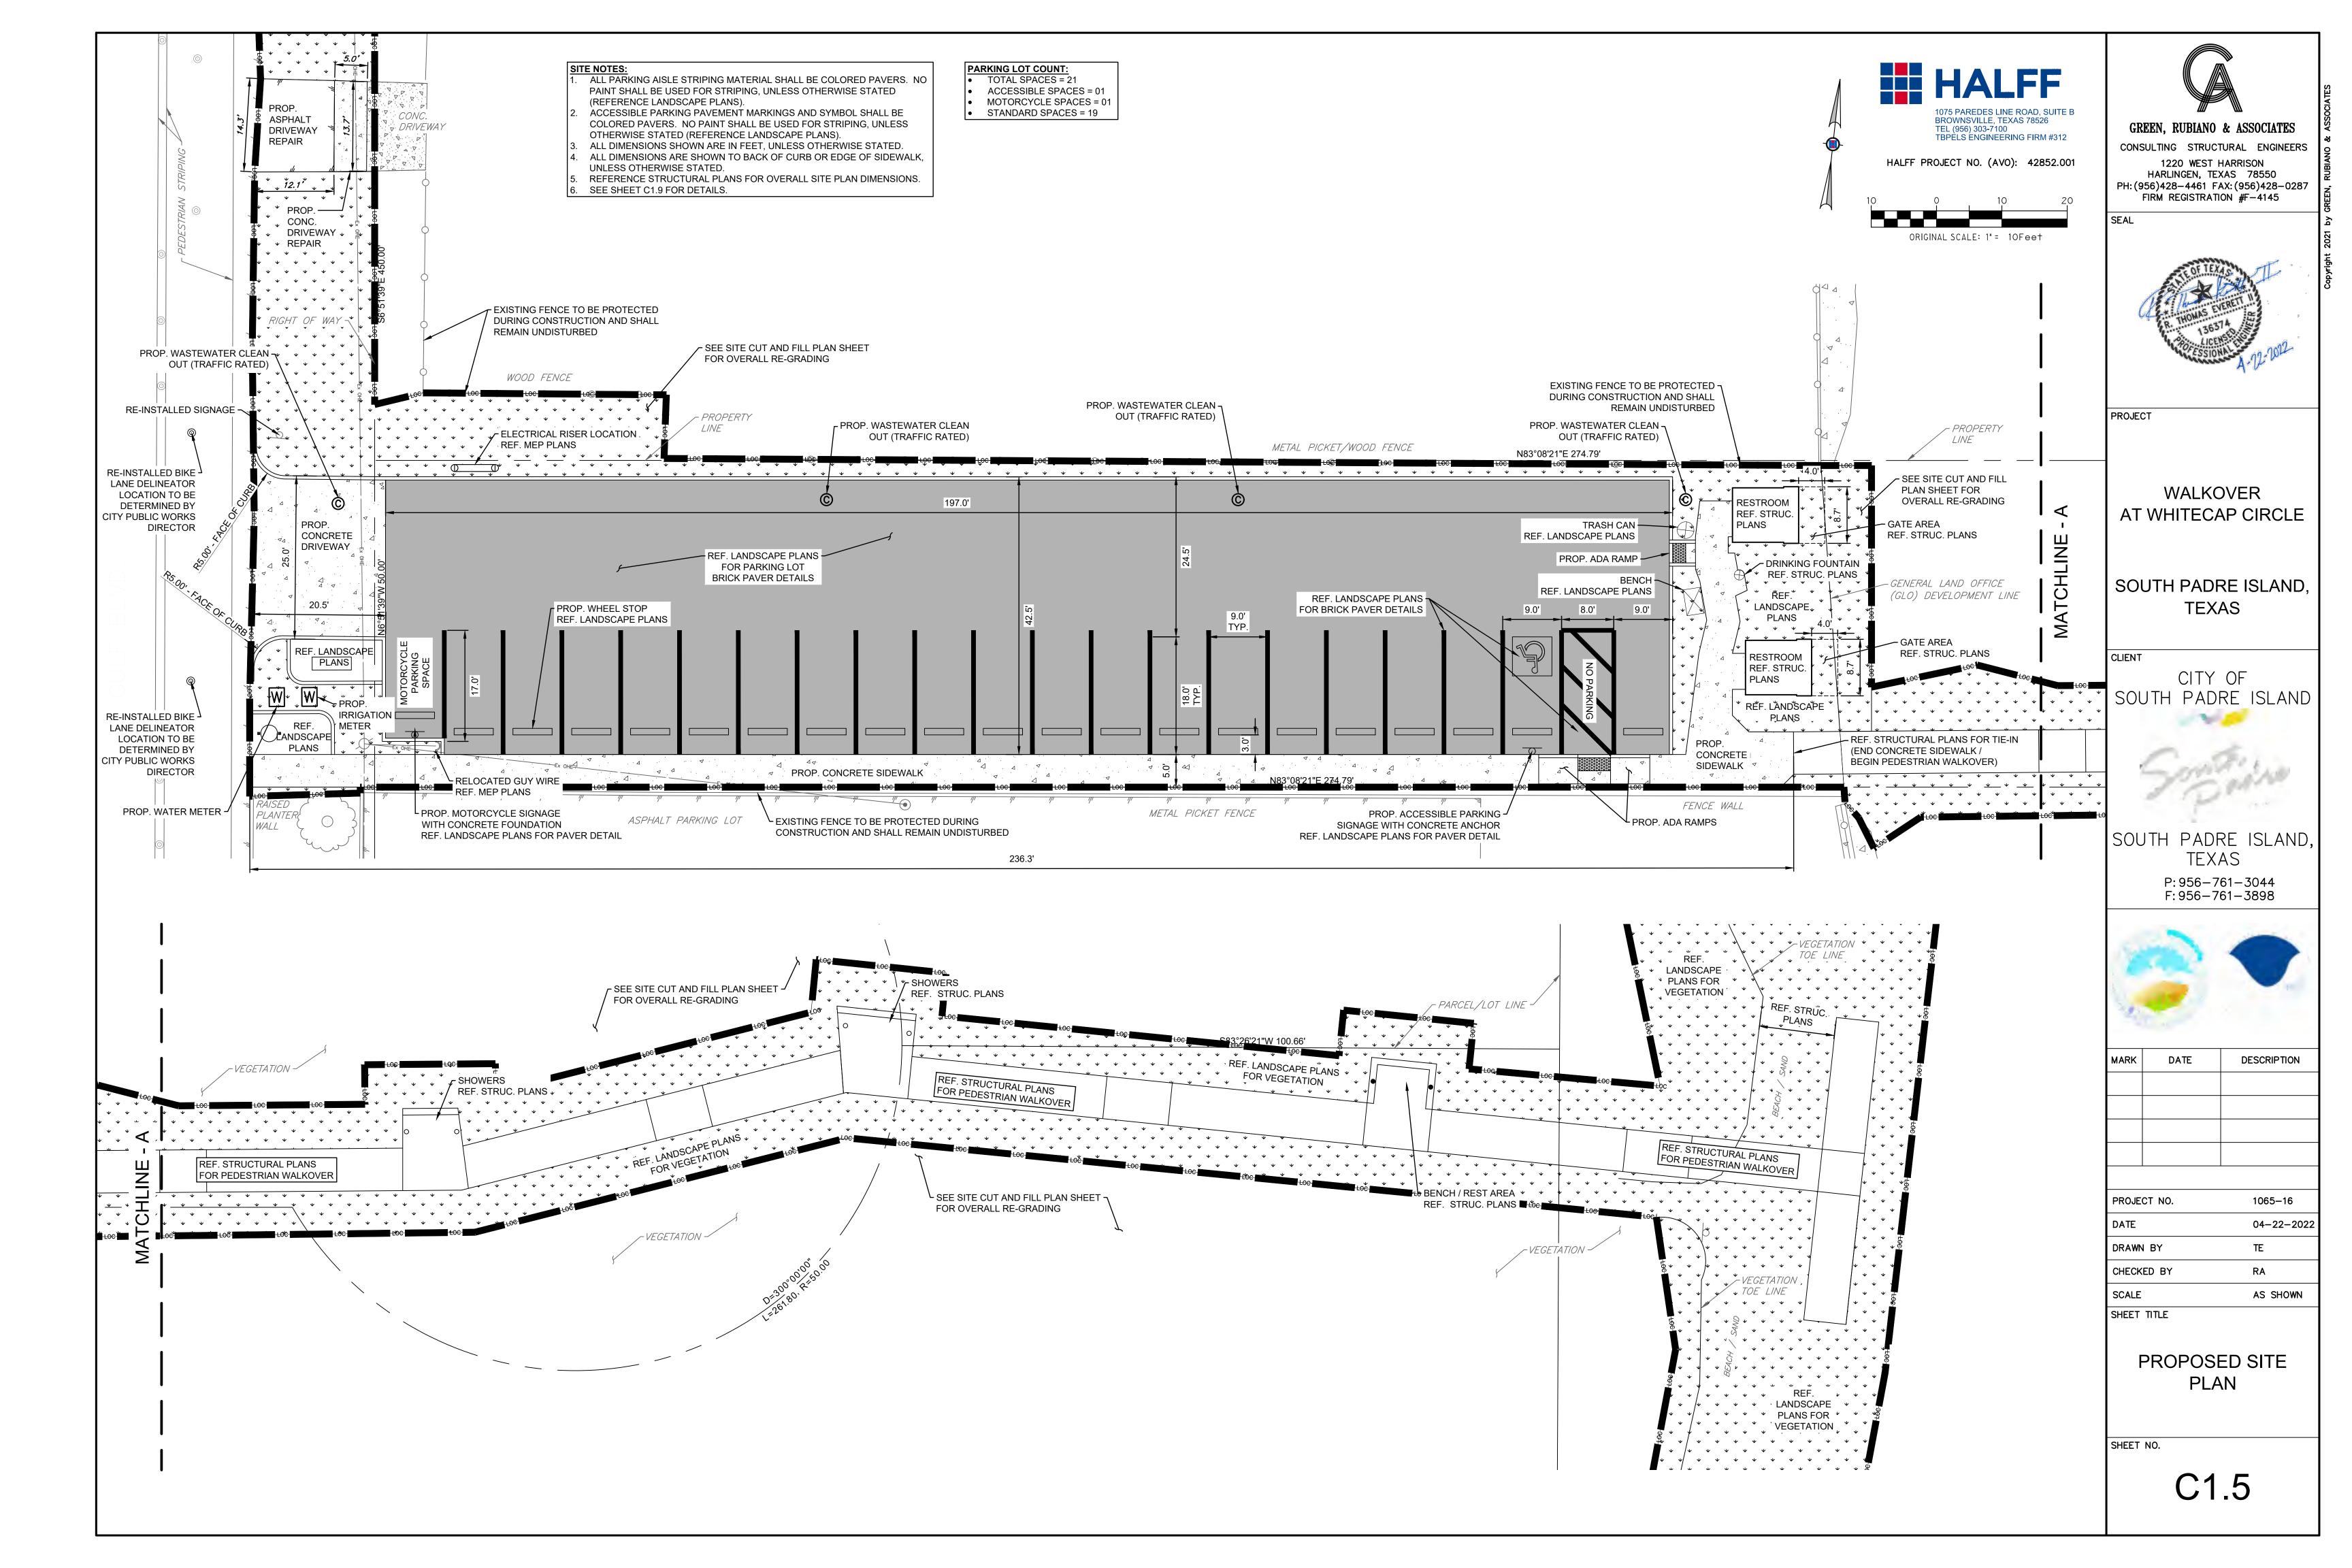

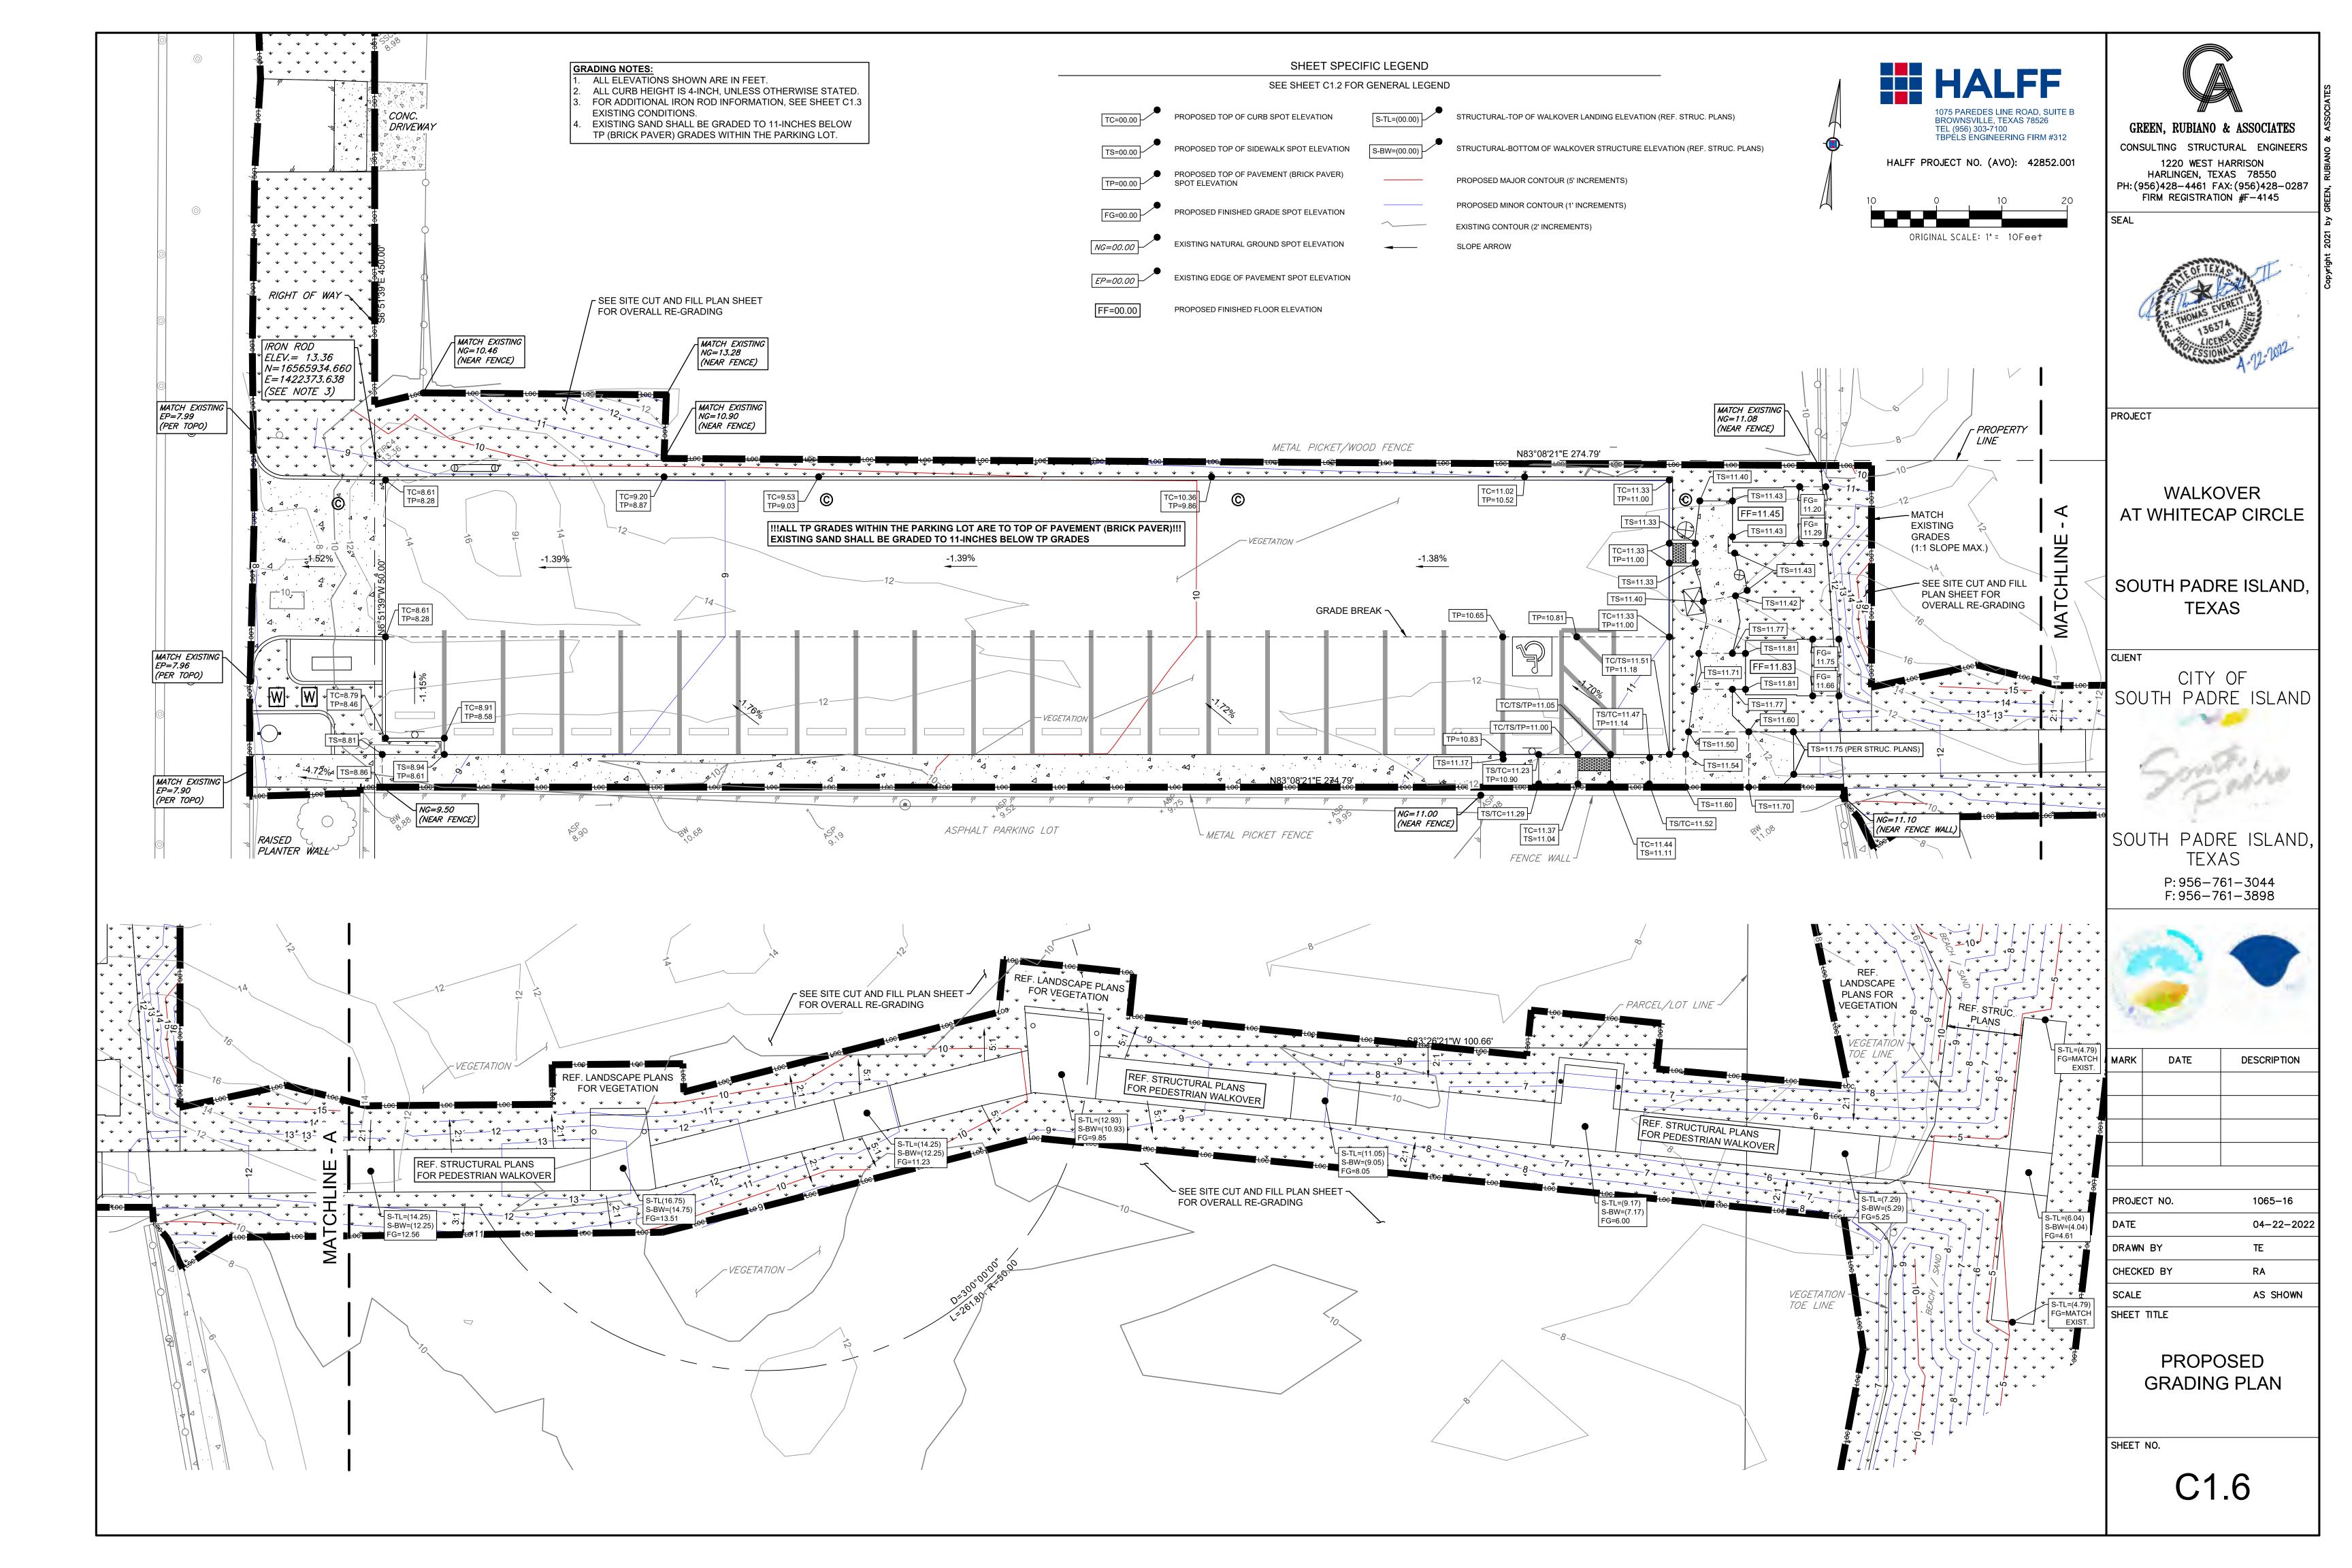

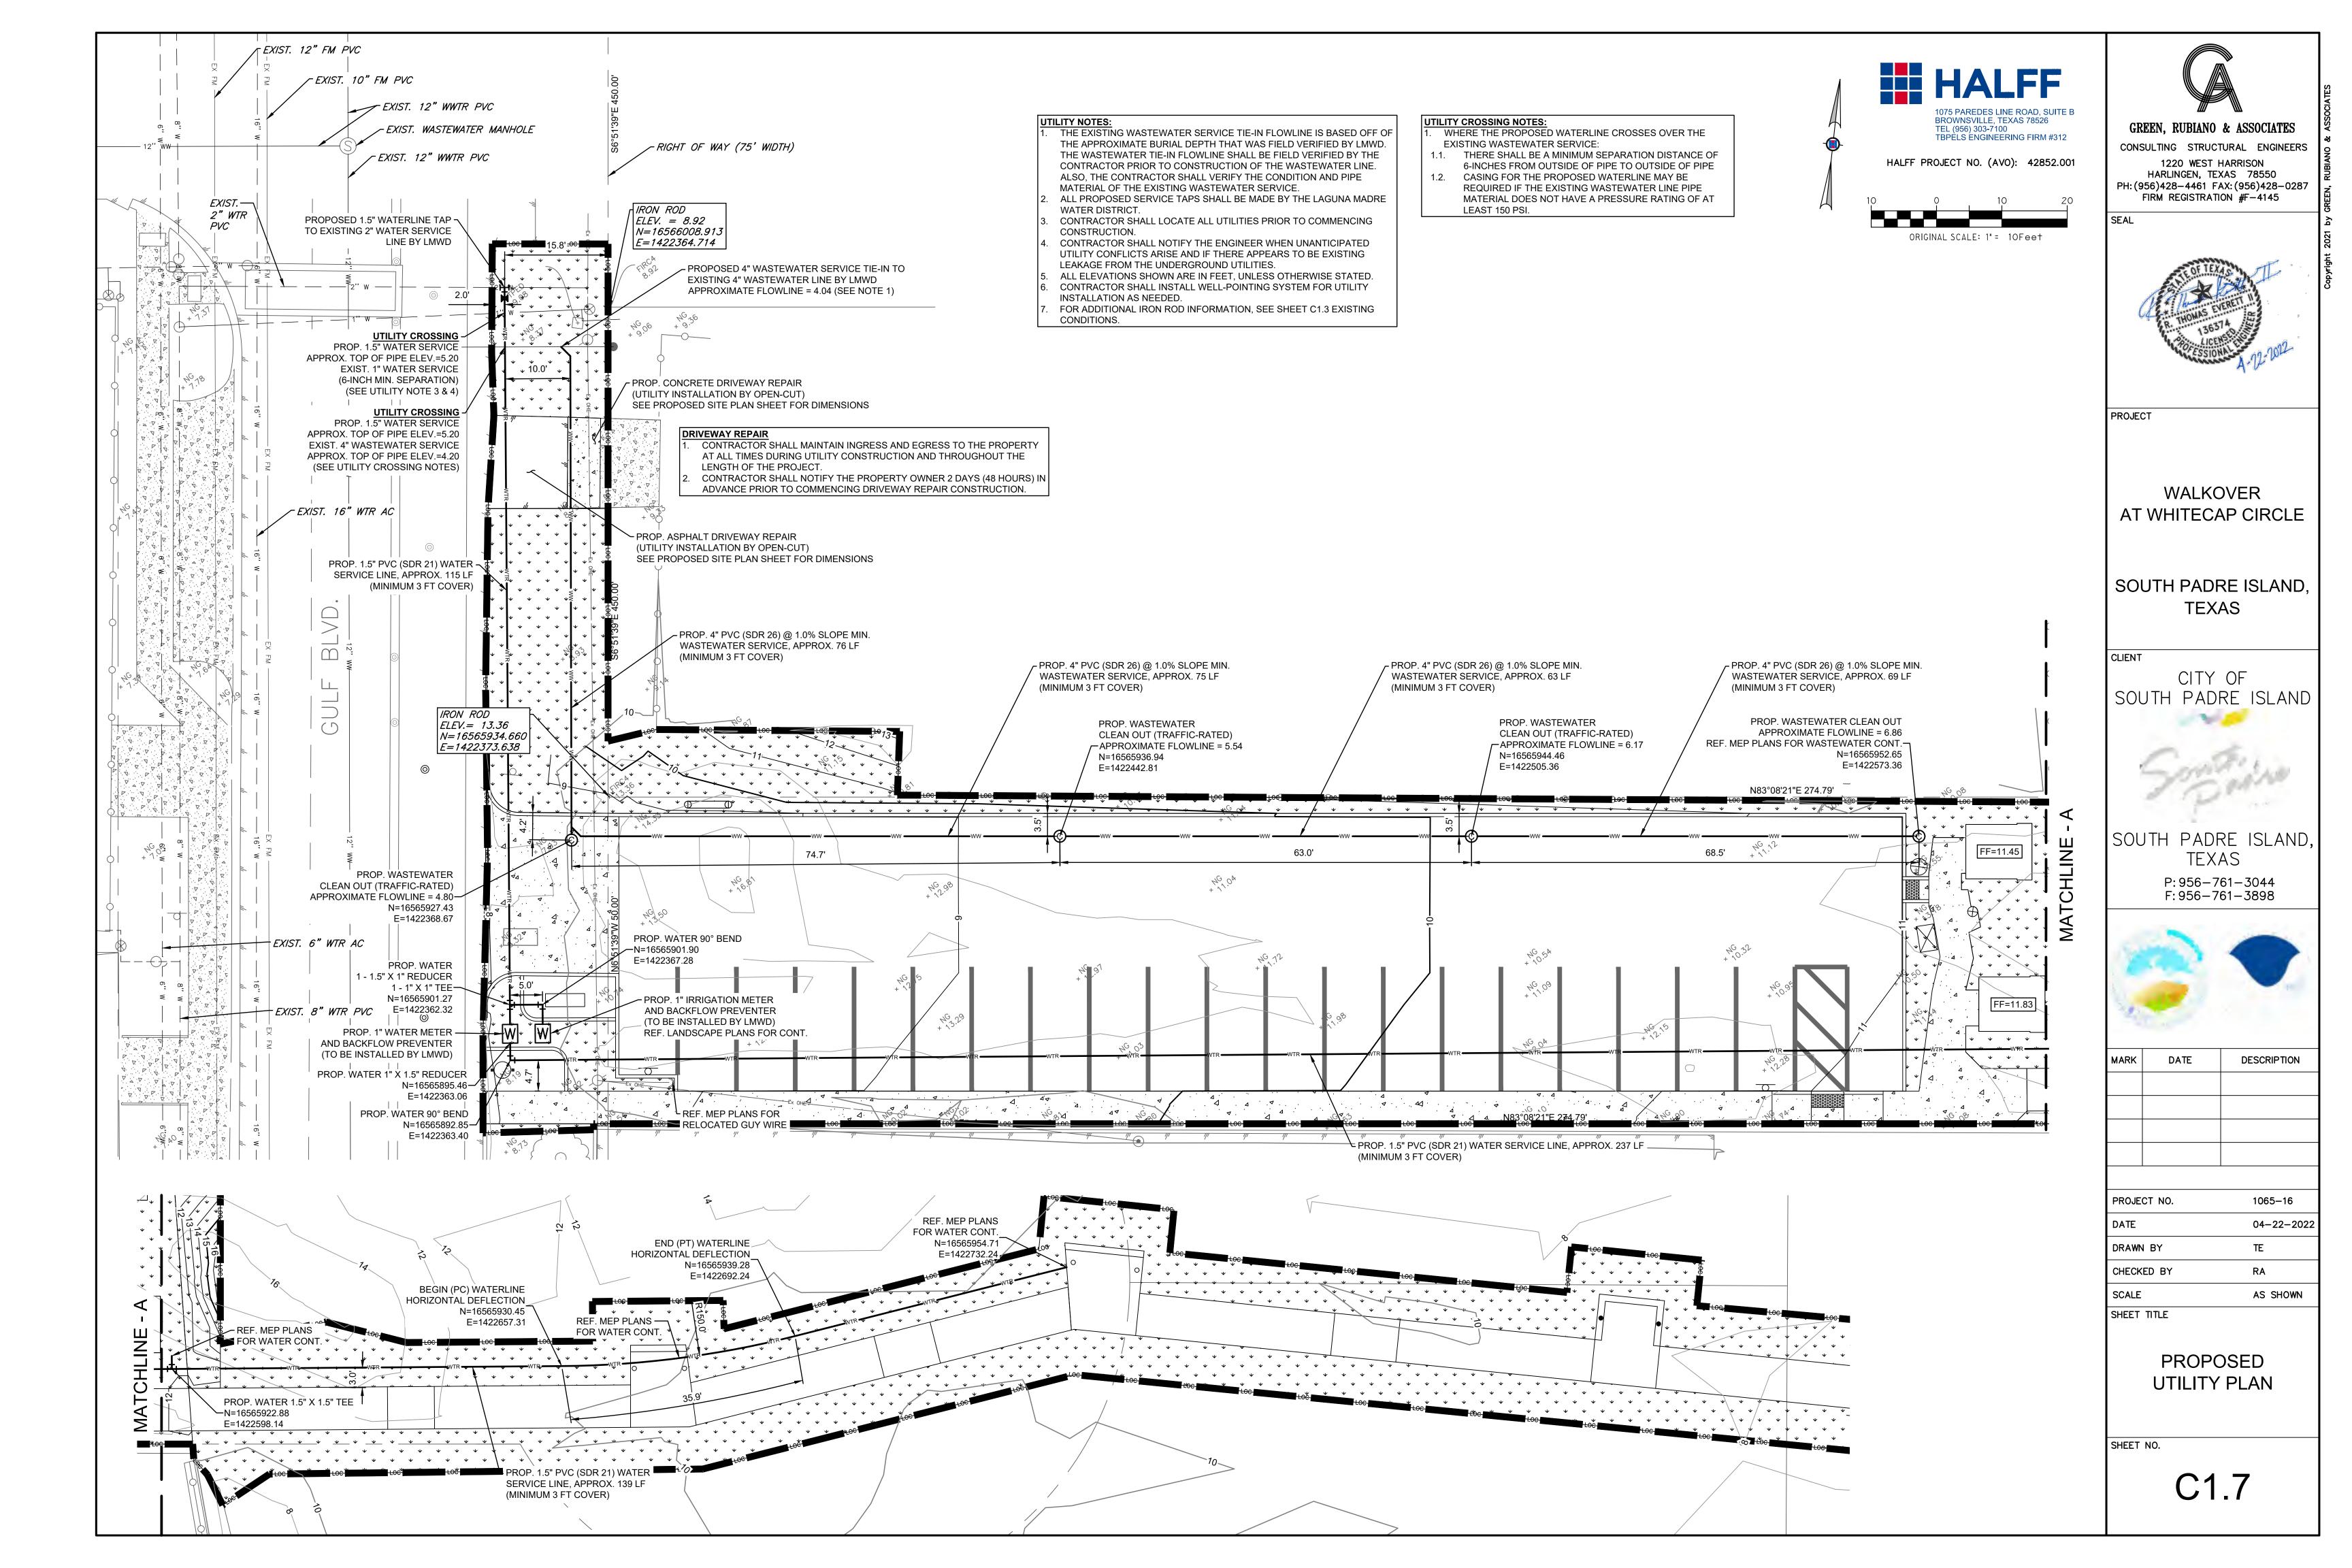

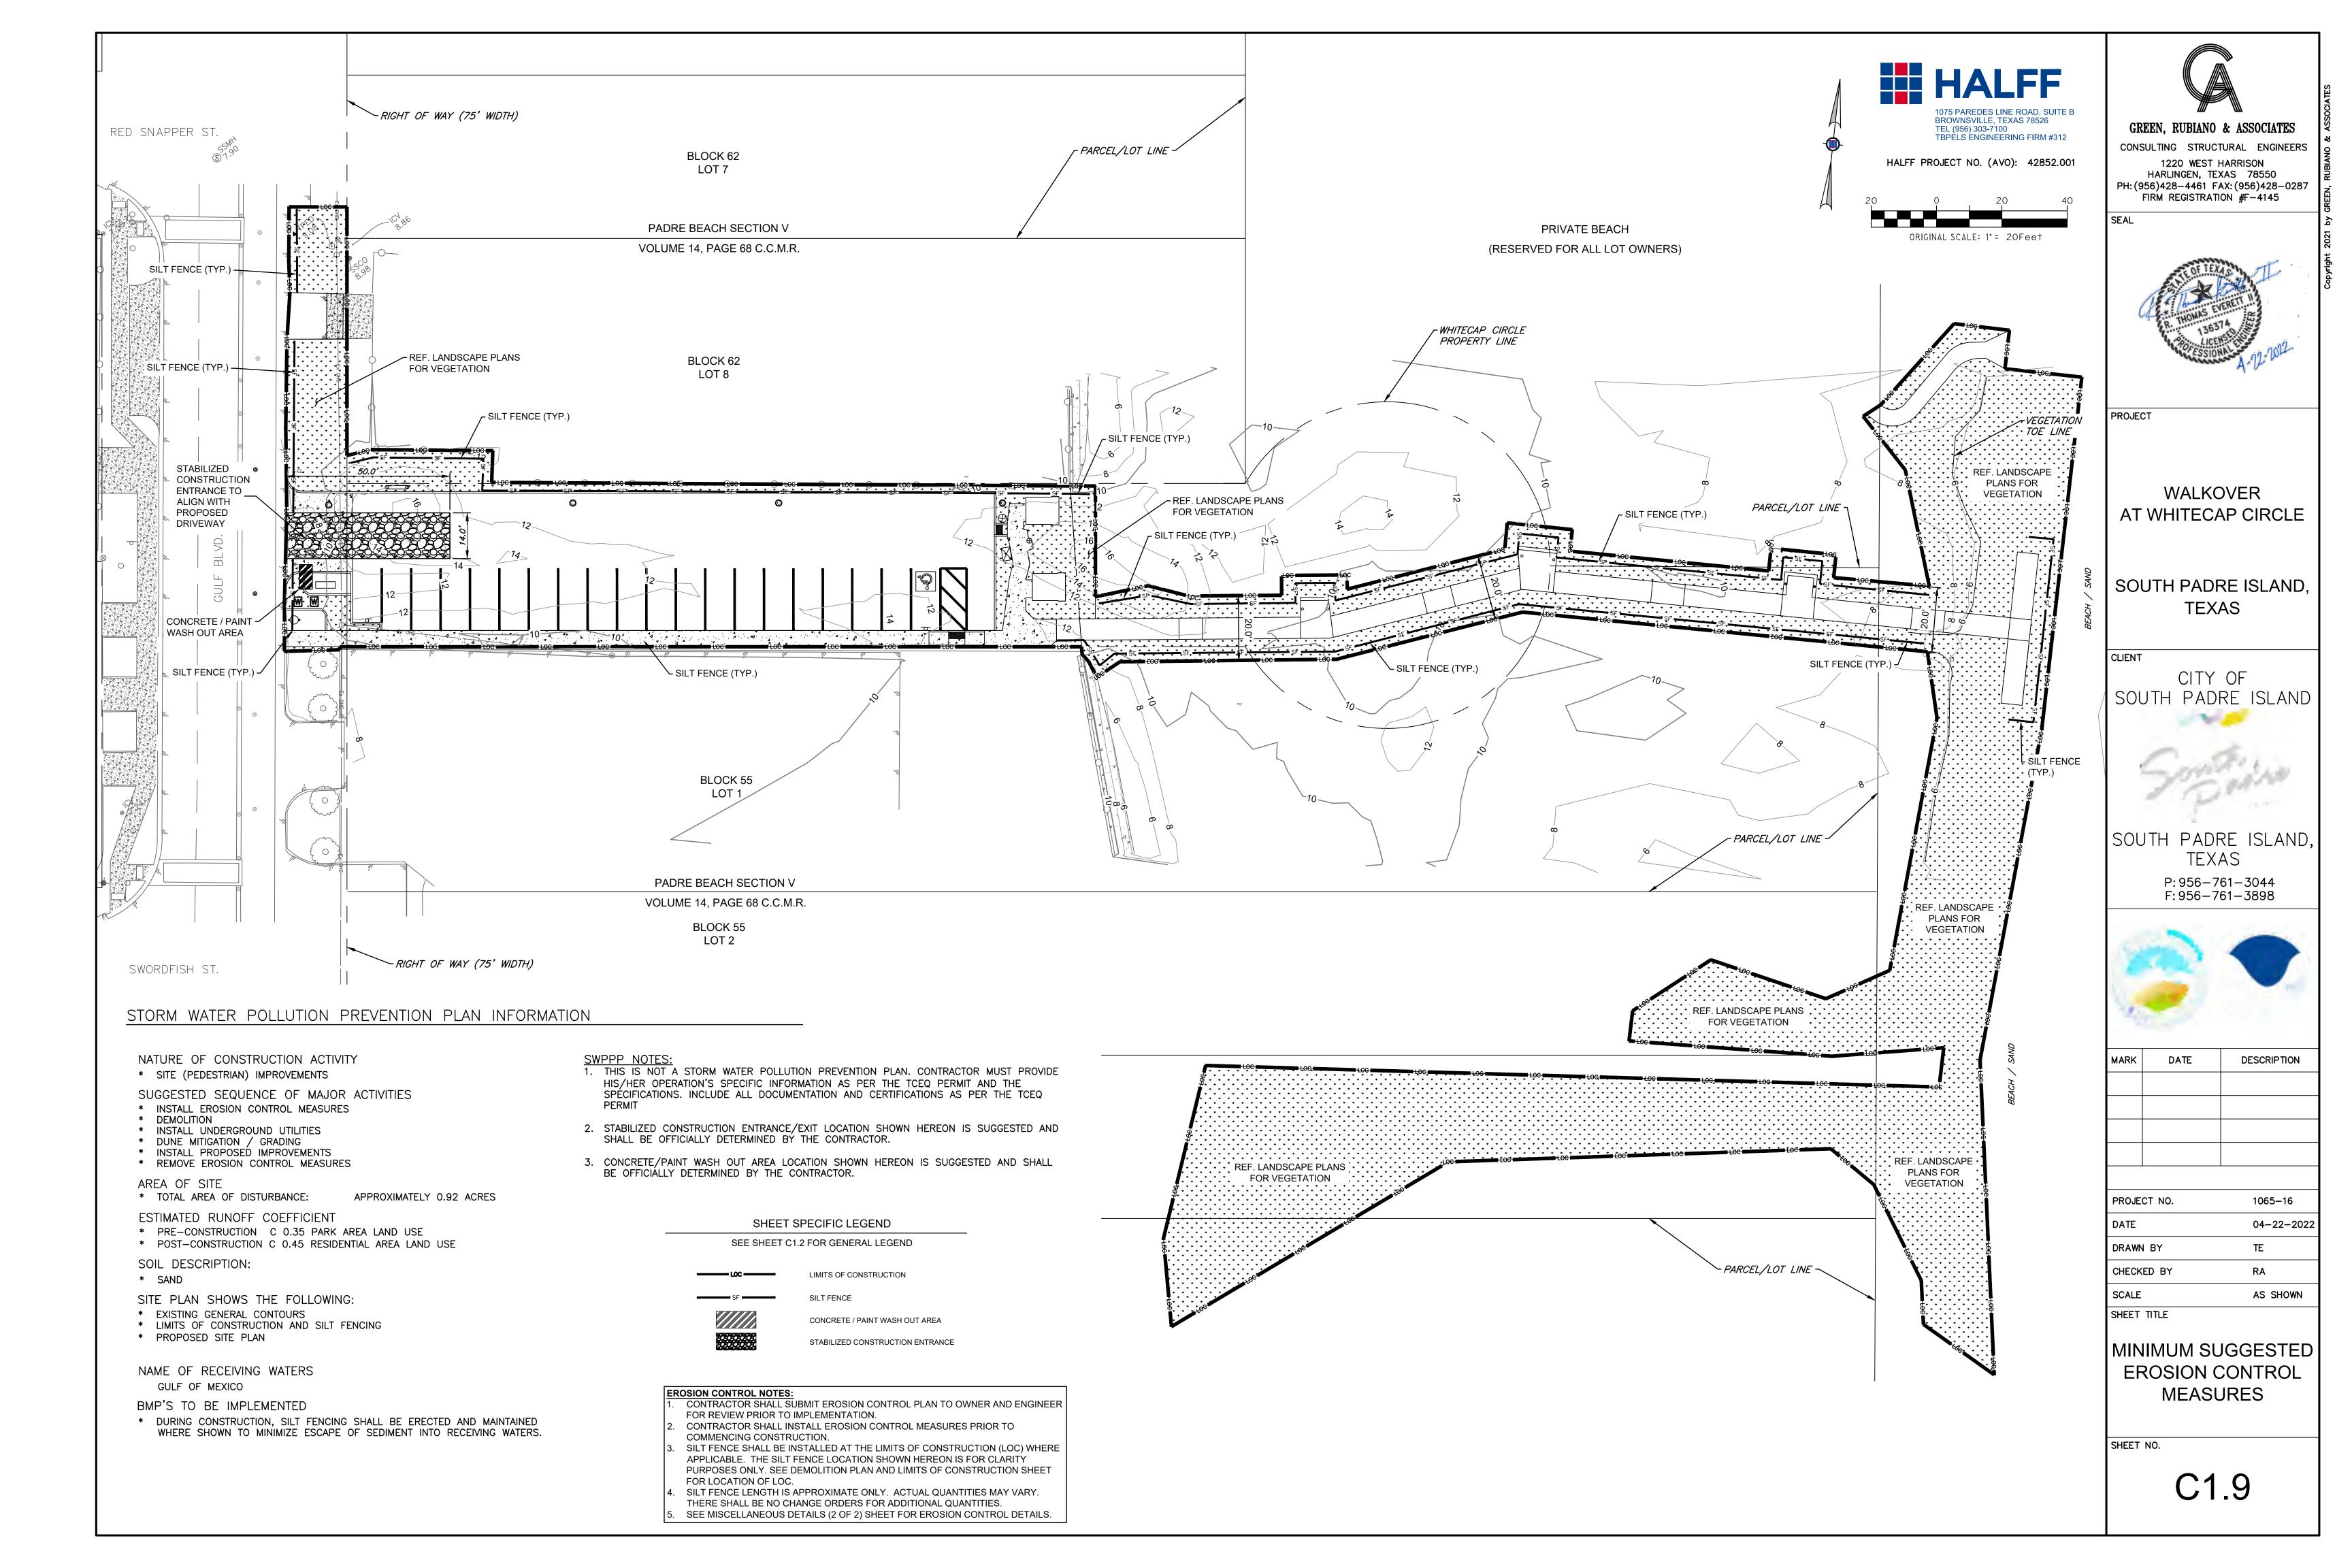

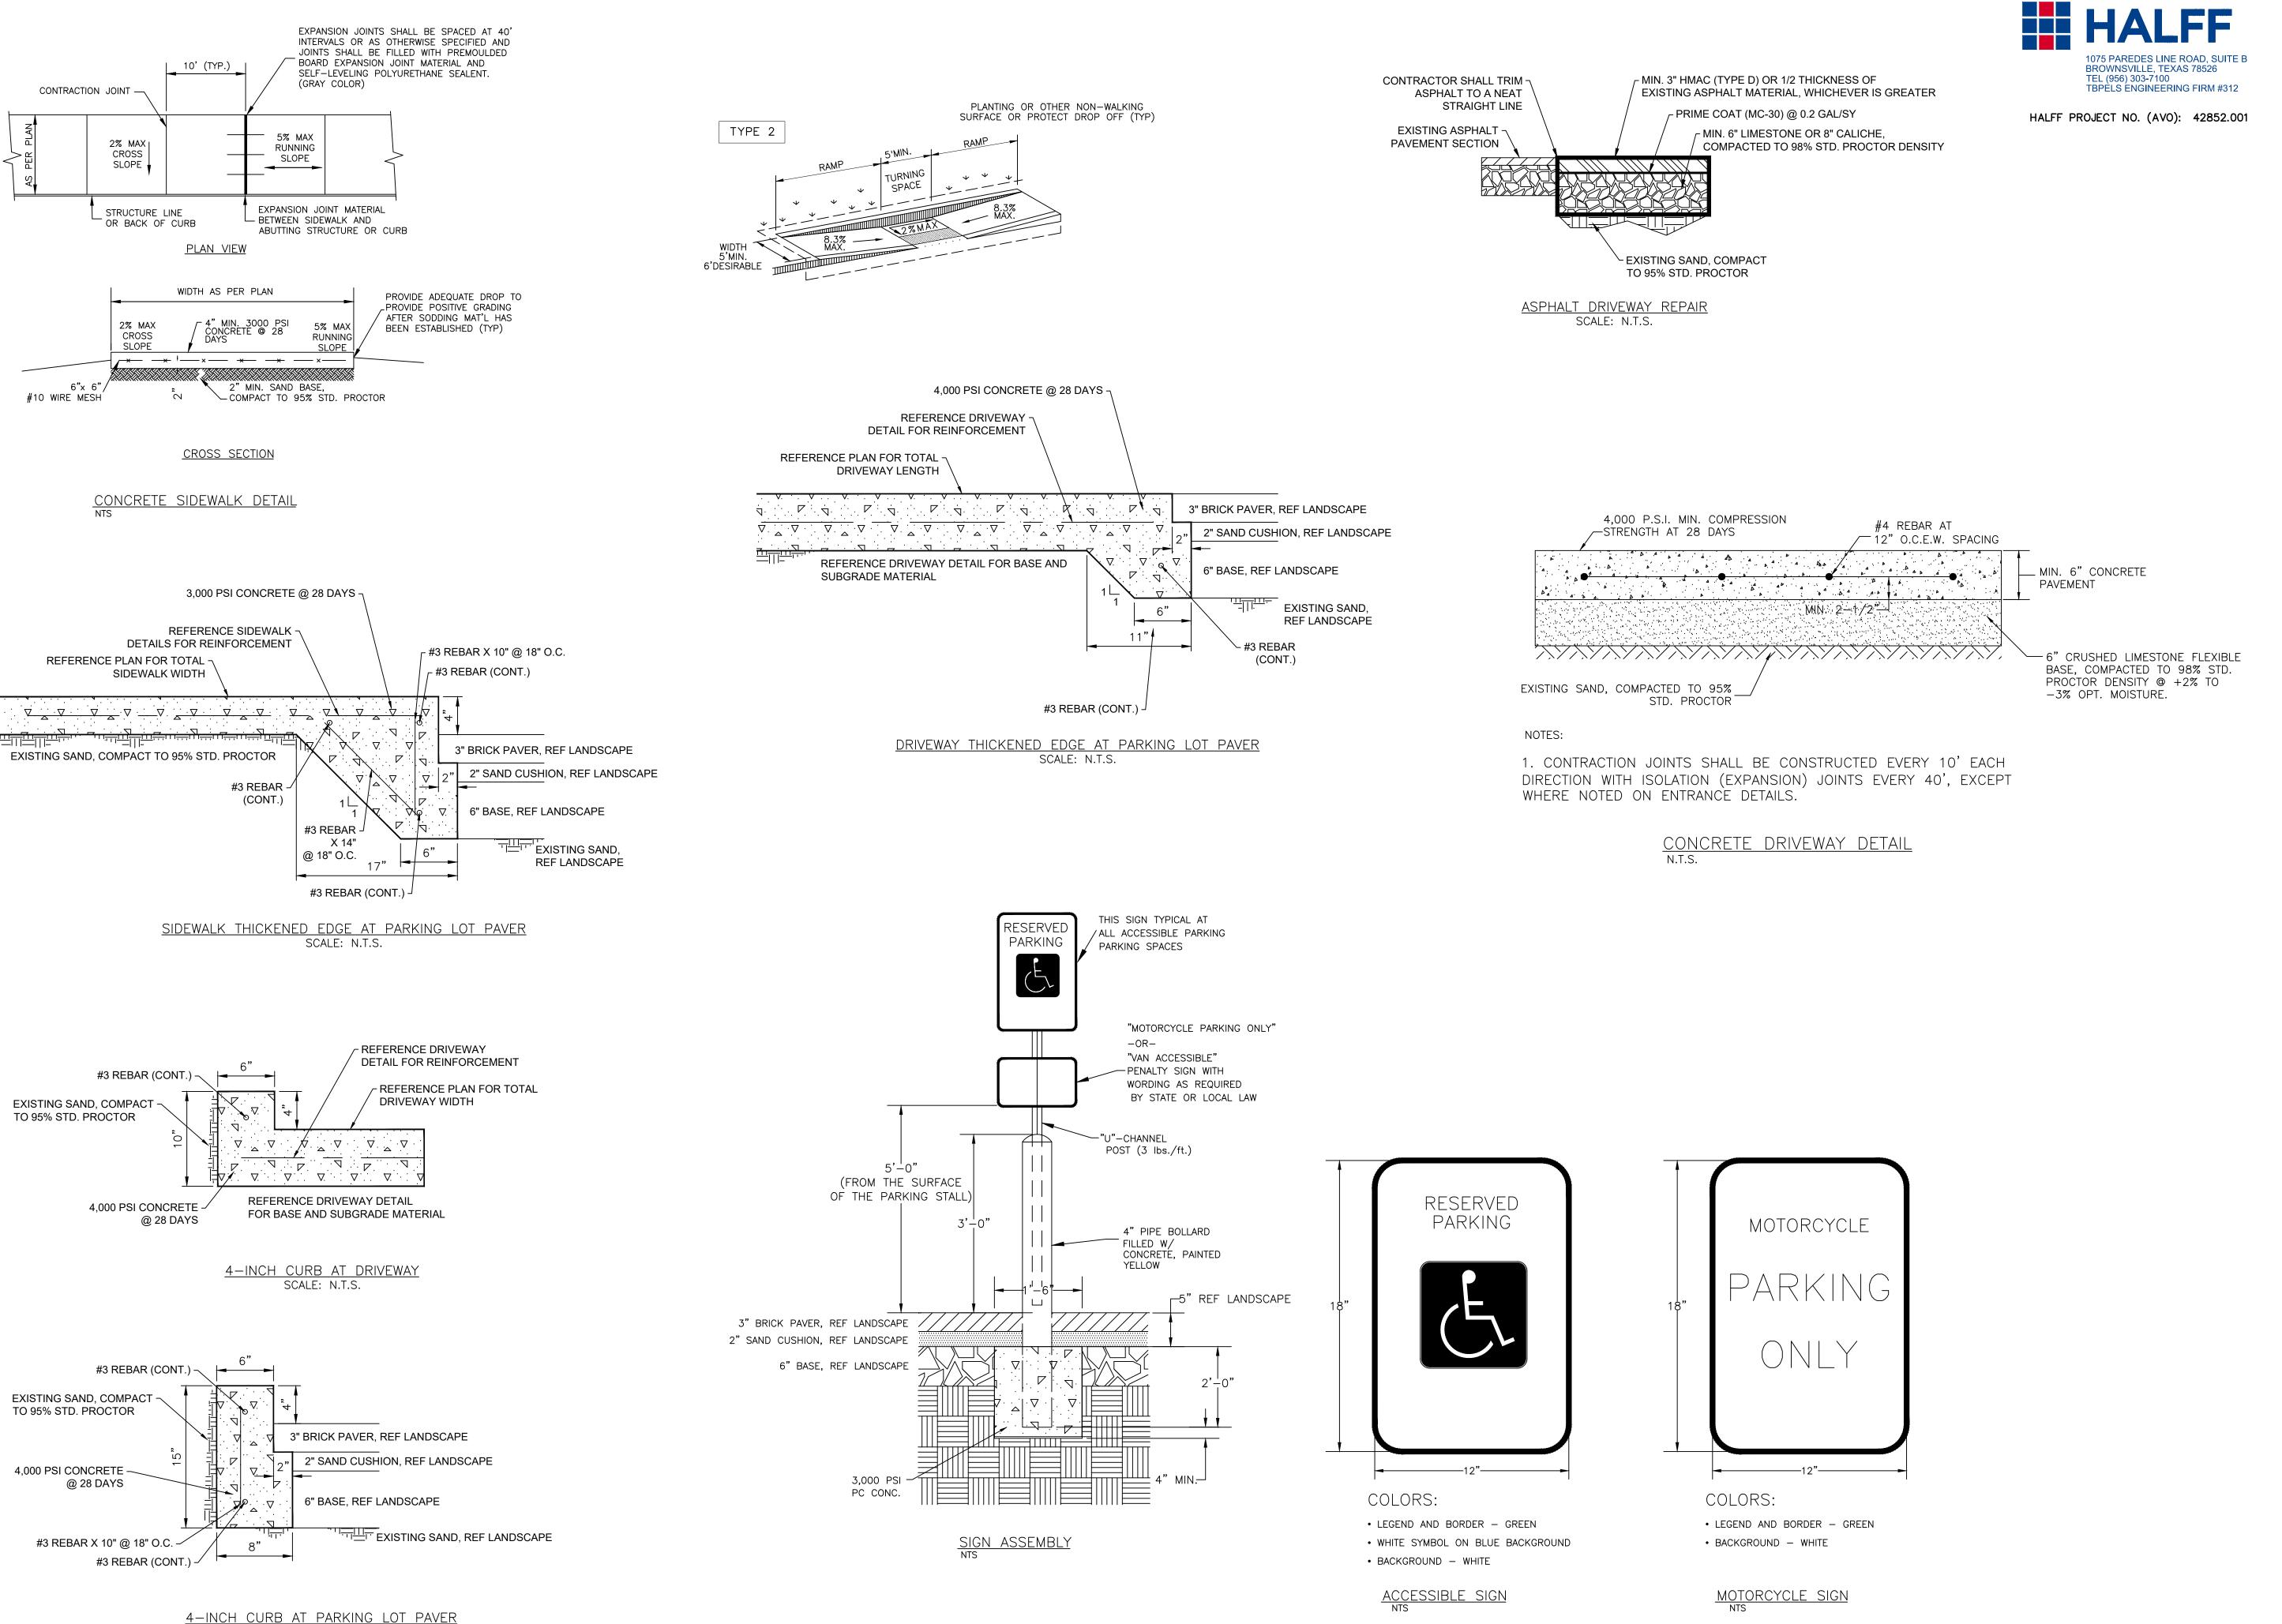

SCALE: N.T.S.

GREEN, RUBIANO & ASSOCIATES

CONSULTING STRUCTURAL ENGINEERS

1220 WEST HARRISON
HARLINGEN, TEXAS 78550
PH: (956)428-4461 FAX: (956)428-0287
FIRM REGISTRATION #F-4145

SEAL



PROJECT

WALKOVER AT WHITECAP CIRCLE

SOUTH PADRE ISLAND, TEXAS

CLIENT


CITY OF SOUTH PADRE ISLAND



SOUTH PADRE ISLAND, TEXAS

> P: 956-761-3044 F: 956-761-3898



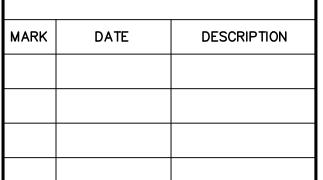


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MISCELLANEOUS DETAILS (1 OF 2)

SHEET NO.

SHEET TITLE

C1.10

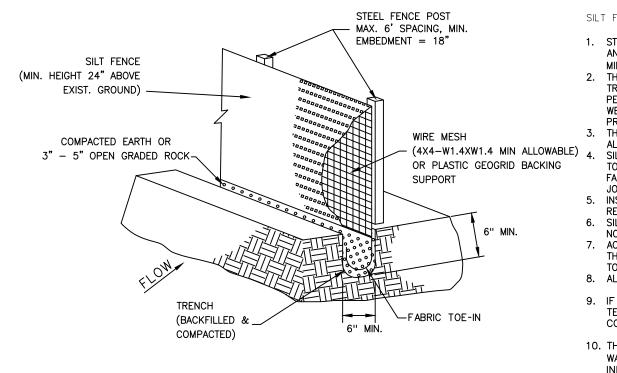

ISOMETRIC VIEW SILT FENCE DETAIL

GRAVEL BAGS.12" CONCRETE BLOCKS OR — OPEN GRADE ROCK

GRAVEL BAGS,

CONCRETE BLOCKS OR


OPEN GRADE ROCK

SILT FENCE NOTES:

- MINIMUM OF 18".
- 2. THE TOE OF THE SILT FENCE SHALL BE TRENCHED IN WITH A SPADE OR MECHANICAL TRENCHER, SO THAT THE DOWNSLOPE FACE OF THE TRENCH IS FLAT AND PERPENDICULAR TO THE LINE OF FLOW. WHERE FENCE CANNOT BE TRENCHED IN WEIGHT FABRIC FLAP WITH WASHED GRAVEL ON UPHILL SIDE, AS NECESSARY, TO PREVENT FLOW UNDER FENCE. 3. THE TRENCH MUST BE A MINIMUM OF 6 INCHES DEEP AND 6 INCHES WIDE TO WIRE MESH


 - (4X4-W1.4XW1.4 MIN ALLOWABLE)

 - (4X4-W1.4XW1.4 MIN ALLOWABLE)
 - 5. INSPECTION SHALL BE MADE WEEKLY OR AFTER EACH RAINFALL. REPAIR OR REPLACEMENT SHALL BE MADE PROMPTLY AS NEEDED. 6. SILT FENCE SHALL BE REMOVED WHEN THE SITE IS COMPLETELY STABILIZED SO AS NOT TO BLOCK OR IMPEDE STORM FLOW OR DRAINAGE. 7. ACCUMULATED SILT SHALL BE REMOVED WHEN IT REACHES A DEPTH OF 6 INCHES.
 - 8. ALL INLETS SHALL BE ENCIRCLED WITH SILT FENCE OR EROSION CONTROL LOGS. 9. IF EROSION CONTROL DEVICES INTERFERE WITH CONSTRUCTION, THEY MAY BE TEMPORARILY REMOVED UNTIL THAT PORTION OF WORK IS COMPLETE. EROSION
 - 10. THE CONTRACTOR SHALL BE RESPONSIBLE FOR THE SUBMITTAL OF A STORM WATER POLLUTION PREVENTION PLAN (SWPPP) THAT SUPPLEMENTS THE INFORMATION PROVIDED IN THE DESIGN PLANS. THE SWPPP INFORMATION PROVIDED IN THE DESIGN PLANS DOES NOT MEET THE REQUIREMENTS SET TPDES REQUIREMENTS).

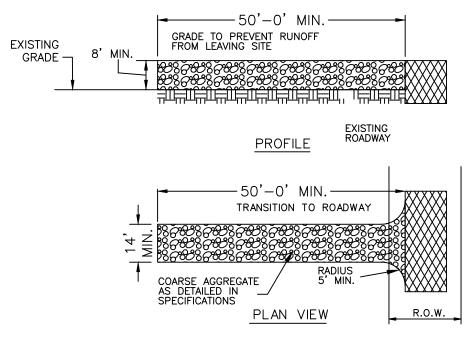

CONSTRUCTION ENTRANCE/EXIT NOTES

- 1. LENGTH SHALL BE AS SHOWN ON THE CONSTRUCTION DRAWINGS, BUT NOT LESS THAN 50 FEET. 2. STONE SHALL BE 3 TO 5 INCH DIAMETER CRUSHED ROCK OR ACCEPTABLE CRUSHED CONCRETE. THICKNESS SHALL NOT BE LESS THAN 8 INCHES.
- 3. WIDTH SHALL NOT BE LESS THAN FULL WIDTH OF ALL POINTS OF INGRESS OR EGRESS.
- 4. STABILIZATION FOR OTHER AREAS SHALL HAVE THE SAME AGGREGATE THICKNESS AND WIDTH REQUIREMENTS AS THE STABILIZED CONSTRUCTION EXIT, UNLESS OTHERWISE SHOWN ON THE CONSTRUCTION DRAWINGS.
- 5. STABILIZED AREA MAY BE WIDENED OR LENGTHENED TO ACCOMMODATE A TRUCK WASHING AREA. AN OUTLET SEDIMENT TRAP MUST BE PROVIDED FOR THE TRUCK WASHING AREA.
- 6. STABILIZED CONSTRUCTION EXIT MUST BE PROPERLY GRADED OR INCORPORATE DRAINAGE SWALE TO PREVENT RUNOFF FROM LEAVING THE CONSTRUCTION SITE AND SHALL BE MAINTAINED FREE OF SEDIMENT FOR THE DURATION OF THE PROJECT.
- 7. THE ENTRANCE SHALL BE MAINTAINED IN A CONDITION WHICH WILL PREVENT TRACKING OR FLOWING OF SEDIMENT ONTO PAVED SURFACES. THIS MAY REQUIRE PERIODIC TOP DRESSING WITH ADDITIONAL STONE A CONDITIONS DEMAND. ALL SEDIMENT SPILLED, DROPPED, WASHED OR TRACKED ONTO PAVED SURFACES, MUST BE REMOVED IMMEDIATELY.
- 8. STABILIZED CONSTRUCTION EXIT SHALL BE USED FOR SUBGRADE OF THE PROPOSED ACCESS DRIVE. CONTRACTOR TO LEVEL STABILIZED ROCK AND PLACE CRUSHED LIMESTONE AS PER DETAIL.

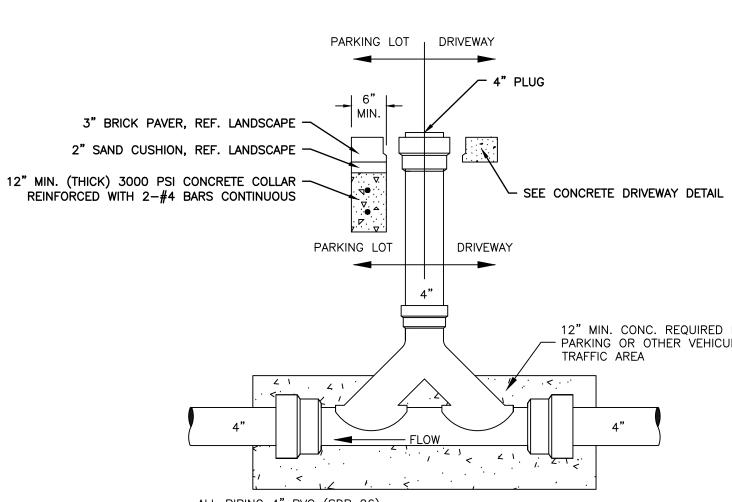



- PROPOSED PAVEMENT SECTION

TYPICAL PIPE BEDDING AND

A SAND BEDDING PLACED BEFORE PIPE IS LAID UP TO FLOW LINE OF PIPE (MIN.

B SAND BACKFILL PLACED AFTER PIPE IS LAID FROM BOTTOM OF PIPE TO SPRING LINE OF PIPE (4" LIFTS, HAND TAMPED).

C SAND BACKFILL PLACED FROM SPRING LINE OF PIPE TO 6" ABOVE TOP OF PIPE

FOUNDATION PREPARATION (WELLPOINTS, GRAVEL OR CEMENT STABILIZATION, OR

BACKFILLING AT STRUCTURES SHALL BE PLACED IN UNIFORM LAYERS, MOISTENED AS REQUIRED TO APPROXIMATE OPTIMUM MOISTURE CONTENT, AND COMPACTED TO 95% STD. PROCTOR DENSITY. THE THICKNESS OF EACH LOOSE LAYER SHALL NOT

EXCEED 6". STRUCTURE BACKFILL MATERIAL SHALL BE SAND, APPROVED SITE

APPROVED SUBSTITUTE) SHALL BE REQUIRED WHEN TRENCH BOTTOM IS

D SAND BACKFILL, CLASS "A" (6" LIFTS, MECHANICAL COMPACTION).

E EARTH BACKFILL, CLASS "B" (12" LIFTS, MECHANICAL COMPACTION).

FRENCH BACKFILL DETAIL

CONTRACTOR SHALL TRIM

ASPHALT TO A NEAT

STRAIGHT LINE.

EXISTING

COMPACTED TO

DENSITY (MIN.)

95% STD. PROCTOR-

COMPACTED TO

DENSITY (MIN.)

MOISTURE TO BE

THICKNESS = 6").

UNSTABLE.)

(6" LIFTS, HAND TAMPED).

SOIL, OR OTHER APPROVED SUBSTITUTE.

+3 OF OPTIMUM

NOTE: FIELD

MOISTURE.

95% STD. PROCTOR

EXISTING BASE—

ASPHALT >

HALFF PROJECT NO. (AVO): 42852.001

— NATURAL GROUND

124" MAX. METALLIC

COMPACTED TO

─95% STD. PROCTOR DENSITY (MIN.)



CONSULTING STRUCTURAL ENGINEERS 1220 WEST HARRISON HARLINGEN, TEXAS 78550 PH: (956)428-4461 FAX: (956)428-0287 FIRM REGISTRATION #F-4145 SEAL

GREEN. RUBIANO & ASSOCIATES

PROJECT

WALKOVER AT WHITECAP CIRCLE

SOUTH PADRE ISLAND, **TEXAS**

CLIENT


CITY OF SOUTH PADRE ISLAND



SOUTH PADRE ISLAND, TEXAS

P: 956-761-3044 F: 956-761-3898



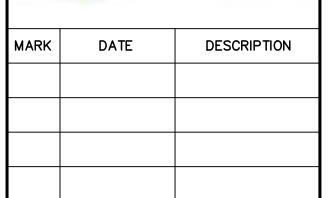


PROJECT NO.	1065–16
DATE	04-22-2022
DRAWN BY	TE
CHECKED BY	RA
SCALE	AS SHOWN

SHEET TITLE

MISCELLANEOUS DETAILS (2 OF 2)

SHEET NO.

C1.11

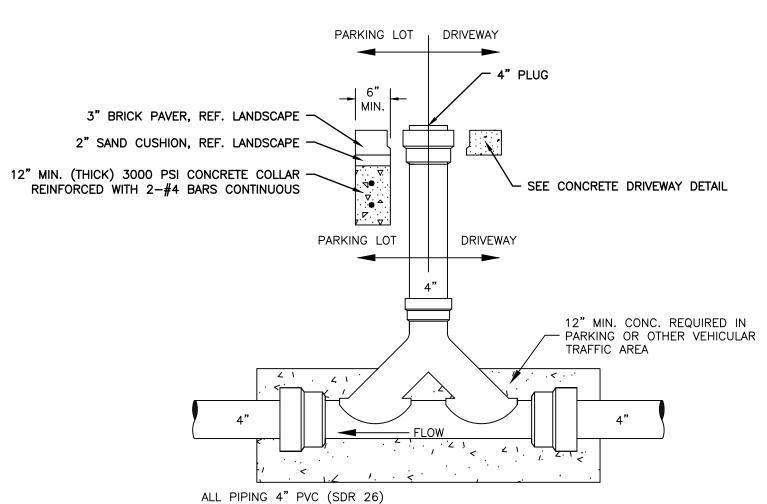

SINGLE BARREL DOUBLE CLEAN-OUT

1. STEEL POSTS WHICH SUPPORT THE SILT FENCE SHALL BE INSTALLED WITH A SLIGHT ANGLE TOWARD THE ANTICIPATED RUNOFF SOURCE. POST MUST BE EMBEDDED A

TO BACKING SUPPORT, WHICH IS IN TURN ATTACHED TO THE STEEL FENCE POST. FABRIC SHALL OVERLAP AT ABUTTING ENDS A MINIMUM OF 3 FEET AND SHALL BE JOINED SUCH THAT NO BYPASS OR LEAKAGE OCCURS.

THE SILT SHALL BE DISPOSED OF IN AN APPROVED SITE AND IN SUCH A MANNER AS TO NOT CONTRIBUTE TO ADDITIONAL SILTATION.

CONTROL DEVICES MUST BE IN PLACE AT ALL OTHER TIMES.

FORTH IN THE TCEQ GENERAL PERMIT. THIS INFORMATION AND DETAILS ARE ONLY FOR INFORMATIONAL PURPOSES ONLY. (REFER TO SPECIFICATION 02370 - STABILIZED CONSTRUCTION EXIT

GROUND




SHEETING

— AS REQUIRED

WASHOUT PIT NOTES

- THE EXCAVATION FOR THE CONCRETE WASHOUT SHALL BE A MINIMUM OF 10' WIDE AND A SUFFICIENT LENGTH AND DEPTH TO ACCOMMODATE 7 GALLONS OF WASHOUT WATER AND CONCRETE PER TRUCK PER DAY AND/OR 50 GALLONS WATER AND CONCRETE PER
- 2. IN THE EVENT THAT THE CONCRETE TRUCK WASHOUT IS CONSTRUCTED ABOVE GROUND, IT SHALL BE 10 FEET WIDE AND 10 FEET LONG WITH WITH THE SAME REQUIREMENTS FOR CONTAINMENT AS DESCRIBED IN NOTE 1.
- 3. THE CONTAINMENT AREA SHALL BE LINED WITH 10 MIL. PLASTIC SHEETING WITHOUT HOLES OR TEARS. WHERE THERE ARE SEAMS, THESE SHALL BE SECURED ACCORDING TO MANUFACTURERS' DIRECTIONS.
- 4. THE BERM CONSISTING OF GRAVEL BAGS, CONCRETE BLOCKS OR OPEN GRADED ROCK SHALL BE NO LESS THAN 18 INCHES HIGH AND NO LESS THAN 12 INCHES WIDE.
- 5. THE PLASTIC SHEETING SHALL BE OF SUFFICIENT SIZE SO THAT IT WILL OVER LAP THE TOP OF THE CONTAINMENT AREA AND BE WRAPPED AROUND THE GRAVEL BAGS, CONCRETE BLOCKS OR OPEN GRADED ROCK AT LEAST TWO TIMES.
- THE GRAVEL BAGS, CONCRETE BLOCKS OR OPEN GRADED ROCK SHALL BE PLACED ABUTTING EACH OTHER TO FORM A CONTINUOUS BERM AROUND THE OUTER PERIMETER OF THE CONTAINMENT AREA.
- . THE WASHOUT MATERIAL IN THE CONTAINMENT AREA SHALL NOT EXCEED 50% OF
- 8. SOLIDS SHALL BE REMOVED FROM CONTAINMENT AREA AND DISPOSED OF PROPERLY. ANY DAMAGE TO THE PLASTIC SHEETING SHALL BE REPAIRED OR SHEETING BE REPLACED

CONCRETE / PAINT WASHOUT PIT

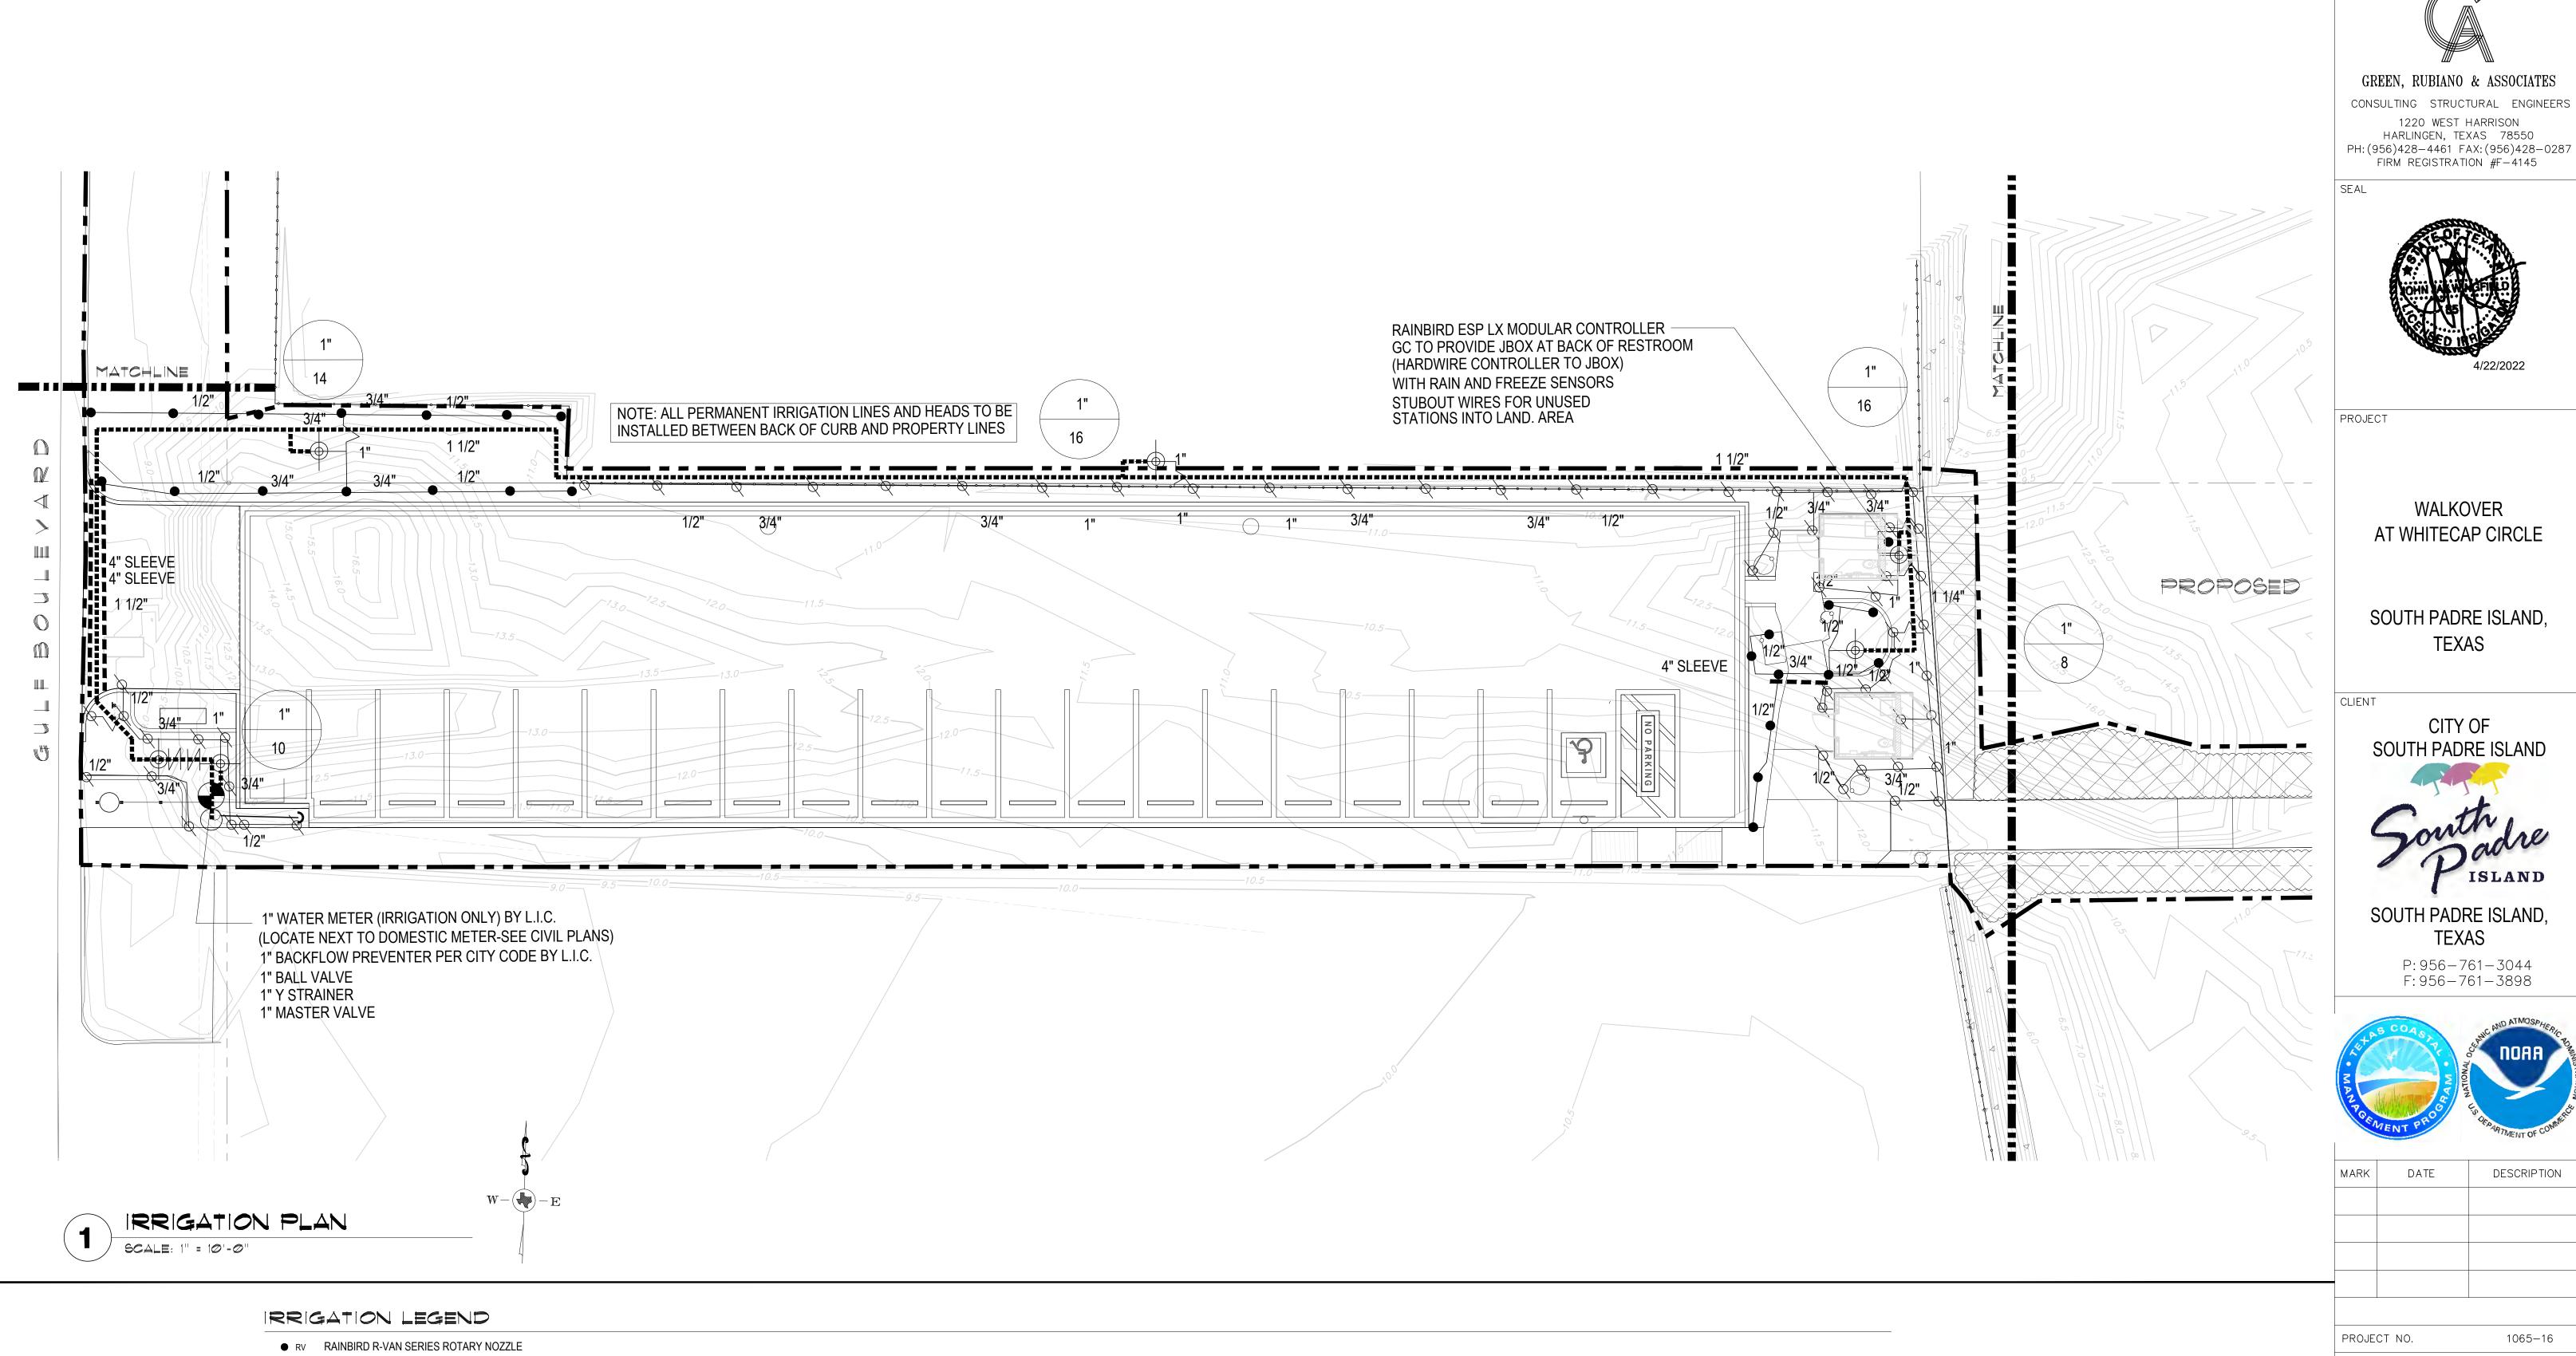

PROJECT NO. 1065-16 04-22-2022 DATE

DATE

WALKOVER

TEXAS

CITY OF

TEXAS

P: 956-761-3044

F: 956-761-3898

DESCRIPTION

DRAWN BY PLM SSP CHECKED BY SCALE AS SHOWN

SHEET TITLE

IRRIGATION PLAN

SHEET NO.

SSP

Design

SITE PLANNING

LANDSCAPE DESIGN

789 E. WASHINGTON ST.

BROWNSVILLE, TX 78575

TEL (956) 547-9788

FAX (956) 547-9977 www.sspdesign.com

smr

landscape architecture

STEVEN M. RAHN, INC.

1708 N. Griffin Street

Dallas, Texas 75202

Tel 214.871.0083

Fax 214.871.0545

Email smr@smr-la.com

TEMPORARY IRRIGATION

TEMPORARY IRRIGATION (ROTORS) TO COVER DUNE RESTORATION AREA TO REMAIN UNTIL END OF 90 DAY MAINTENANCE PERIOD . (CONNECT TO QUICK COUPLERS).

INSTALL ALL EQUIPMENT ACCORDING TO MANUFACTURERS SPECIFICATIONS ALL VALVE BOXES SHALL BE RAINBIRD VB-STD OR APPROVED EQUAL ALL VALVE BOXES SHALL HAVE FILTER FABRIC AND 4" OF GRAVEL AT BASE

ELECTRICAL SPLICES AT EACH VALVE AND CONTROLLER ONLY. IRRIGATION IN TEXAS IS REGULATED BY THE TEXAS COMMISSION ON ENVIRONMENTAL QUALITY (TCEQ) MC-178/ P.O.BOX 13087, AUSTIN, TX 78711-3087. TECQ'S WEBSITE IS:

DESIGN PRESSURE 60 PSI

NUMBER OF BUBBLERS SIZE OF PIPE 1 - 5 6 - 10 11 - 20 21 - 30 11/4" 1½" 31 - 40

BUBBLER PIPING CHART

CONTROLLER (ESP-LX WITH RAIN/FREEZE SENSOR) WATER METER (AS SIZED) BACKFLOW PREVENTER (AS SIZED) CLASS 200 PVC LATERAL PIPING CLASS 200 PVC MAINLINE SCH. 40 PVC SLEEVING (AS SIZED) VALVE SIZE GPM

RAINBIRD QUICK COUPLER VALVE (33-DLRC) QUICK COUPLERS SHALL

COLORED ZONING DIAGRAM - LOCATED ALONG MAINLINE 200' SPACING


BE CONNECTED TO MAINLINE ADD ONE ZONE THAT ACTIVATES

MASTER VALVE AND ACTIVATES THE QUICK COUPLERS, LABEL ON

RAINBIRD 1404 BUBBLER HEAD

RAINBIRD PEB SERIES ELECTRIC VALVE

www.tceq.state.tx.us

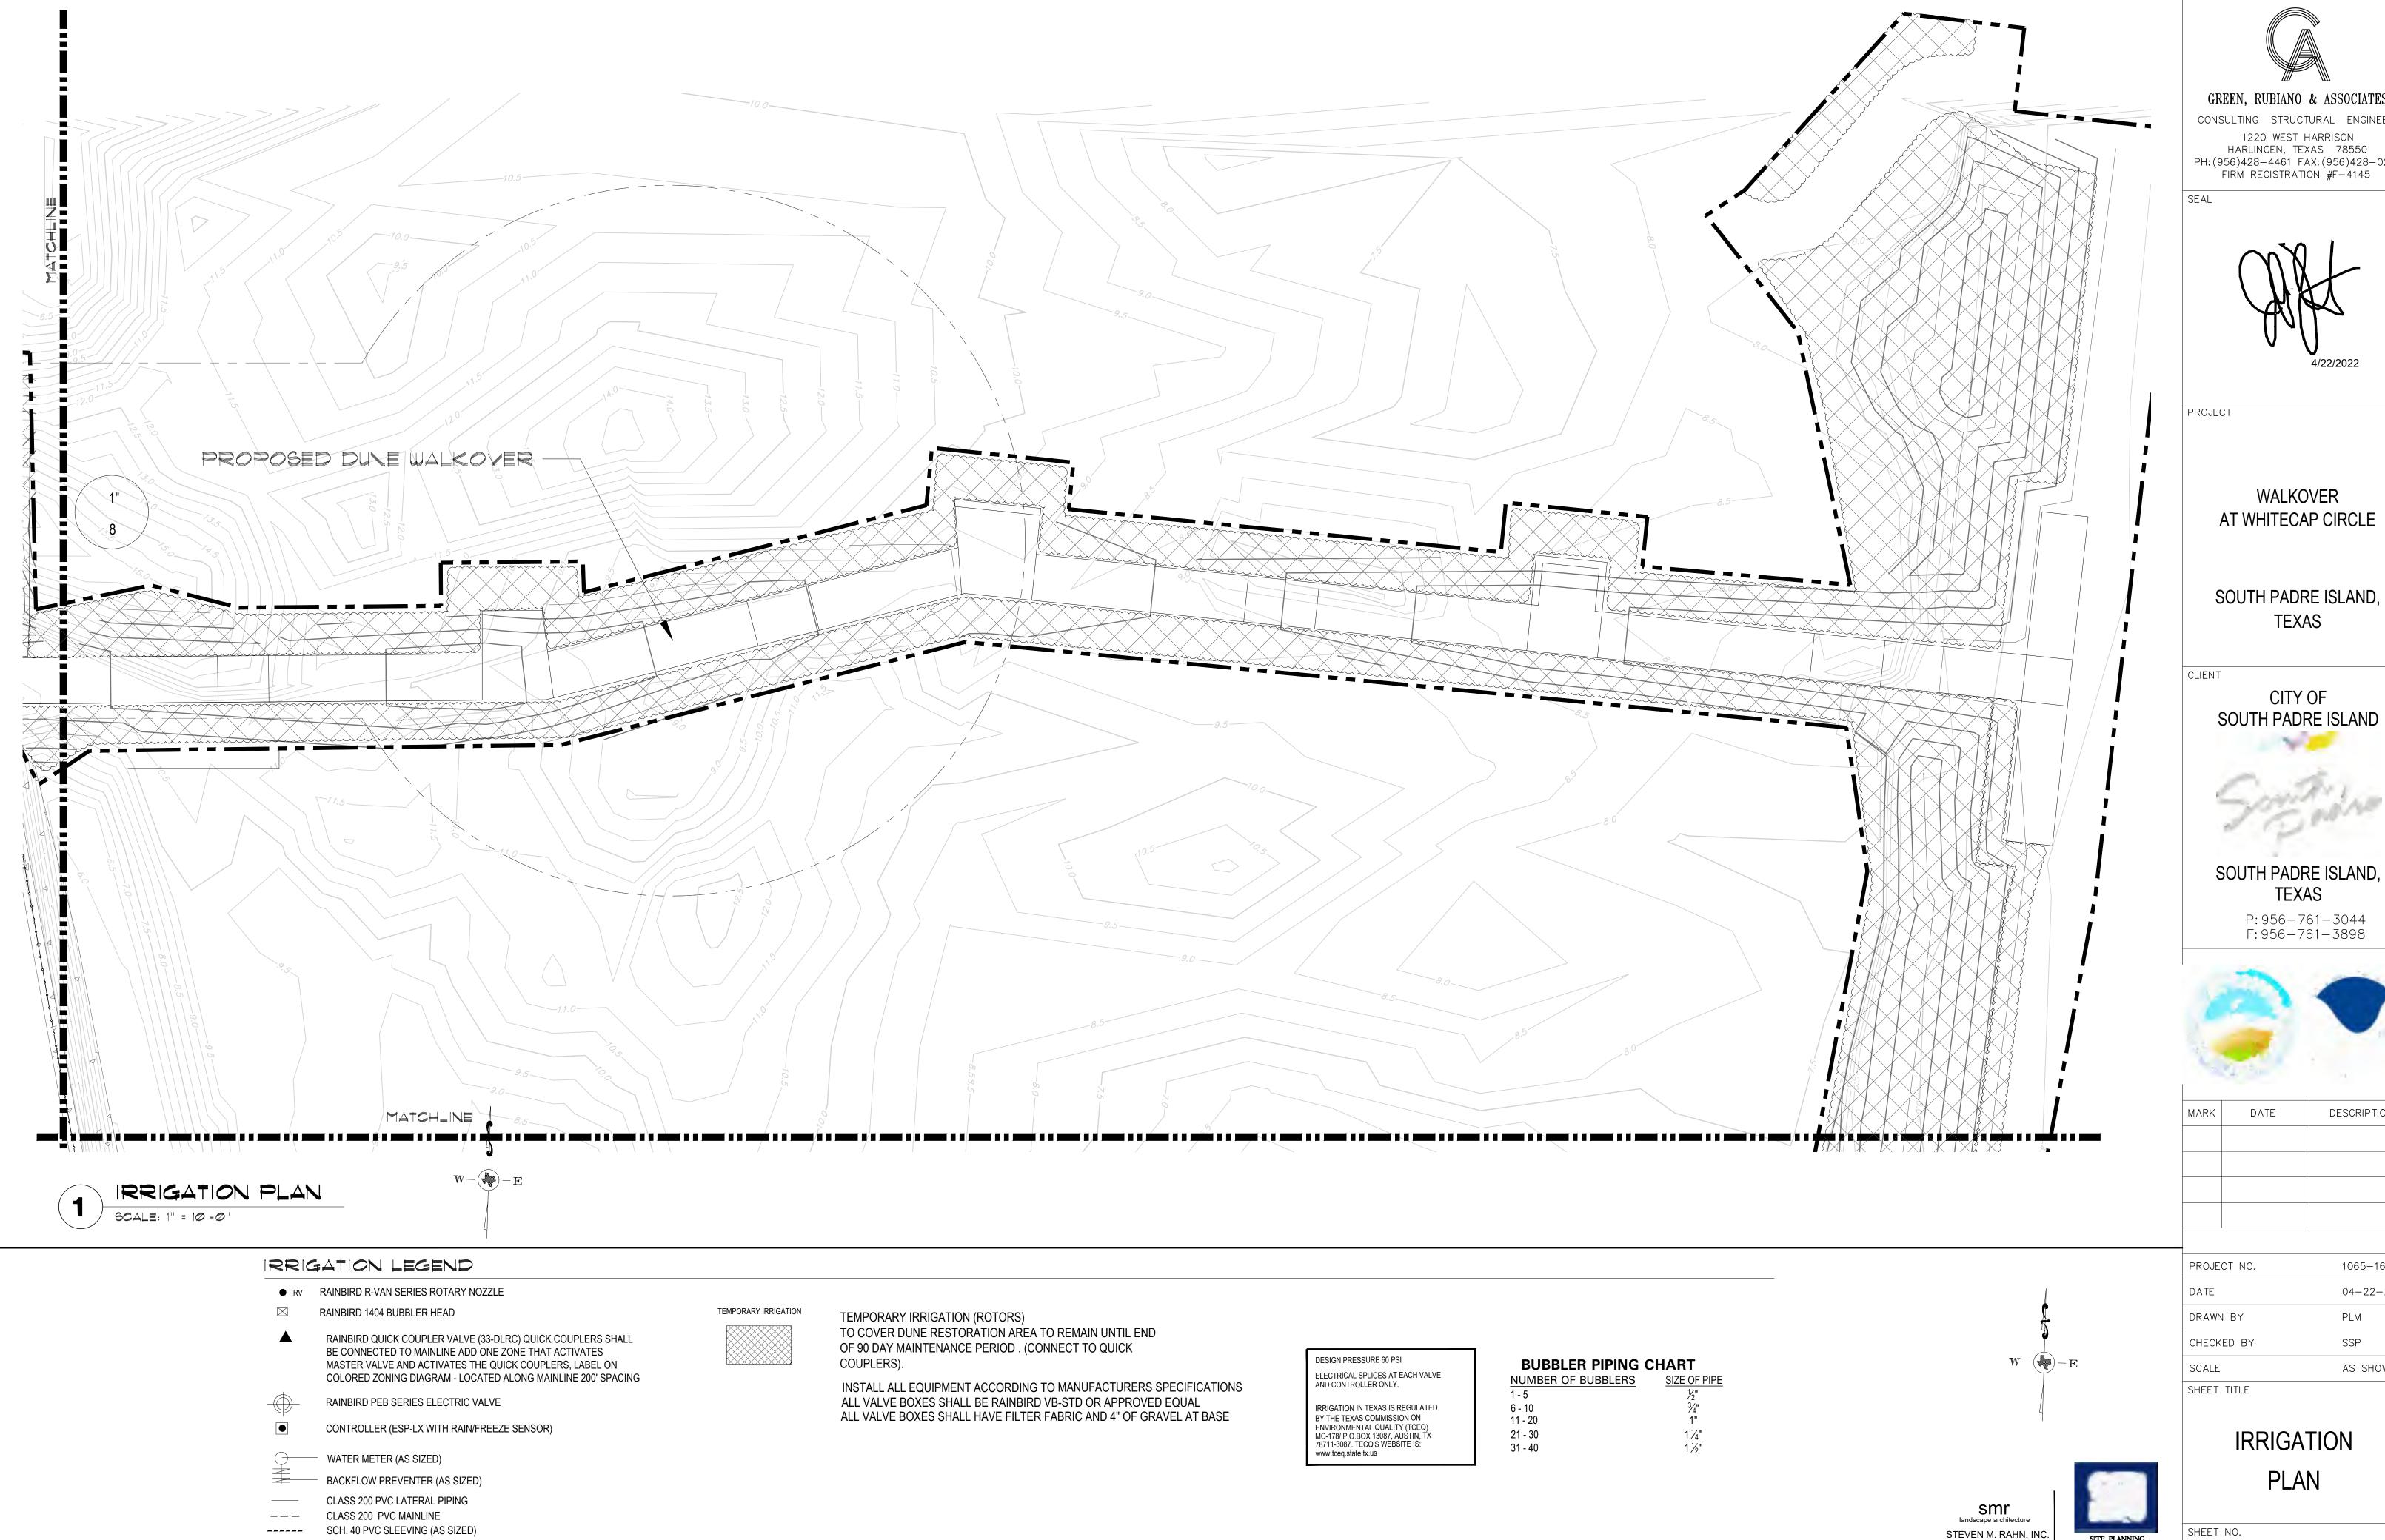

VALVE SIZE

GPM

GREEN, RUBIANO & ASSOCIATES

CONSULTING STRUCTURAL ENGINEERS 1220 WEST HARRISON

HARLINGEN, TEXAS 78550
PH: (956)428-4461 FAX: (956)428-0287
FIRM REGISTRATION #F-4145



WALKOVER AT WHITECAP CIRCLE

CITY OF



F: 956-761-3898



MARK	DATE	DESCRIPTION

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IRRIGATION

SHEET NO.

SITE PLANNING

LANDSCAPE DESIGN

789 E. WASHINGTON ST. BROWNSVILLE, TX 78575

TEL (956) 547-9788 FAX (956) 547-9977


www.sspdesign.com

1708 N. Griffin Street

Dallas, Texas 75202

Tel 214.871.0083 Fax 214.871.0545

Email smr@smr-la.com

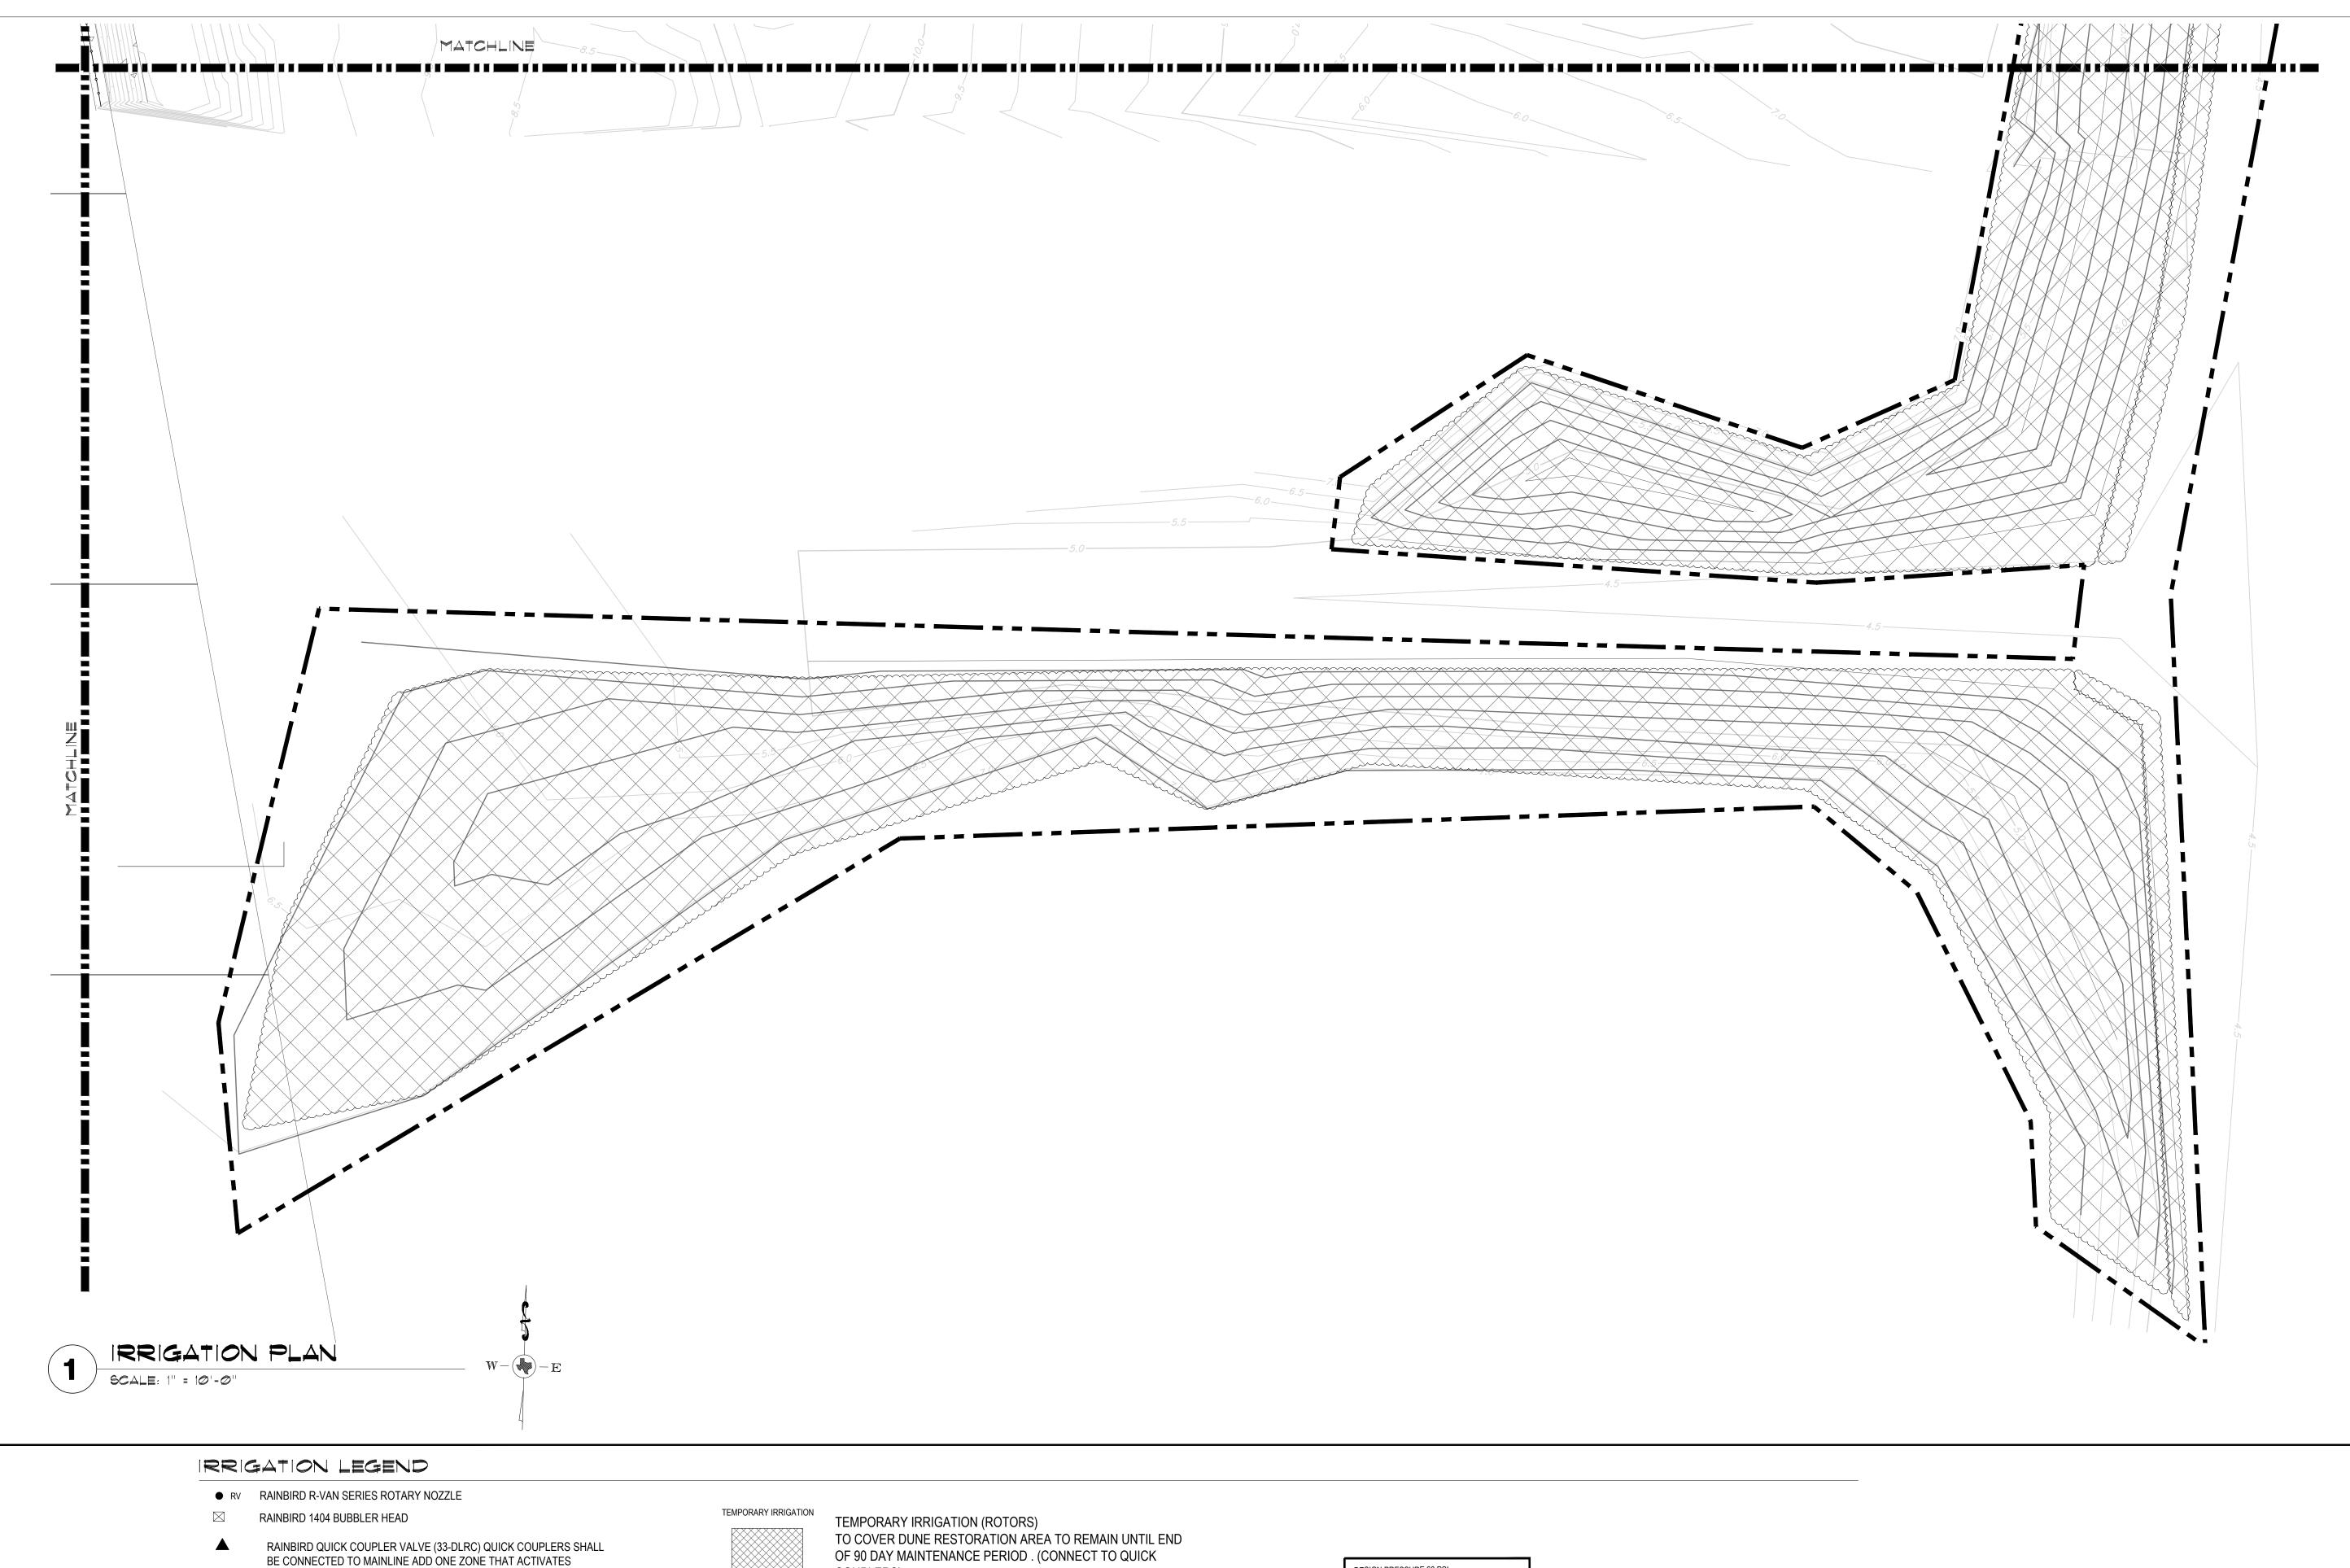

04-22-2022 DRAWN BY PLM SSP CHECKED BY SCALE AS SHOWN

GREEN, RUBIANO & ASSOCIATES

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HARLINGEN, TEXAS 78550
PH: (956)428-4461 FAX: (956)428-0287
FIRM REGISTRATION #F-4145

WALKOVER

AT WHITECAP CIRCLE

SOUTH PADRE ISLAND,

TEXAS

CITY OF

SOUTH PADRE ISLAND,

TEXAS

P: 956-761-3044 F: 956-761-3898

DESCRIPTION

1065-16

PROJECT

CLIENT

SHEET TITLE

PROJECT NO.

MARK

DATE

IRRIGATION PLAN

SHEET NO.

SITE PLANNING

LANDSCAPE DESIGN

789 E. WASHINGTON ST. BROWNSVILLE, TX 78575

TEL (956) 547-9788 FAX (956) 547-9977

www.sspdesign.com

smr landscape architecture

STEVEN M. RAHN, INC.

1708 N. Griffin Street

Dallas, Texas 75202

Fax 214.871.0545

Email smr@smr-la.com

Tel 214.871.0083

OF 90 DAY MAINTENANCE PERIOD . (CONNECT TO QUICK COUPLERS).

MASTER VALVE AND ACTIVATES THE QUICK COUPLERS, LABEL ON

RAINBIRD PEB SERIES ELECTRIC VALVE

BACKFLOW PREVENTER (AS SIZED)

CLASS 200 PVC LATERAL PIPING

SCH. 40 PVC SLEEVING (AS SIZED)

CLASS 200 PVC MAINLINE

WATER METER (AS SIZED)

VALVE SIZE GPM

CONTROLLER (ESP-LX WITH RAIN/FREEZE SENSOR)

COLORED ZONING DIAGRAM - LOCATED ALONG MAINLINE 200' SPACING

INSTALL ALL EQUIPMENT ACCORDING TO MANUFACTURERS SPECIFICATIONS ALL VALVE BOXES SHALL BE RAINBIRD VB-STD OR APPROVED EQUAL ALL VALVE BOXES SHALL HAVE FILTER FABRIC AND 4" OF GRAVEL AT BASE

DESIGN PRESSURE 60 PSI ELECTRICAL SPLICES AT EACH VALVE AND CONTROLLER ONLY.

IRRIGATION IN TEXAS IS REGULATED
BY THE TEXAS COMMISSION ON
ENVIRONMENTAL QUALITY (TCEQ)
MC-178/ PO.BOX 13087, AUSTIN, TX
78711-3087. TECQ'S WEBSITE IS: www.tceq.state.tx.us

BUBBLER PIPING CHART		
NUMBER OF BUBBLERS	SIZE OF PIF	
1 - 5	1/2"	
6 - 10	3/4"	
11 - 20	1"	
21 - 30	1 1/4"	
31 - 40	1 1/3"	

RAINBIRD 1404 BUBBLER HEAD


RAINBIRD QUICK COUPLER VALVE (33-DLRC) QUICK COUPLERS SHALL BE CONNECTED TO MAINLINE ADD ONE ZONE THAT ACTIVATES MASTER VALVE AND ACTIVATES THE QUICK COUPLERS, LABEL ON COLORED ZONING DIAGRAM - LOCATED ALONG MAINLINE 200' SPACING

RAINBIRD PEB SERIES ELECTRIC VALVE

CONTROLLER (ESP-LX WITH RAIN/FREEZE SENSOR)

WATER METER (AS SIZED) BACKFLOW PREVENTER (AS SIZED) CLASS 200 PVC LATERAL PIPING CLASS 200 PVC MAINLINE SCH. 40 PVC SLEEVING (AS SIZED) VALVE SIZE

TEMPORARY IRRIGATION

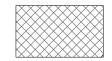


TEMPORARY IRRIGATION (ROTORS) TO COVER DUNE RESTORATION AREA TO REMAIN UNTIL END OF 90 DAY MAINTENANCE PERIOD . (CONNECT TO QUICK COUPLERS).

DESIGN PRESSURE 60 PSI ELECTRICAL SPLICES AT EACH VALVE AND CONTROLLER ONLY.

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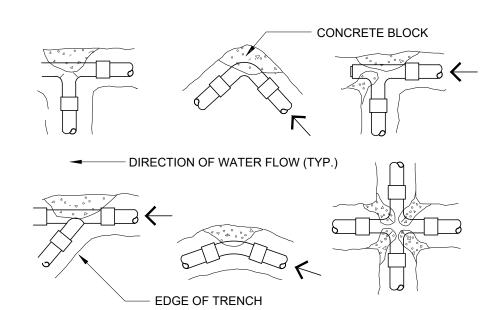
BUBBLER PIPING CHART NUMBER OF BUBBLERS 6 - 10 11 - 20 1 1/4" 21 - 30 1½" 31 - 40

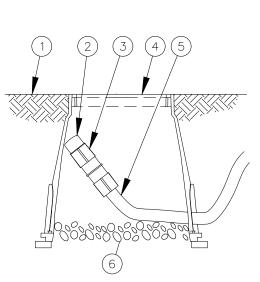

(1) FINISH GRADE (2) FLUSH CAP FOR EASY FIT CORVRESSION FITTINGS: POTABLE: RAIN BIRD MDCFCAP NON-POTABLE: RAIN BIRD MDCFPCAP 3) EASY FIT COUPLING: RAIN BIRD MDCFCOUP (4) SUBTERRANEAN EMITTER BOX: RAIN BIRD SEB 7XB 5) SUB-SURFACE DRIPLINE: RAIN BIRD XF SERIES DRIPLINE POTABLE: XFS DRIPLINE NON-POTABLE: XESP DRIPLINE 6) 3-INCH MINIMUM DEPTH OF 3/4-INCH WASHED GRAVEL WITH FILTER FABRIC AT BASE

> 1. ALLOW A MINIMUM OF 6-INCHES OF DRIPLINE TUBING IN VALVE BOX IN ORDER TO DIRECT FLUSHED WATER OUTSIDE VALVE BOX.






PIPE SIZE	1 1/4" - 2 1/2"	3"	4"	
TEES/ELLS	1.00	1.00	1.25	3.8"
90 BENDS	1.00		2.00	4.5 2.4
45 BENDS	1.00	1.00	1.00	2.4
NOTE: INSTALL THRUST BLOCK AT ALL MAINLINE BENDS, TEES OR ELLS AS SHOWN BELOW. THRUST BLOCKS SHALL BE MINIMUM OF (1) CU. FT. REDI-MIX CONCRETE OR 2500 PSI 28 DAY CONCRETE.				

NOT TO SCALE

IRRIGATION NOTES

- 1. All equipment numbers reference Rainbird equipment catalog unless otherwise indicated.
- 2. LAWN SPRAY HEADS are RVAN installed as per detail.
- 3. SHRUB SPRAY HEADS are RVAN installed as per detail.
- 4. ELECTRIC CONTROL VALVES shall be PEB installed as per detail shown. Size valves as shown on plans. Valves shall be installed in valve boxes large enough to permit manual operation, removal of solenoid and/or valve cover without any earth excavation. (Refer to Specifications)
- 5. AUTOMATIC CONTROLLER shall be installed at location shown. Power (120V) shall be located in a junction box within five feet (5') of controller location. Power supply and junction box to be provided by General Contractor.
- All 24 volt valve wiring is to be UF 14 single conductor. All wire splices are to be permanent and waterproof. (Refer to Specifications)
- 7. SLEEVES shall be supplied and installed by Irrigation Contractor. Sleeve material shall be Schedule 40. Bore under existing pavement as required. Sizes as indicated on plans.
- 8. Ten days prior to start of construction, contractor shall verify static water pressure. If static pressure is less than 50 PSI, do not start work until notified to do so by SSP Design.
- 9. All mainline and lateral piping shall have a minimum of 12 inches of cover. All piping under paving shall have a minimum of 18 inches of cover. (Refer to Specifications).
- 10. The irrigation contractor shall coordinate installation of the system with the landscape contractor so that all plant material will be watered in accordance with the intent of the plans and specifications.
- 11. The irrigation contractor shall select the proper arc and radius for each nozzle to insure 100% and proper coverage of all lawn areas and plant material. All nozzles in parking lots and planting beds shall be low angle to minimize overspray on pavement surfaces. No water will be allowed to spray on building.
- 12. The irrigation contractor shall warranty all system components for a period of one year plus 20 days. (Refer to Specifications).
- 13. See specifications for further instructions and project requirements. Contractor shall follow specification section 328000 - Site Irrigation for any discrepancies between plans and specifications.

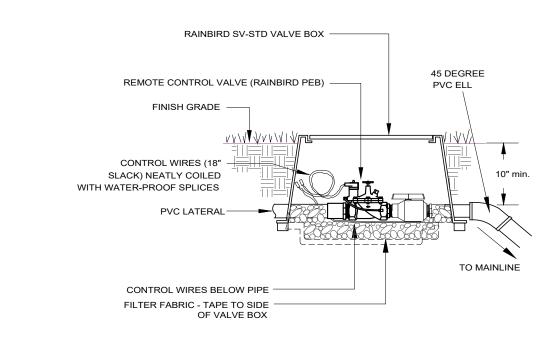

ALL VALVE BOXES SHALL HAVE FILTER FABRIC AND 4" OF GRAVEL AT BASE



- MIPT x S ELL

12" ABOVE HIGHEST

TO CONTROL

VALVE

HEAD OF SYSTEM

PRESSURE VACUUM BREAKER INSTALL UPSTREAM OF

CONTROL VALVES


PAINT ALL CONDUITS -

GATE VALVES

DARK GREEN

FROM MAINLINE

SxSELL

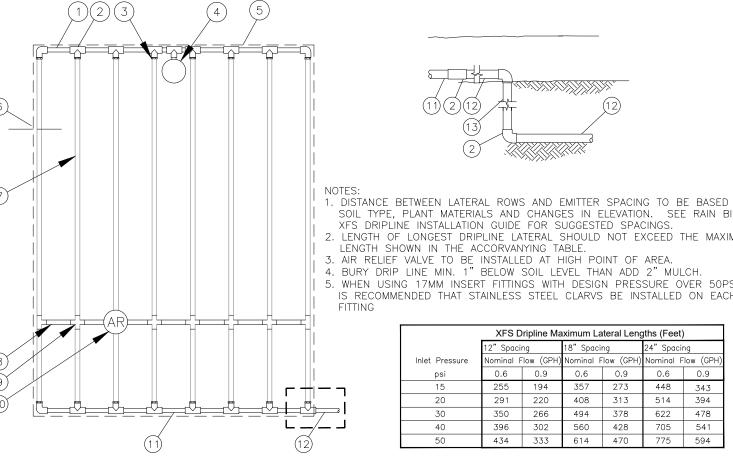



MAXIMUM BOTTOM DIMENSION


STANDARD VALVE BOX DIMENSIONS

ALL VALVE BOXES SHALL BE RAINBIRD VB-STD OR APPROVED EQUAL

ALL VALVE BOXES SHALL HAVE FILTER FABRIC AND 4" OF GRAVEL AT BASE

VALVE BOX (VB-STD)

BOTTOM OPENING 18.72 "

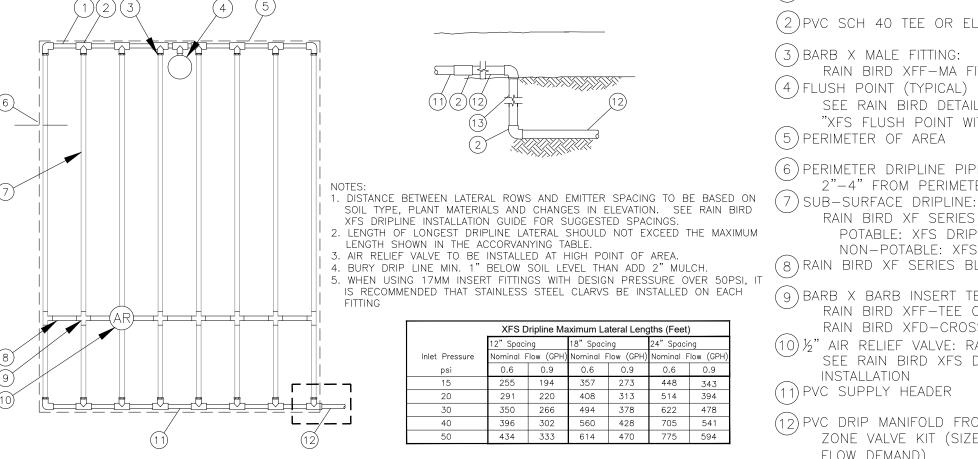

(1) PVC EXHAUST HEADER

(2)PVC SCH 40 TEE OR EL (TYPICAL)

(3) BARB X MALE FITTING: RAIN BIRD XFF-MA FITTING (TYPICAL) (4) FLUSH POINT (TYPICAL) SEE RAIN BIRD DETAIL "XFS FLUSH POINT" OR

(5) PERIMETER OF AREA (6) PERIMETER DRIPLINE PIPE TO BE INSTALLED

"XFS FLUSH POINT WITH BALL VALVE"

2"-4" FROM PERIMETER OF AREA RAIN BIRD XF SERIES DRIPLINE (TYPICAL) POTABLE: XFS DRIPLINE

NON-POTABLE: XFSP DRIPLINE

(8) RAIN BIRD XF SERIES BLANK TUBING (9) BARB X BARB INSERT TEE OR CROSS: RAIN BIRD XFF-TEE OR

RAIN BIRD XFD-CROSS (TYPICAL) (10) 1/2" AIR RELIEF VALVE: RAIN BIRD MODEL: ARVO50 SEE RAIN BIRD XFS DETAILS FOR AIR RELIEF INSTALLATION (11) PVC SUPPLY HEADER

(12) PVC DRIP MANIFOLD FROM RAIN BIRD CONTROL ZONE VALVE KIT (SIZED TO MEET LATERAL

FLOW DEMAND) (13) PVC SCH 40 RISER PIPE



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CONSULTING STRUCTURAL ENGINEERS 1220 WEST HARRISON HARLINGEN, TEXAS 78550 PH: (956)428-4461 FAX: (956)428-0287 FIRM REGISTRATION #F-4145

SEAL



PROJECT

WALKOVER AT WHITECAP CIRCLE

SOUTH PADRE ISLAND,

TEXAS

CLIENT



SOUTH PADRE ISLAND, **TEXAS**

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MARK DATE DESCRIPTION

PROJECT NO.	1065–16
DATE	04-22-2022
DRAWN BY	PLM
CHECKED BY	SSP

AS SHOWN


IRRIGATION

DETAILS


SHEET NO.


SCALE

SHEET TITLE

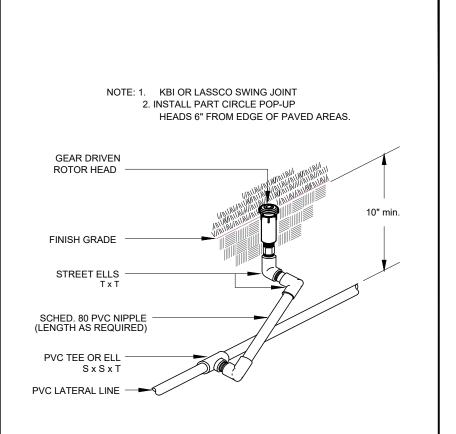



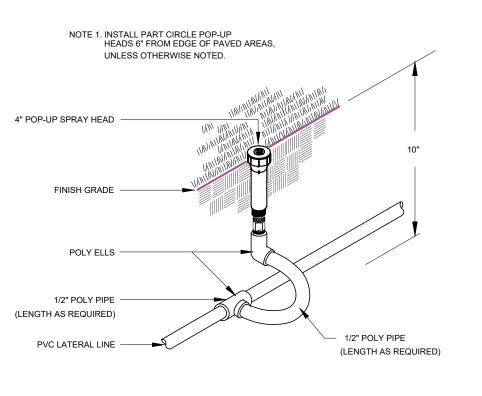

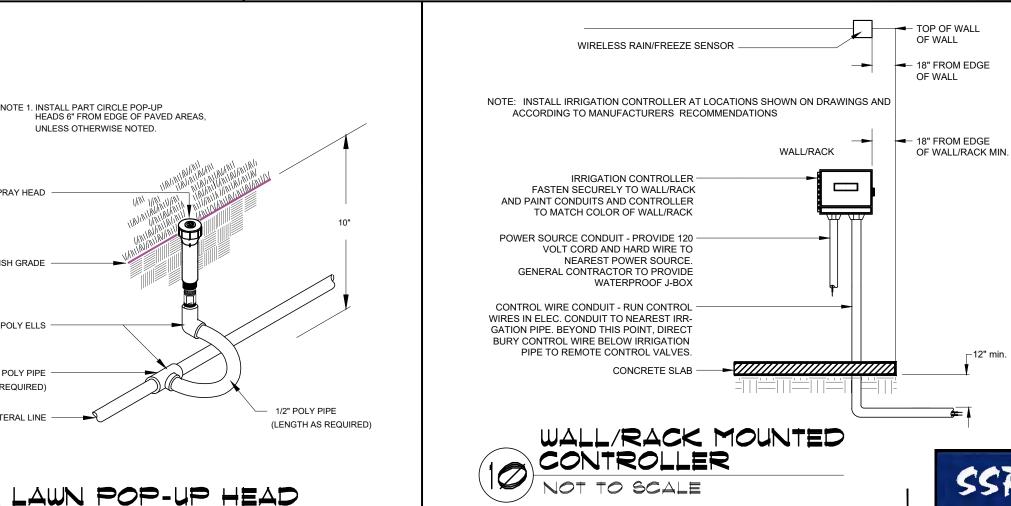

1. PLACE TIE DOWN STAKES EVERY THREE FEET IN SAND, FOUR

3. SAVE YOUR HANDS. USE THE RAIN BIRD FITTINS—TOOL XF INSERTION TOOL FOR FITTING ASSEMBLY.

2. AT FITTINGS WHERE THERE IS A CHANGE OF DIRECTION SUCH AS

TEES OR ELBOWS, USE TIE-DOWN STAKES ON EACH LEG OF

FEET IN LOAM, AND FIVE FEET IN CLAY.

THE CHANGE OF DIRECTION.

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(1) ON-SURFACE DRIPLINE:

3 BARB TEE 17x17x17mm RAIN BIRD XFF-TEE

4 BARB COUPLING 17x17mm RAIN BIRD XFF-COUP

5 BARB ELBOW 17x17mm RAIN BIRD XFF-ELBOW

17mm X 1/2" RVT RAIN BIRD XFF-MA-050

RAIN BIRD XFF-MA-075

RAIN BIRD XF SERIES BLANK TUBING LENGTH AS REQUIRED

RAIN BIRD TDS-050 WITH BEND (TYPICAL)

17mm X 3/4" RVT

(8) PVC LATERAL SUPPLY HEADER

(6) BARB MALE ADAPTER


(7) PVC TEE SxSxT


(9) TIE DOWN STAKE:

POTABLE: XFS DRIPLINE
NON-POTABLE: XFSP DRIPLINE

2 INLINE DRIP EMITTER OUTLET, SEE PLANS FOR DRIPLINE OUTLET SPACING.



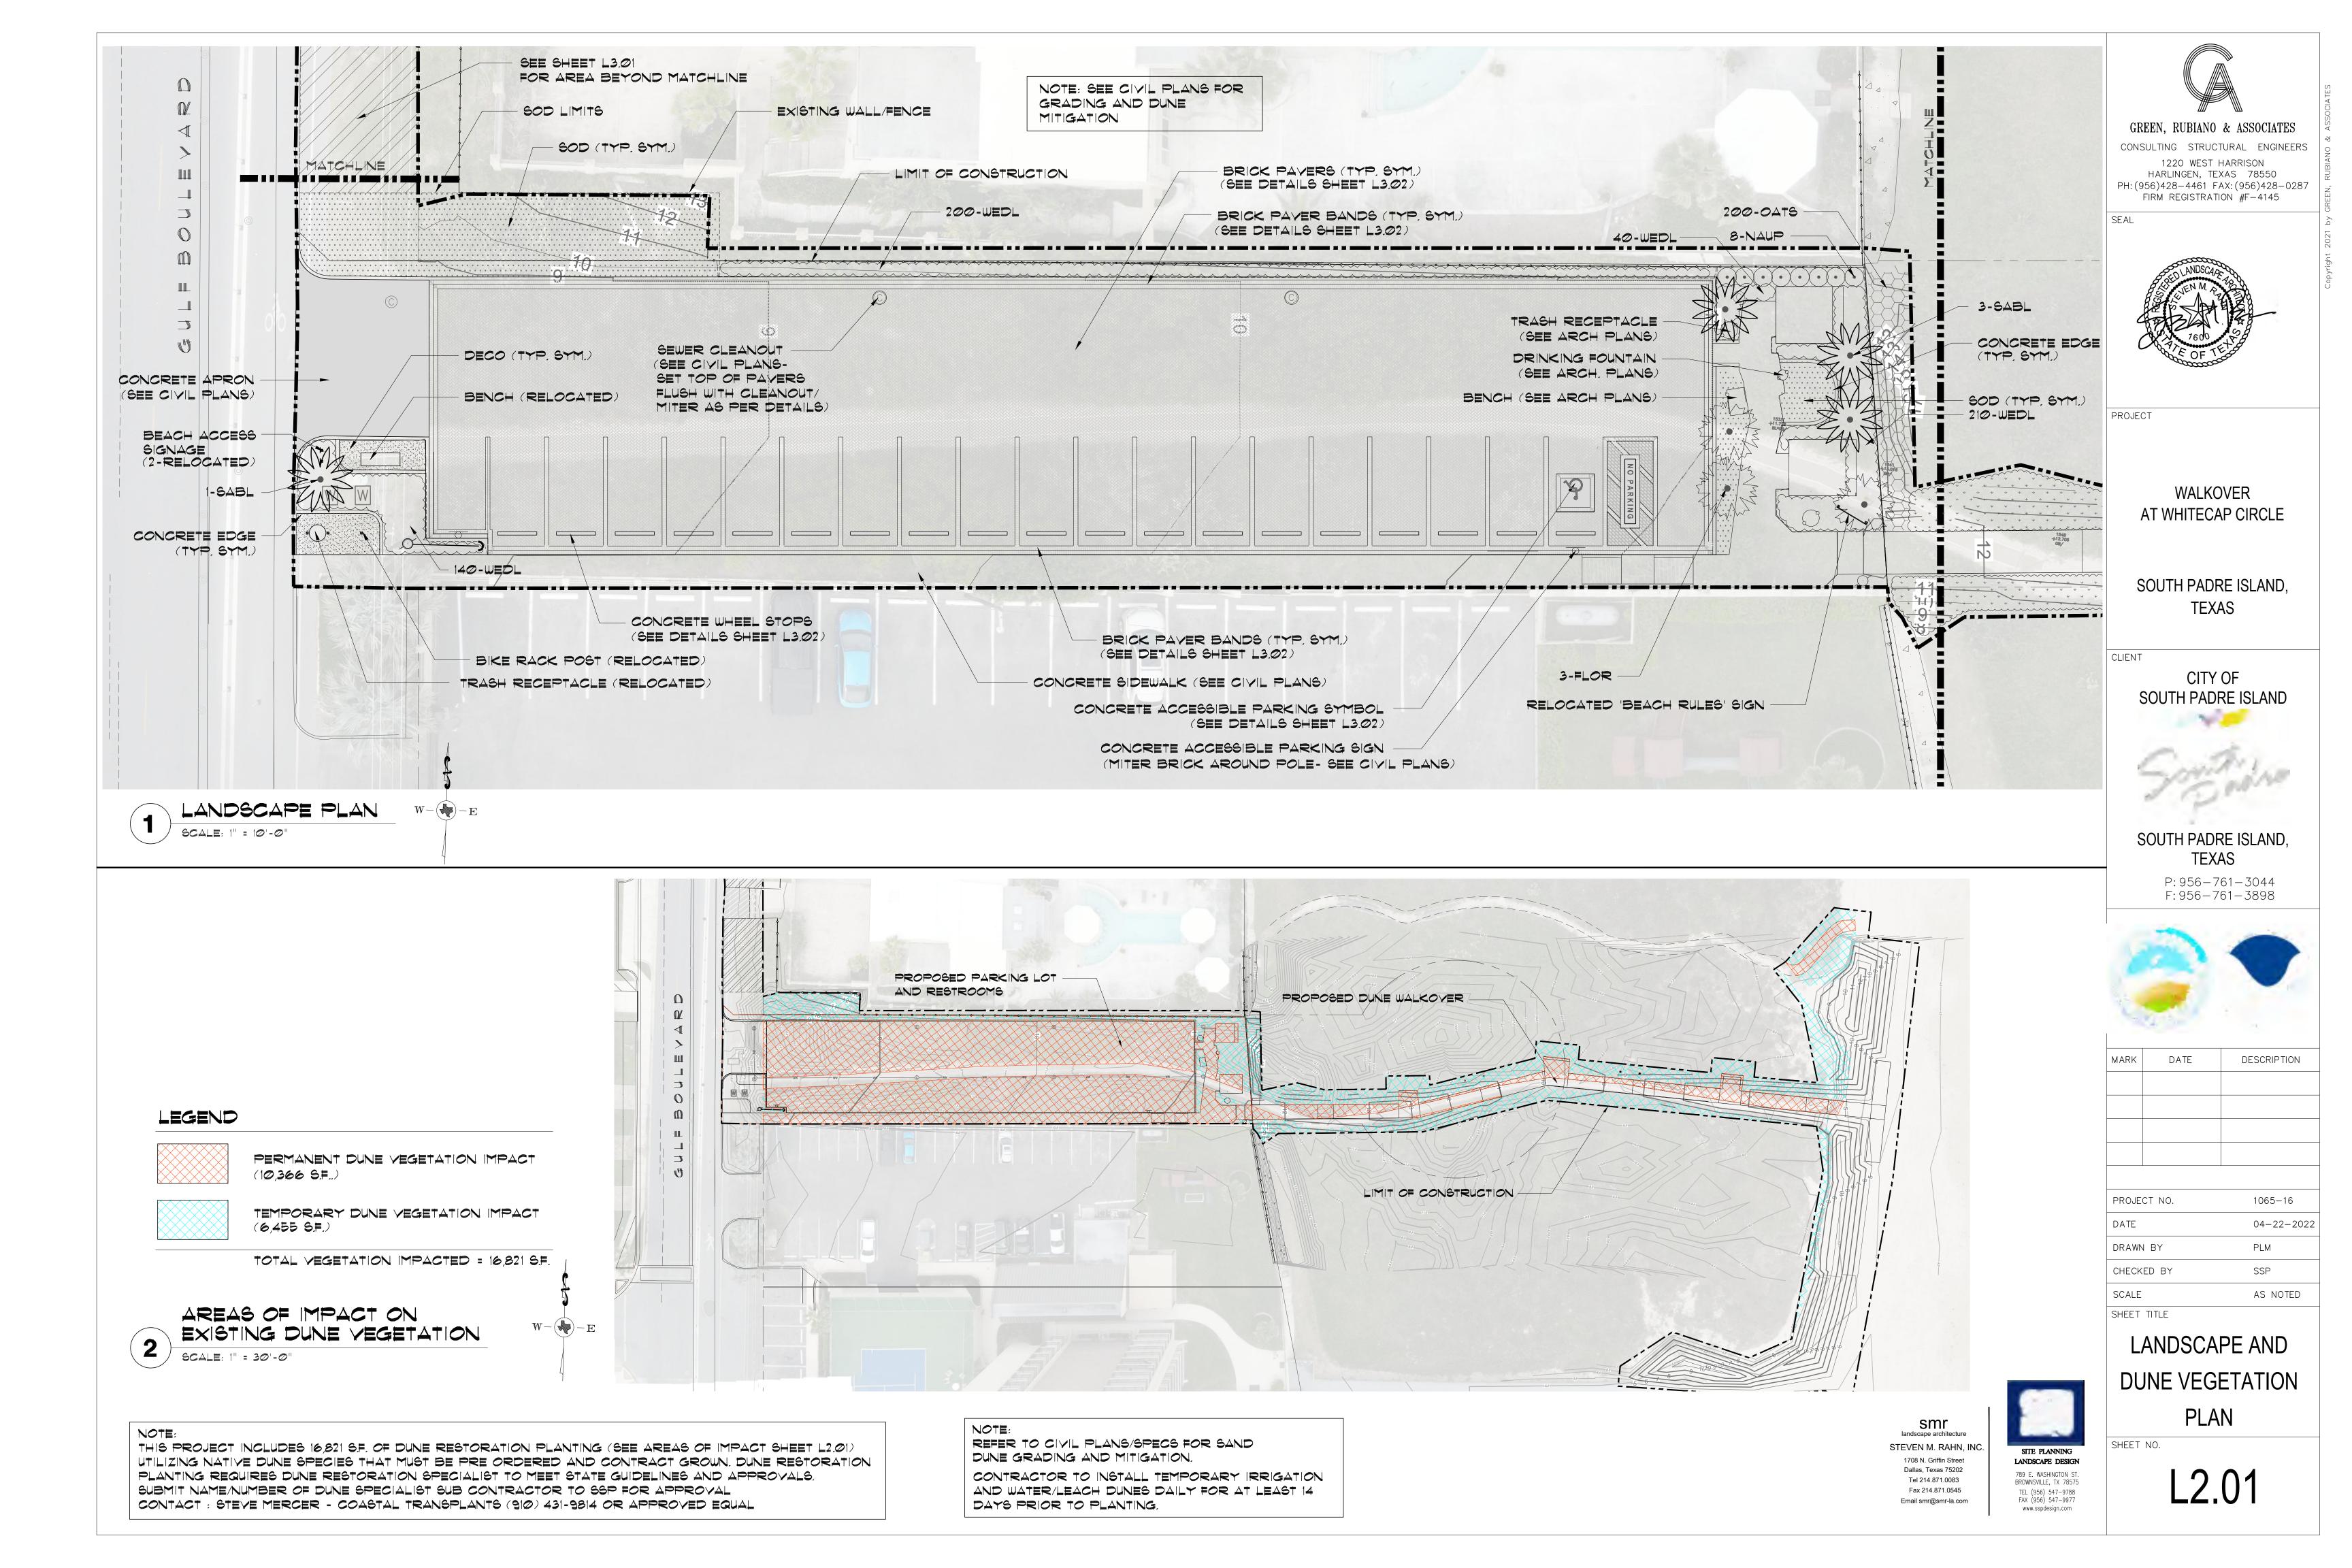

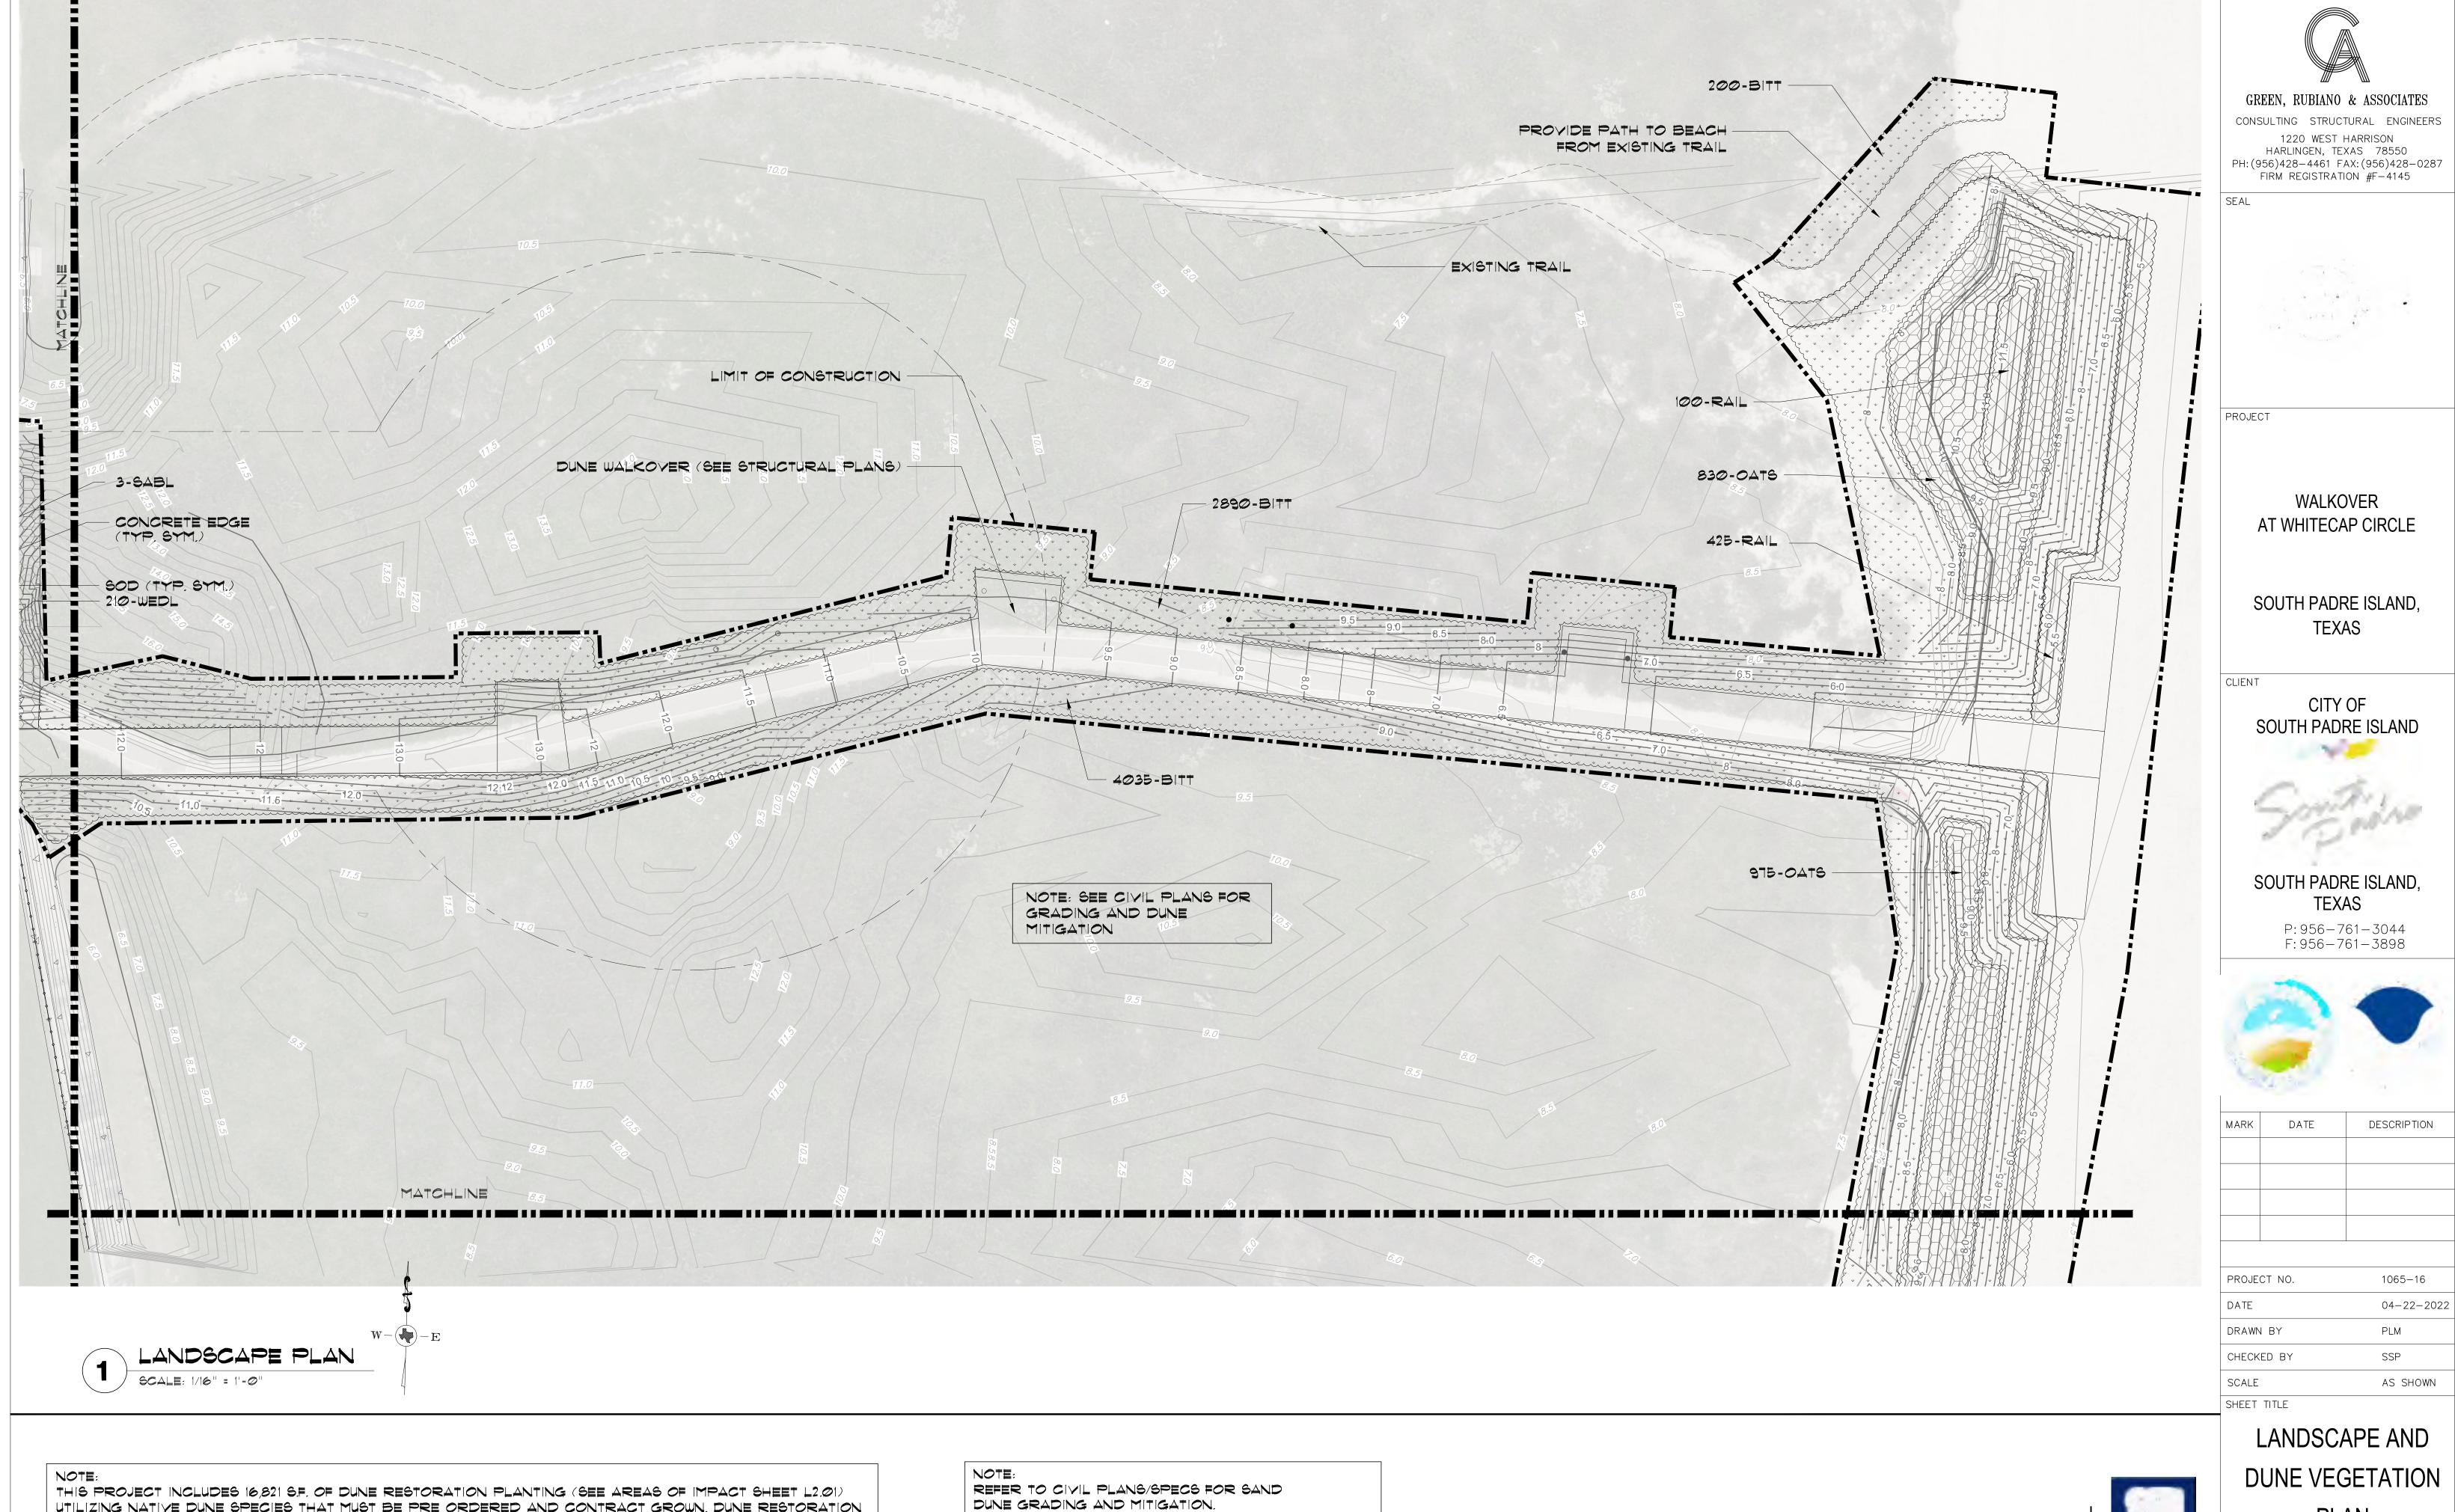

UTILIZING NATIVE DUNE SPECIES THAT MUST BE PRE ORDERED AND CONTRACT GROWN. DUNE RESTORATION PLANTING REQUIRES DUNE RESTORATION SPECIALIST TO MEET STATE GUIDELINES AND APPROVALS. Submit Name/Number of Dune Specialist sub contractor to SSP for approval CONTACT: STEVE MERCER - COASTAL TRANSPLANTS (910) 431-9814 OR APPROVED EQUAL


CONTRACTOR TO INSTALL TEMPORARY IRRIGATION AND WATER/LEACH DUNES DAILY AT LEAST 14 DAYS PRIOR TO PLANTING.

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PLAN

SHEET NO.



THIS PROJECT INCLUDES 16,821 S.F. OF DUNE RESTORATION PLANTING (SEE AREAS OF IMPACT SHEET L2.01) UTILIZING NATIVE DUNE SPECIES THAT MUST BE PRE ORDERED AND CONTRACT GROWN. DUNE RESTORATION PLANTING REQUIRES DUNE RESTORATION SPECIALIST TO MEET STATE GUIDELINES AND APPROVALS. Submit name/number of dune specialist sub contractor to SSP for approval CONTACT: STEVE MERCER - COASTAL TRANSPLANTS (910) 431-9814 OR APPROVED EQUAL

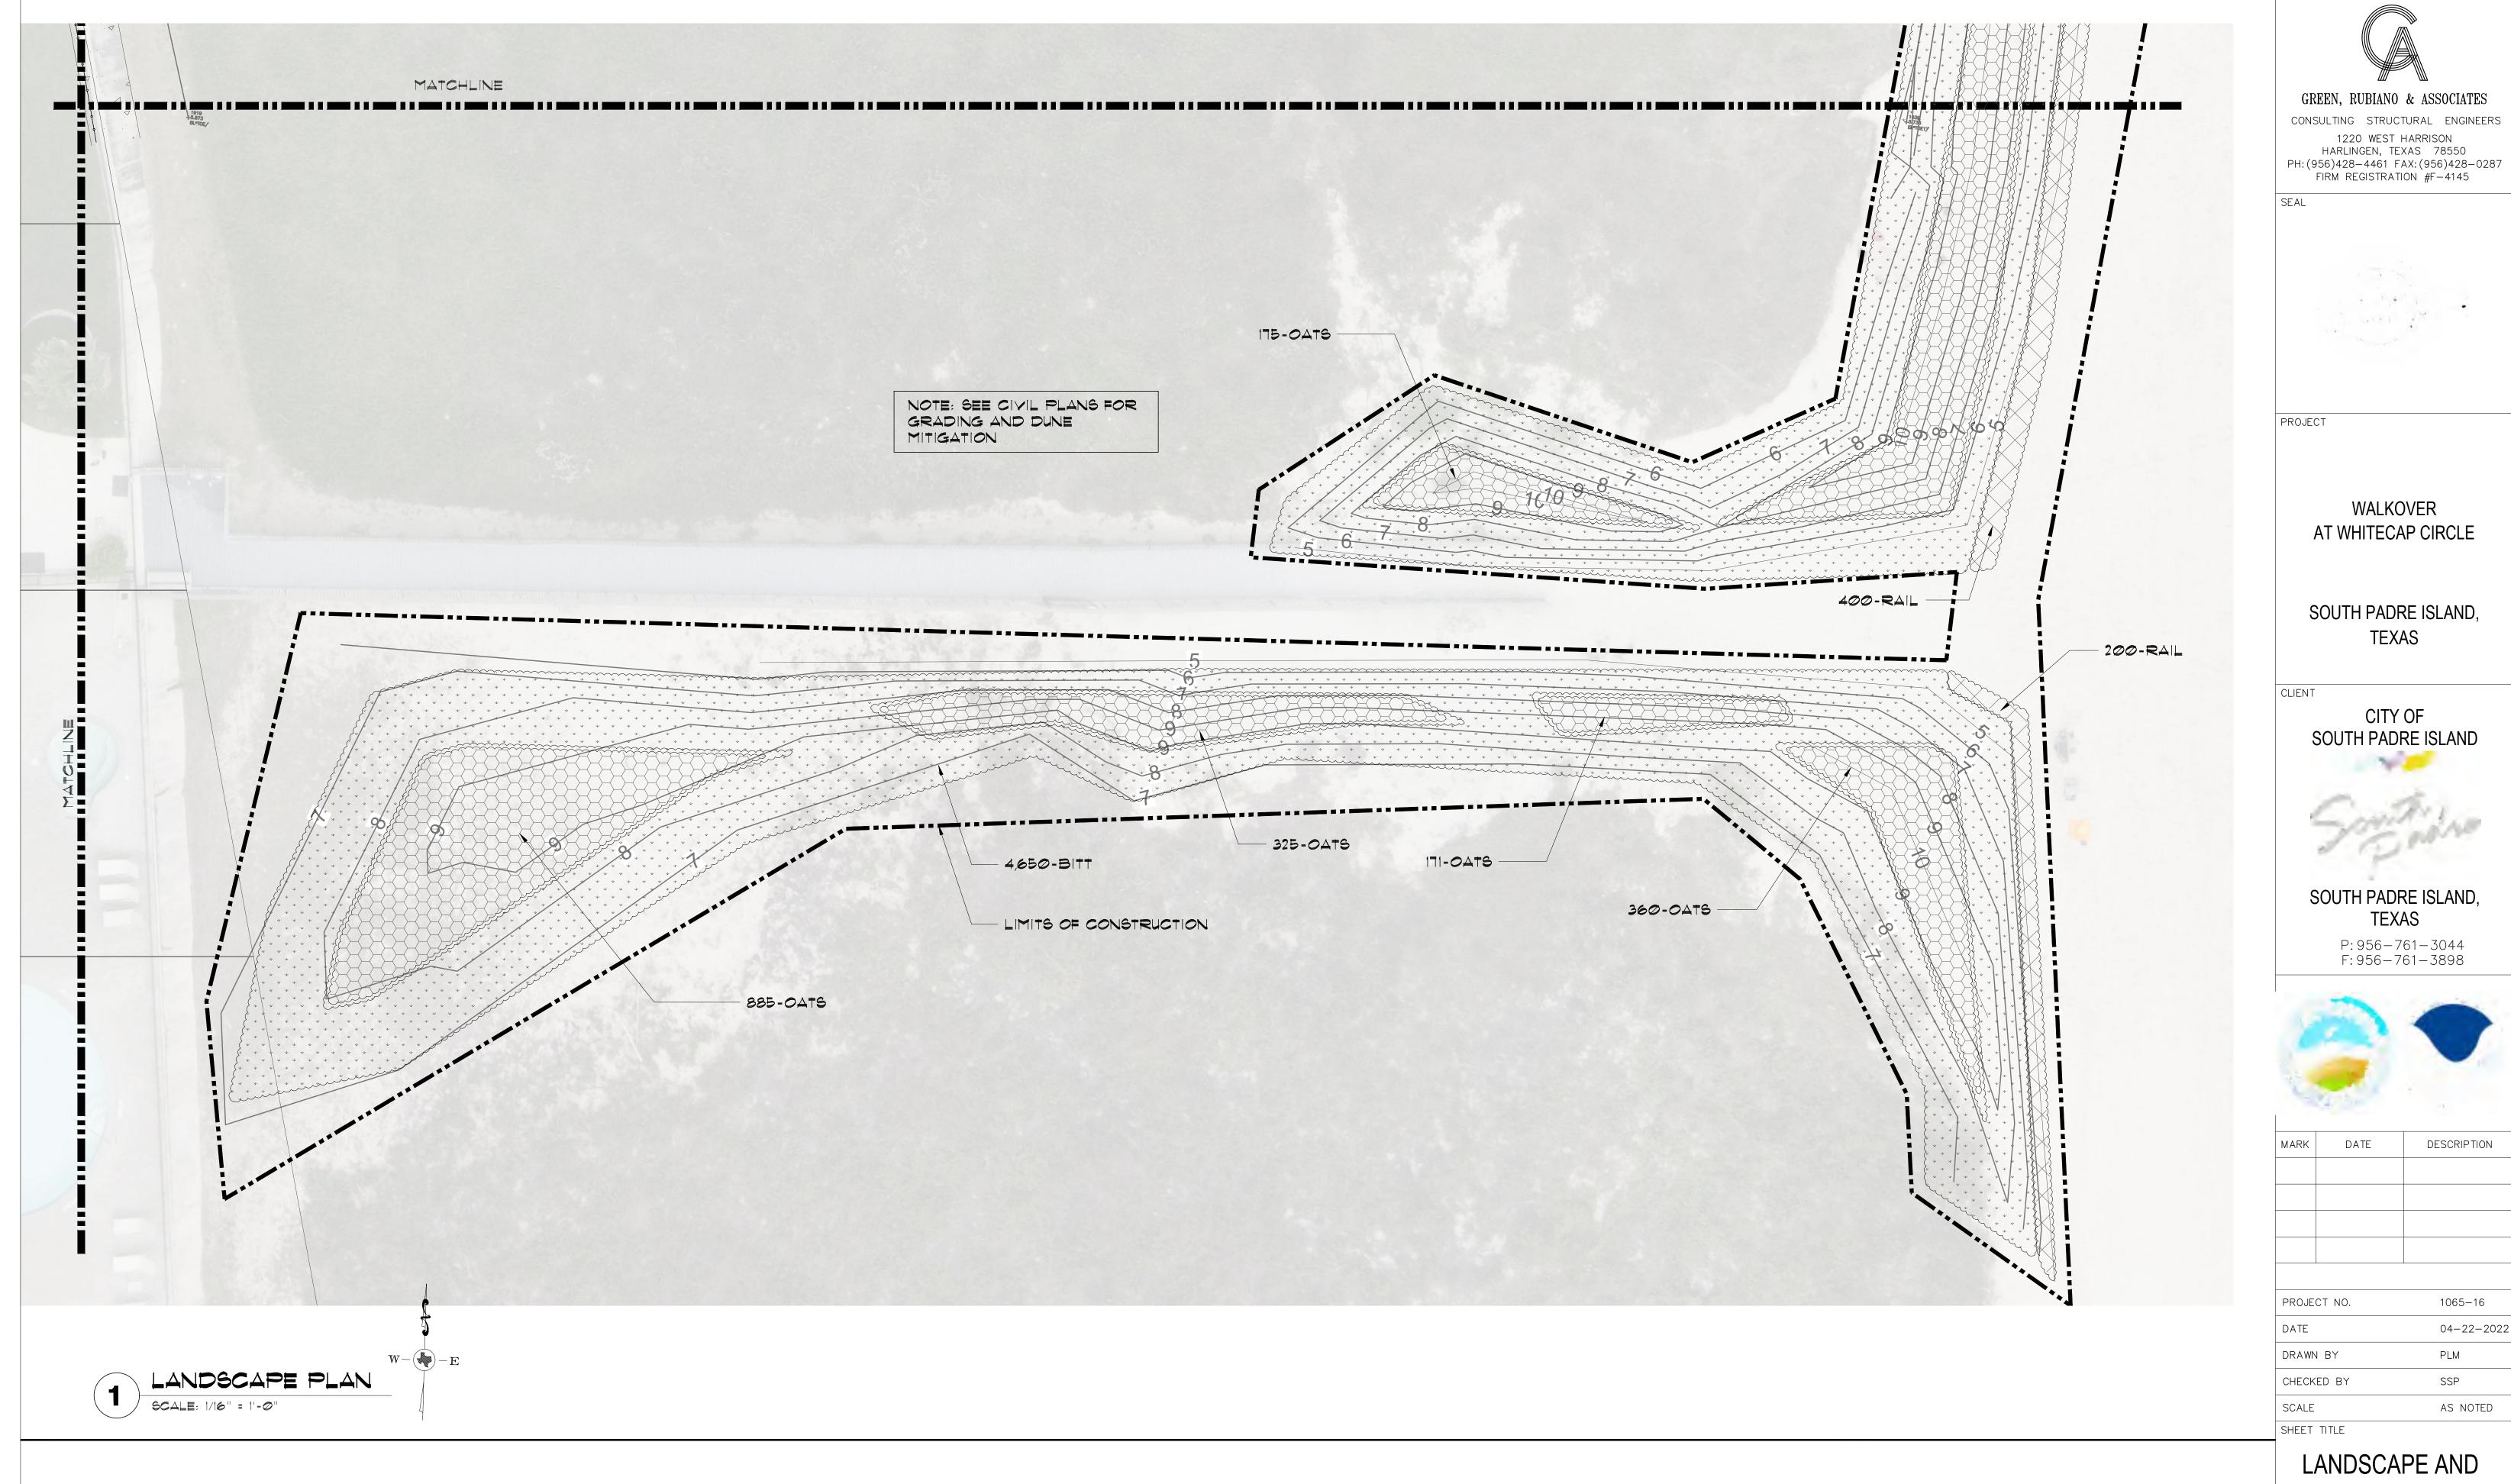REFER TO CIVIL PLANS/SPECS FOR SAND DUNE GRADING AND MITIGATION.

CONTRACTOR TO INSTALL TEMPORARY IRRIGATION AND WATER/LEACH DUNES DAILY AT LEAST 14 DAYS PRIOR TO PLANTING.

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DUNE VEGETATION

PLAN

SHEET NO.

PLANT SCHEDULE (SITE)

CODE	BOTANICAL NAME	COMMON NAME	TYPE	SIZ≣	SPACING	QTY
	PALMS					
FLOR	SABAL PALMETTO	FLORIDA SABAL PALM	B/B	10-12' TRUNK	A.S.	3
SABL	SABAL TEXANA	TEXAS SABAL PALM	B/B	10-12' TRUNK	A.S.	4
	SHRUBS					
NAUP	SCAEVOLA FRUTESCENS	NAUPAKA	3 GAL	18"HT-BUSHY	A.S.	8
GREE	FICUS MICROCARPA	GREEN ISLAND FICUS	3 GAL	12"HT-BUSHY	24" O.C.	60
	GROUND COVERING					
WEDL	WEDELIA TRILOBATA	WEDELIA	4" POTS		12" O.C.	590
	GRASS					
50D	STENOTAPHRUM SECUNDATUM	# CERTIFIED 'FLORATAM' ST. AUGUST	NE SOD		110 5.	Υ.

PLANT SCHEDULE (DUNE RESTORATION)

CODE	BOTANICAL NAME	COMMON NAME	TYPE	SIZE	SPACING	QTY
	DUNE PLANTS					
BITT	PANICUM AMARUM	BITTER PANICUM	2"	TRAYS/CUTTINGS	1 PER S.F.	11,775
OATS	UNIOLA PANICULATA	SEA OATS	2"	TRAYS/CUTTINGS	1 PER S.F.	3,921
RAIL	IPOMOEA PES-CAPRAE	RAILROAD VINE	2"	TRAYS/CUTTINGS	1 PER S.F.	1,125

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MATERIAL SCHEDULE


DESCRIPTION	NOTES	QUANTITY
REMOVAL AND RELOCATION	REMOVAL AND RELOCATION OF EXISTING SIGNAGE, BENCH AND TRASH RECEPTACLE AS PER PLANS	-
REPAIRS (DISTURBED AREAS BY UTILITIES)	REPAIR/REPLACE EXISTING IRRIGATION/SOD DISTURBED BY PROPOSED UTILITIES AS SHOWN IN DETAIL 5 (SHEET L3.01)	-
PREMIUM COMPOST	2" LAYER PREMIUM COMPOST (EARTHWISE ORGANICS MIX) (NOT FOR DUNE AREA)	16 C.Y.
SCREENED TOP SOIL	8" FOR ALL PLANTING BEDS (NOT FOR DUNE AREA)	60 C.Y.
MULCH (HARDWOOD)	2" MIN. FOR ALL PLANTING BEDS AND WATERING BASINS (TEXAS NATIVES HARDWOOD)	220 BAGS (2 C.F.)
HERBICIDE	all planting bed areas as specified	2,416 S.F.
FERTILIZER	ALL PLANT MATERIAL PER DETAILS	2,416 S.F.
PLANTING TABLETS	PER DETAILS / AS SPECIFIED	-
PRE-EMERGENT	all planting bed areas as specified	2,416 S.F.
GUYING / STAKING	ALL TREES/PALMS PER DETAILS	٦
DECØ	4" COMPACTED DECOMPOSED GRANITE 'FINES' 1/4" MINUS PER PLANS/DETAILS	140 S.F.
CONCRETE EDGE	6×6 " extruded colored 'texas buff' concrete edging per plans/details	70 L.F.
irrigation system	COMPLETE AUTOMATIC IRRIGATION SYSTEM BY LICENSED CONTR. PER PLAN/SPECS	-

NOTE: CONTRACTORS MUST REVIEW TECHNICAL SPECIFICATIONS FOR ADDITIONAL PRODUCT INFORMATION AND PROJECT REQUIREMENTS,

LANDSCAPE CONSTRUCTION NOTES

- , WORK UNDER THIS CONTRACT INCLUDES SITE REVIEW AND COORDINATION WITH EXISTING CONDITIONS, SITE CLEANUP, EXCAVATION, BED PREP, TILLING, DUNE RESTORATION, PLANTING, STAKING, IRRIGATION, MAINTENANCE, AND GUARANTEE.
- 2. LANDSCAPE CONTRACTOR SHALL FIELD YERIFY ALL QUANTITIES AND DIMENSIONS PRIOR TO BIDDING. QUANTITIES SHOWN IN SCHEDULE ARE FOR CONVENIENCE ONLY.
- 3. NOTIFY SSP DESIGN PRIOR TO BID OF ANY DISCREPANCIES IN DRAWINGS/DETAILS OR INSUFFICIENT QUANTITIES DUE TO DIFFERENCES IN PLAN AND ACTUAL FIELD CONDITIONS.
- 4. LANDSCAPE CONTRACTOR SHALL BE RESPONSIBLE FOR LOCATING AND PROTECTING ALL EXISTING UTILITIES. SPOTTING OF ALL utilities is required.
- 5. NOTIFY AND MEET WITH SSP DESIGN PRIOR TO ANY CONSTRUCTION FOR VERIFICATION/INTERPRETATION OF PLANS.
- 6. LANDSCAPE CONTRACTOR SHALL VERIFY ALL PROPERTY BOUNDARIES AND LIMITS OF WORK WITH GENERAL CONTRACTOR/CIVIL ENGINEER. DO NOT BEGIN LANDSCAPE CONSTRUCTION UNTIL ALL BOUNDARIES, EASEMENTS AND RIGHTS-OF-WAY HAVE BEEN YERIFIED IN THE FIELD.
- 7. LANDSCAPE CONTRACTOR SHALL STAKE OUT ALL BEDS, TREES, PALM LOCATIONS PRIOR TO INSTALLATION FOR APPROVAL by SSP Design.
- 8. LANDSCAPE CONTRACTOR TO COORDINATE WITH SSP DESIGN TO ENSURE PROPER PLACEMENT OF PLANT MATERIAL AND IRRIGATION EQUIPMENT.
- 9. LANDSCAPE CONTRACTOR TO INSTALL EDGING AS SHOWN ON PLANS/DETAILS.
- 10. NOTIFY SSP DESIGN PRIOR TO PLANTING OPERATIONS FOR APPROVAL OF ALL PLANT MATERIAL ON SITE. ANY PLANT MATERIAL NOT APPROVED BY SSP DESIGN WILL BE SUBJECT TO REJECTION.
- 11. IRRIGATION CONTRACTOR SHALL SUPPLY AND INSTALL COMPLETE AUTOMATIC IRRIGATION SYSTEM INCLUDING WATER METER, BACKFLOW DEVICE, CONTROLLER, MAINLINE, SLEEVES, LATERALS, AND POP-UP HEADS, TO COVER ALL LANDSCAPE AREAS PER PLANS/DETAILS, IRRIGATION SYSTEM SHALL BE INSTALLED BY A TEXAS LICENSED IRRIGATOR ONLY.
- 12. LANDSCAPE CONTRACTOR SHALL REMOVE ALL EXISTING GRASS/WEEDS BY HERBICIDING PRIOR TO BED PREP AND SOIL REPLACEMENT.
- 13. LANDSCAPE CONTRACTOR SHALL REMOVE 12" OF EXST'G SOIL WITHIN ALL BED AREAS AND REPLACE WITH IMPORTED TOP SOIL/PREMIUM COMPOST MIX.
- 14. LANDSCAPE CONTRACTOR SHALL CONSTRUCT 6"x36" WATERING BASINS AROUND ALL TREES/PALMS WITH A MIN. 2" LAYER OF
- 15. LANDSCAPE CONTRACTOR SHALL LOOSEN / GRADE ALL BED AREAS PRIOR TO PLANTING TO ENSURE
- PROPER DRAINAGE AND UNIFORM SURFACE. 16. LANDSCAPE CONTRACTOR SHALL REMOVE ALL EXISTING GRASS AND WEEDS BY HERBICIDING, DISKING, FLOATING AND LIGHT
- 17. LANDSCAPE CONTRACTOR SHALL ESTABLISH AND MAINTAIN ALL PLANT MATERIAL FOR 90 DAYS AFTER 'SUBSTANTIAL COMPLETION' AND SHALL GUARANTEE ALL TREES/PALMS FOR A PERIOD OF ONE YEAR.
- 18. IRRIGATION CONTRACTOR SHALL GUARANTEE ALL SYSTEM COMPONENTS FOR A PERIOD OF ONE YEAR.
- 19. SEE SPECIFICATIONS FOR FURTHER INSTRUCTIONS/REQUIREMENTS.

GRADING OF ENTIRE PROJECT AREA PRIOR TO PLANTING.

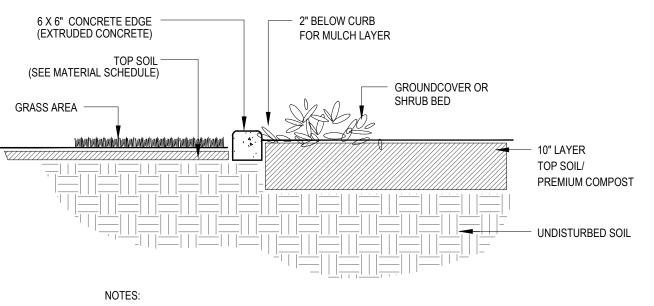

1. CONCRETE CURBING TO HAVE 1 1/2" DEEP CONTRACTION JOINTS @ 5'-0" SPACING. 2. CONCRTE CURBING TO HAVE TAPERED DRAINAGE POINTS AT 10' O.C. 3. 2500-3000 PSI COMPRESSIVE STRENGTH, 490 PSI FLEXURAL STRENGTH. 4. USE HALF-INCH POLYPROPYLENE FIBER REINFORCEMENT. 5. EQUAL TO 'CONTOUR CURBS' EDGING (956-867-8350). CONTOURCURBS.NET



GREEN. RUBIANO & ASSOCIATES CONSULTING STRUCTURAL ENGINEERS 1220 WEST HARRISON HARLINGEN, TEXAS 78550 PH: (956)428-4461 FAX: (956)428-0287 FIRM REGISTRATION #F-4145 SEAL

PROJECT

WALKOVER AT WHITECAP CIRCLE

SOUTH PADRE ISLAND, **TEXAS**

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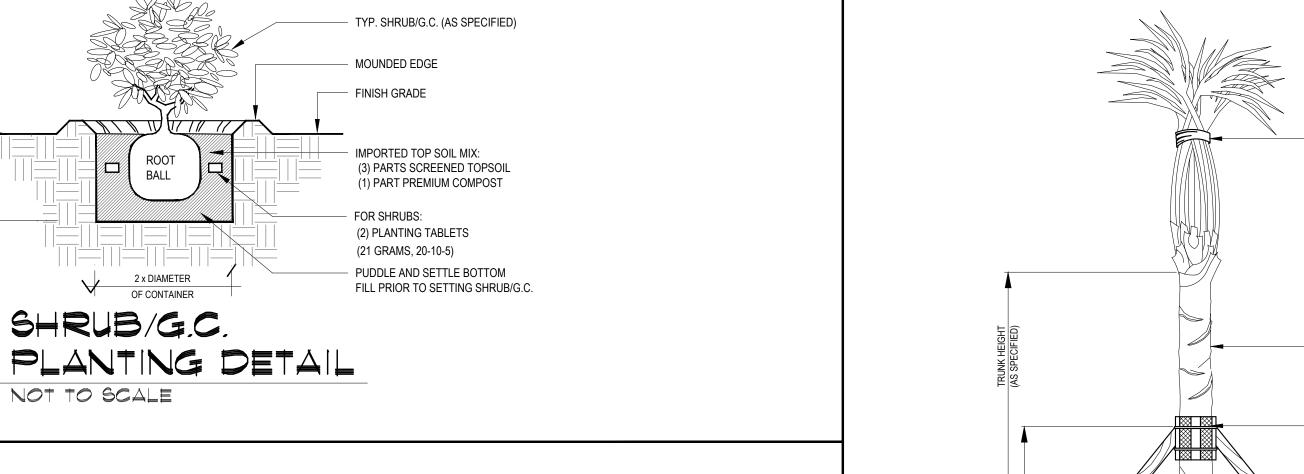
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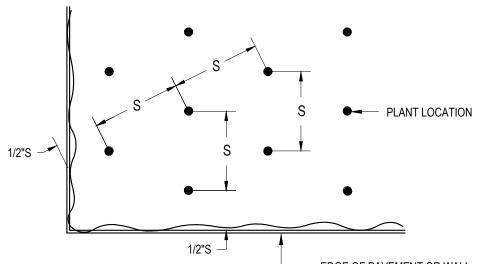
SHEET TITLE

LANDSCAPE SCHEDULES AND **DETAILS**

SHEET NO.

L3.01





ROOT

BALL


2 x DIAMETER

SHRUB/G.C.


NOT TO SCALE

 EDGE OF PAVEMENT OR WALL NOTES: 1. S = SPACING, (REFER PLANT LIST FOR AMOUNT OF SPACING.) 2. USE SPACING LAYOUT FOR SHRUBS, GROUNCOVERS AND ANNUALS.

TRIANGULAR PLANT SPACING DIAGRAM

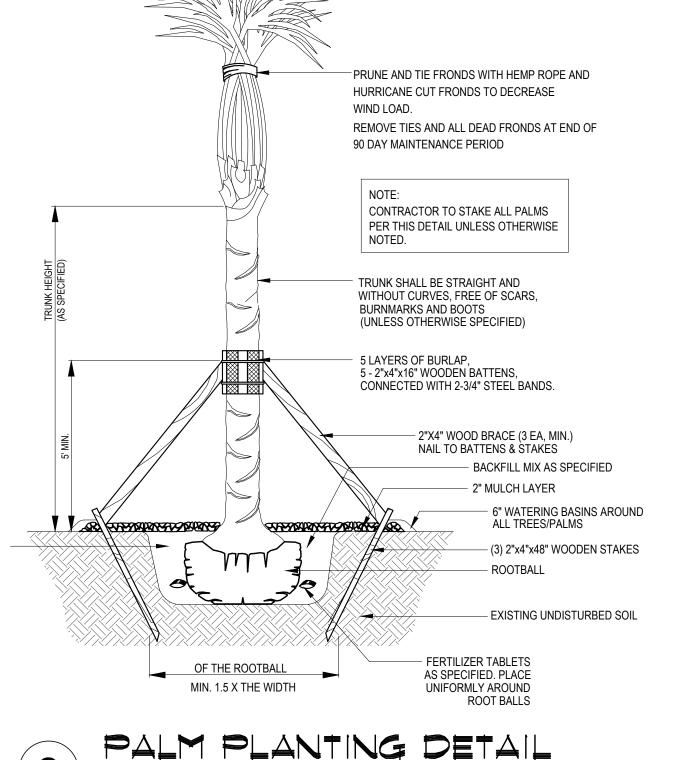

NOT TO SCALE

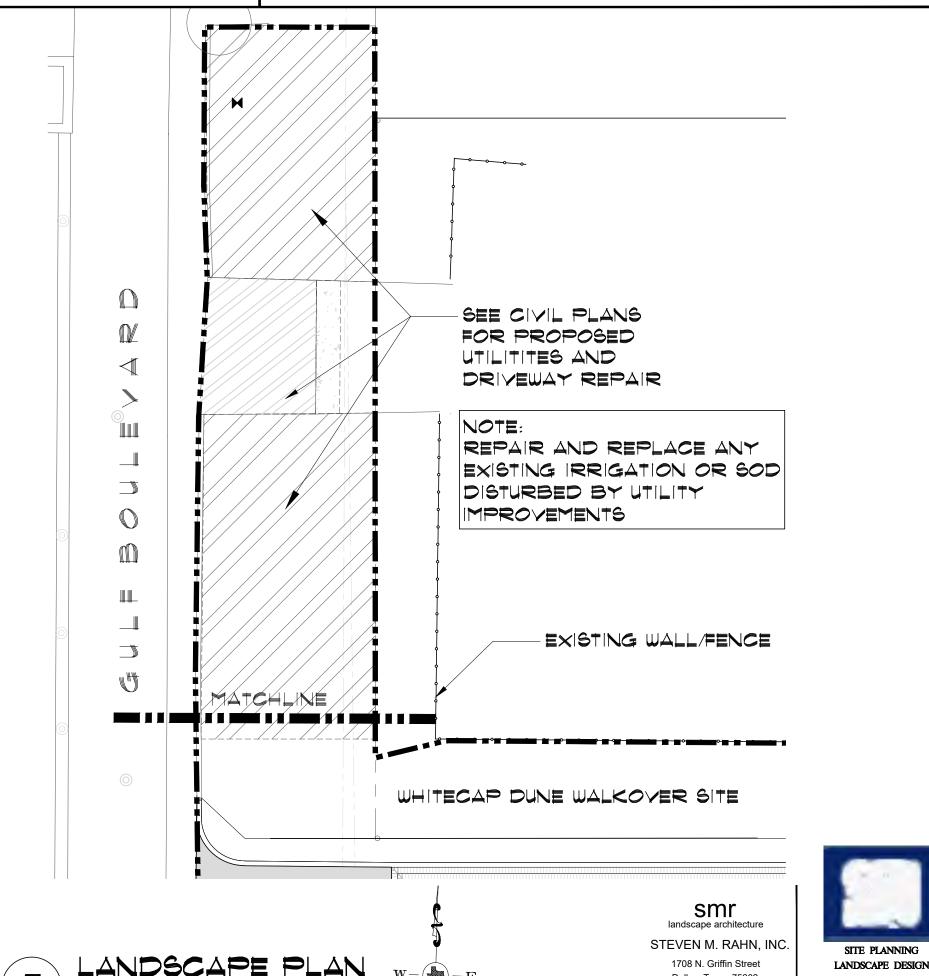





Dallas, Texas 75202 789 E. WASHINGTON ST. Tel 214.871.0083 BROWNSVILLE, TX 78575 Fax 214.871.0545 TEL (956) 547-9788

Email smr@smr-la.com


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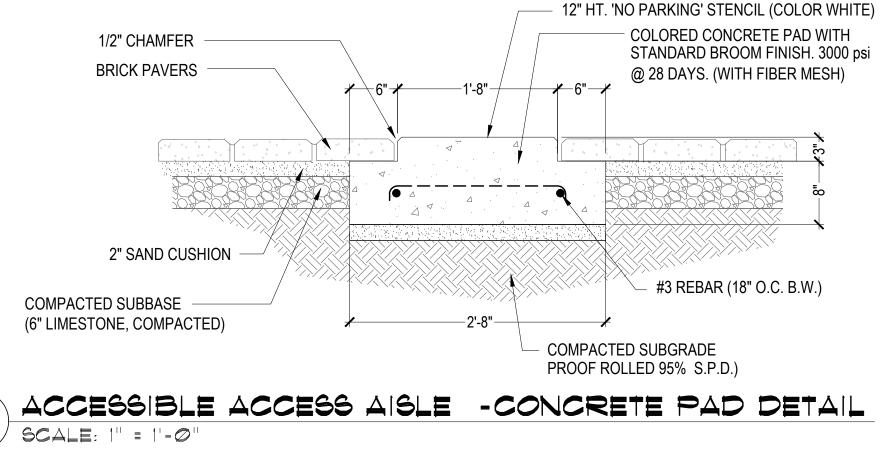
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CONCRETE WHEEL STOP - SECTION 'SIDE'




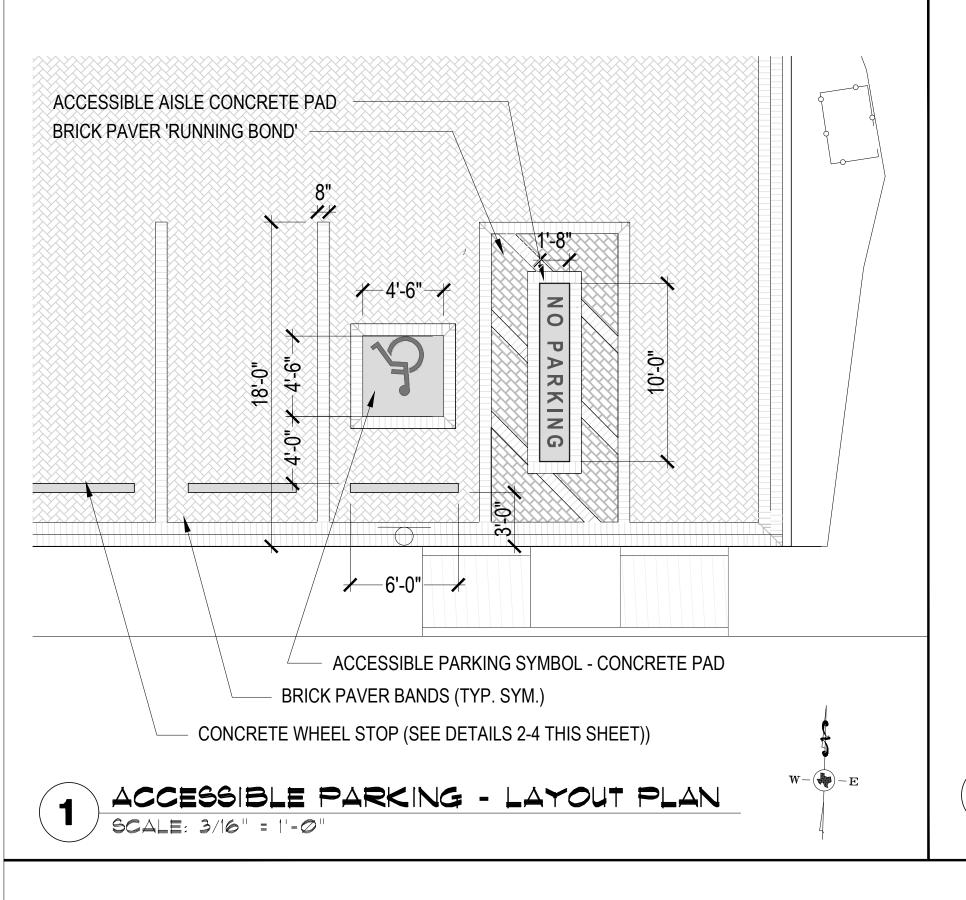

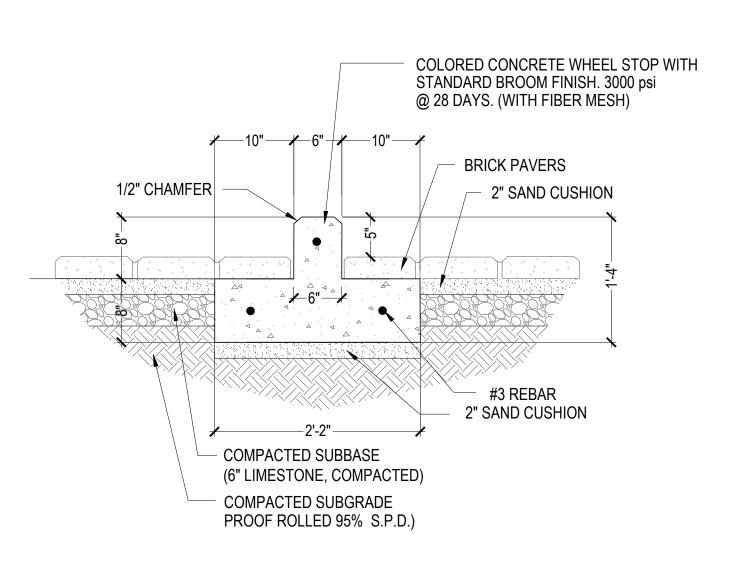WALKOVER AT WHITECAP CIRCLE SOUTH PADRE ISLAND, **TEXAS**

ACCESSIBLE PARKING SYMBOL -CONCRETE PAD DETAIL 6

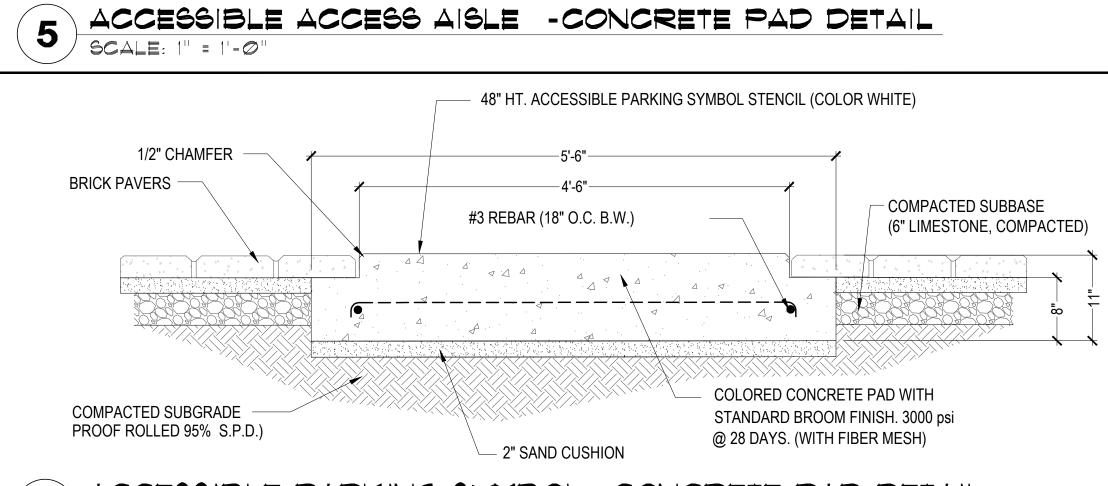COLORED CONCRETE WHEEL STOP WITH STANDARD BROOM FINISH. 3000 psi @ 28 DAYS. (WITH FIBER MESH) **BRICK PAVERS** 1/2" CHAMFER - 2" SAND CUSHION $\triangle \triangle$ #3 REBAR - COMPACTED SUBBASE 2" SAND CUSHION (6" LIMESTONE, COMPACTED) COMPACTED SUBGRADE PROOF ROLLED 95% S.P.D.) CONCRETE CURB STOP - SECTION 'FRONT'

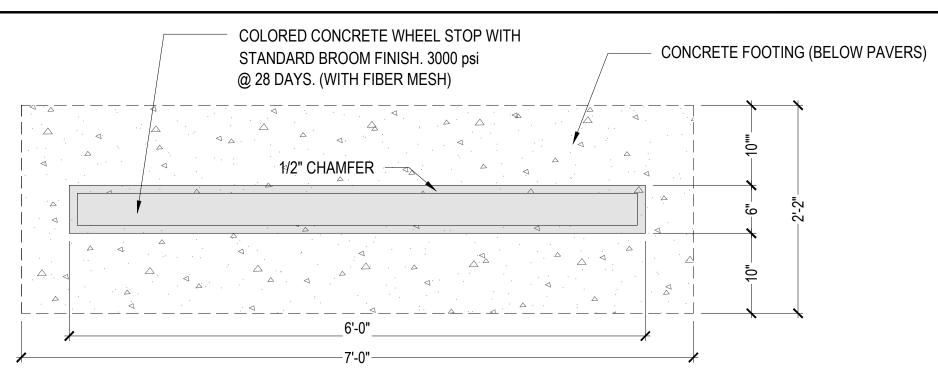


CONCRETE CURB STOP - PLAN

PAYING MATERIAL SCHEDULE

DESCRIPTION	NOTES	QUANTITY
BRICK PAVERS *	4x8" 80 MM KEYSTONE 'HOLLANDSTONE' BRICK PAVERS (LIGHT BROWN/TAN MIX) *	7200 S.F.
BRICK PAVER BAND*	4x8" 80 MM KEYSTONE 'HOLLANDSTONE' BRICK PAVERS BAND (DARK BROWN) *	975 S.F.
CONCRETE WHEEL STOPS	8" x 6' Colored Concrete wheel Stops (Butterfield 'Grey' # 9507 - (1 Bag Per 2 Yards) as Per Plans/Details	20
CONCRETE PADS	COLORED CONCRETE PADS (BUTTERFIELD 'GREY' # 8GØT (1 BAG PER 2 YARDS) FOR ACCESSIBLE Symbol and no parking space) see plans and details for dimensions, each with painted 'Stencil' (Color white) as per plans/details	50 S.F.

NOTE CONTRACTOR TO PROVIDE AVAILABLE PAVER COLORS FOR APPROVAL BY CITY BEFORE ORDERING MATERIAL

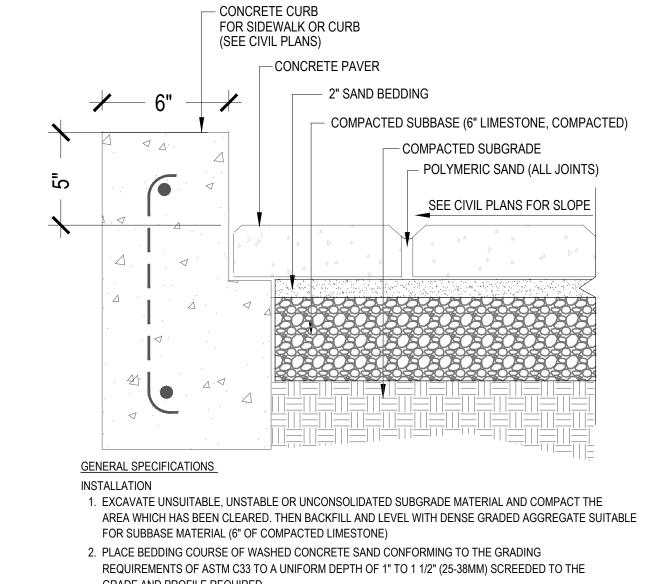

GRADE AND PROFILE REQUIRED. 3. INSTALL PAVERS WITH JOINTS APPROXIMATELY 1/8" (3MM). (PAVERS WITH SPACER RIBS

AUTOMATICALLY PROVIDE MINIMUM JOINT WIDTH.) 4. WHERE REQUIRED, CUT PAVERS WITH AN APPROVED CUTTER TO FIT ACCURATELY, NEATLY AND WITHOUT DAMAGED EDGES.

5. TAMP PAVERS WITH A PLATE COMPACTOR, UNFORMILY LEVEL, TRUE TO GRADE AND FREE OF MOVEMENT.

6. FILL JOINTS WITH POLYMERIC SAND BINDER (SANDLOCK OR APPROVED EQUAL.)

1. INSTALLATION TO BE COMPLETED IN ACCORDANCE WITH MANUFACTURER'S SPECIFICATIONS. 2. DO NOT SCALE DRAWINGS.

3. CONFIRM COLOR AND SIZE WITH OWNER PRIOR TO INSTALLATION 4. CONTRACTOR TO PROVIDE 6'x6' MOCKUP OF PAVING TO INCLUDE FIELD PATTERN, BORDER PATTERN

PAYING INSTALLATION DETAIL NOT TO SCALE

SEWER CLEAN OUT (SEE CIVIL PLANS) MITER PAVERS AT **CLEAN OUT AS SHOWN** 4" X 8" BRICK PAVER 45 ° HERRINGBONE NOTES: 1. DIMENSIONS SHOWN ARE FOR A 90° CORNER. ADJUST DIMENSIONS ACCORDINGLY FOR OTHER ANGLED CORNERS. 2. ALL MITER CUTS TO BE EVEN AND CONSISTENT. BRICK B BRICK D BRICK C

PAYING NOTES

1.CONTRACTOR SHALL REVIEW AND COORDINATE WITH EXISTING CONDITIONS. LOCATE AND PROTECT ALL UNDERGROUND UTILITIES, DRAINS, ELECTRICAL, ETC.

2.CONTRACTOR TO FOLLOW CIVIL ENGINEER'S GRADING/DRAINAGE PLANS. ENSURE PROPER DRAINAGE AWAY FROM ALL BUILDINGS TO DRAIN INLETS PER GRADING/DRAINAGE PLANS.

3.CONTRACTOR SHALL STAKE OUT ALL PAVING AREAS FOR SSP APPROVAL PRIOR TO STARTING ANY PAVING

4. CONTRACTOR SHALL STRIP/REMOVE EXISTING UNSUITABLE SOIL/SOD/GRASS IN AL PAVER AREAS. 5.CONTRACTOR SHALL SUPPLY/INSTALL SELECT FILL, SUB-BASE, MOISTURE CONDITION, AND COMPACT SUB GRADE TO 95% PROCTOR DENSITY.

6.CONTRACTOR SHALL SUPPLY/APPLY PRE-EMERGENT HERBICIDE TO SUB-BASE OF ALL PAVER AREAS. USE 'RONSTAR' PRE-EMERGENT HERBICIDE OR APPROVED EQUAL.

7.CONTRACTOR SHALL SUPPLY/INSTALL PAVERS AS INDICATED IN SCHEDULE

8.CONTRACTOR SHALL CUT/MITRE ALL RADII AND CORNERS USING MASONRY SAW AS DETAILED. 9.CONTRACTOR SHALL FILL/SWEEP AL JOINTS WITH MIXTURE OF JOINT SAND AND 'SANDLOCK' JOINT

NOT TO SCALE

STABILIZER. MI. 3-4 LBS. OF 'SANDLOCK' PER 100 LBS OF JOINT SAND. SWEEP ADDITIONAL 'SANDLOCK' ONTO FINAL SURFACE AND INTO AL JOINTS THEN SATURATE WITH WATER TO ACTIVATE STABILIZER.

10. CONTRACTOR SHALL NOTIFY SSP BEFORE INSTALLATION FOR INSPECTIONS/APPROVALS OF AL WORK. 11.CONTRACTOR SHALL WARRANTY ALL MATERIALS AND LABOR FOR A PERIOD OF TWO YEARS. WARRANTY INCLUDED RE-SANDING IF REQUIRED, HERBICIDE TREATMENT AND REPAIR OF ALL SUBGRADE FAILURES IF REQUIRED.

landscape architecture 1708 N. Griffin Street Dallas, Texas 75202 Tel 214.871.0083 Fax 214.871.0545



LANDSCAPE DESIGN 789 E. WASHINGTON ST. BROWNSVILLE, TX 78575 TEL (956) 547-9788 FAX (956) 547-9977 www.sspdesign.com

smr STEVEN M. RAHN, INC.



SHEET NO.

HARDSCAPE SCHEDULES AND

PROJECT NO.

DRAWN BY

CHECKED BY

SHEET TITLE

SCALE

DATE

DETAILS

GREEN, RUBIANO & ASSOCIATES

CONSULTING STRUCTURAL ENGINEERS 1220 WEST HARRISON

HARLINGEN, TEXAS 78550

PH: (956)428-4461 FAX: (956)428-0287

FIRM REGISTRATION #F-4145

SEAL

PROJECT

CLIENT

CITY OF

SOUTH PADRE ISLAND

SOUTH PADRE ISLAND,

TEXAS

DATE

P: 956-761-3044 F: 956-761-3898

DESCRIPTION


1065-16

PLM

SSP

AS SHOWN

04-22-2022

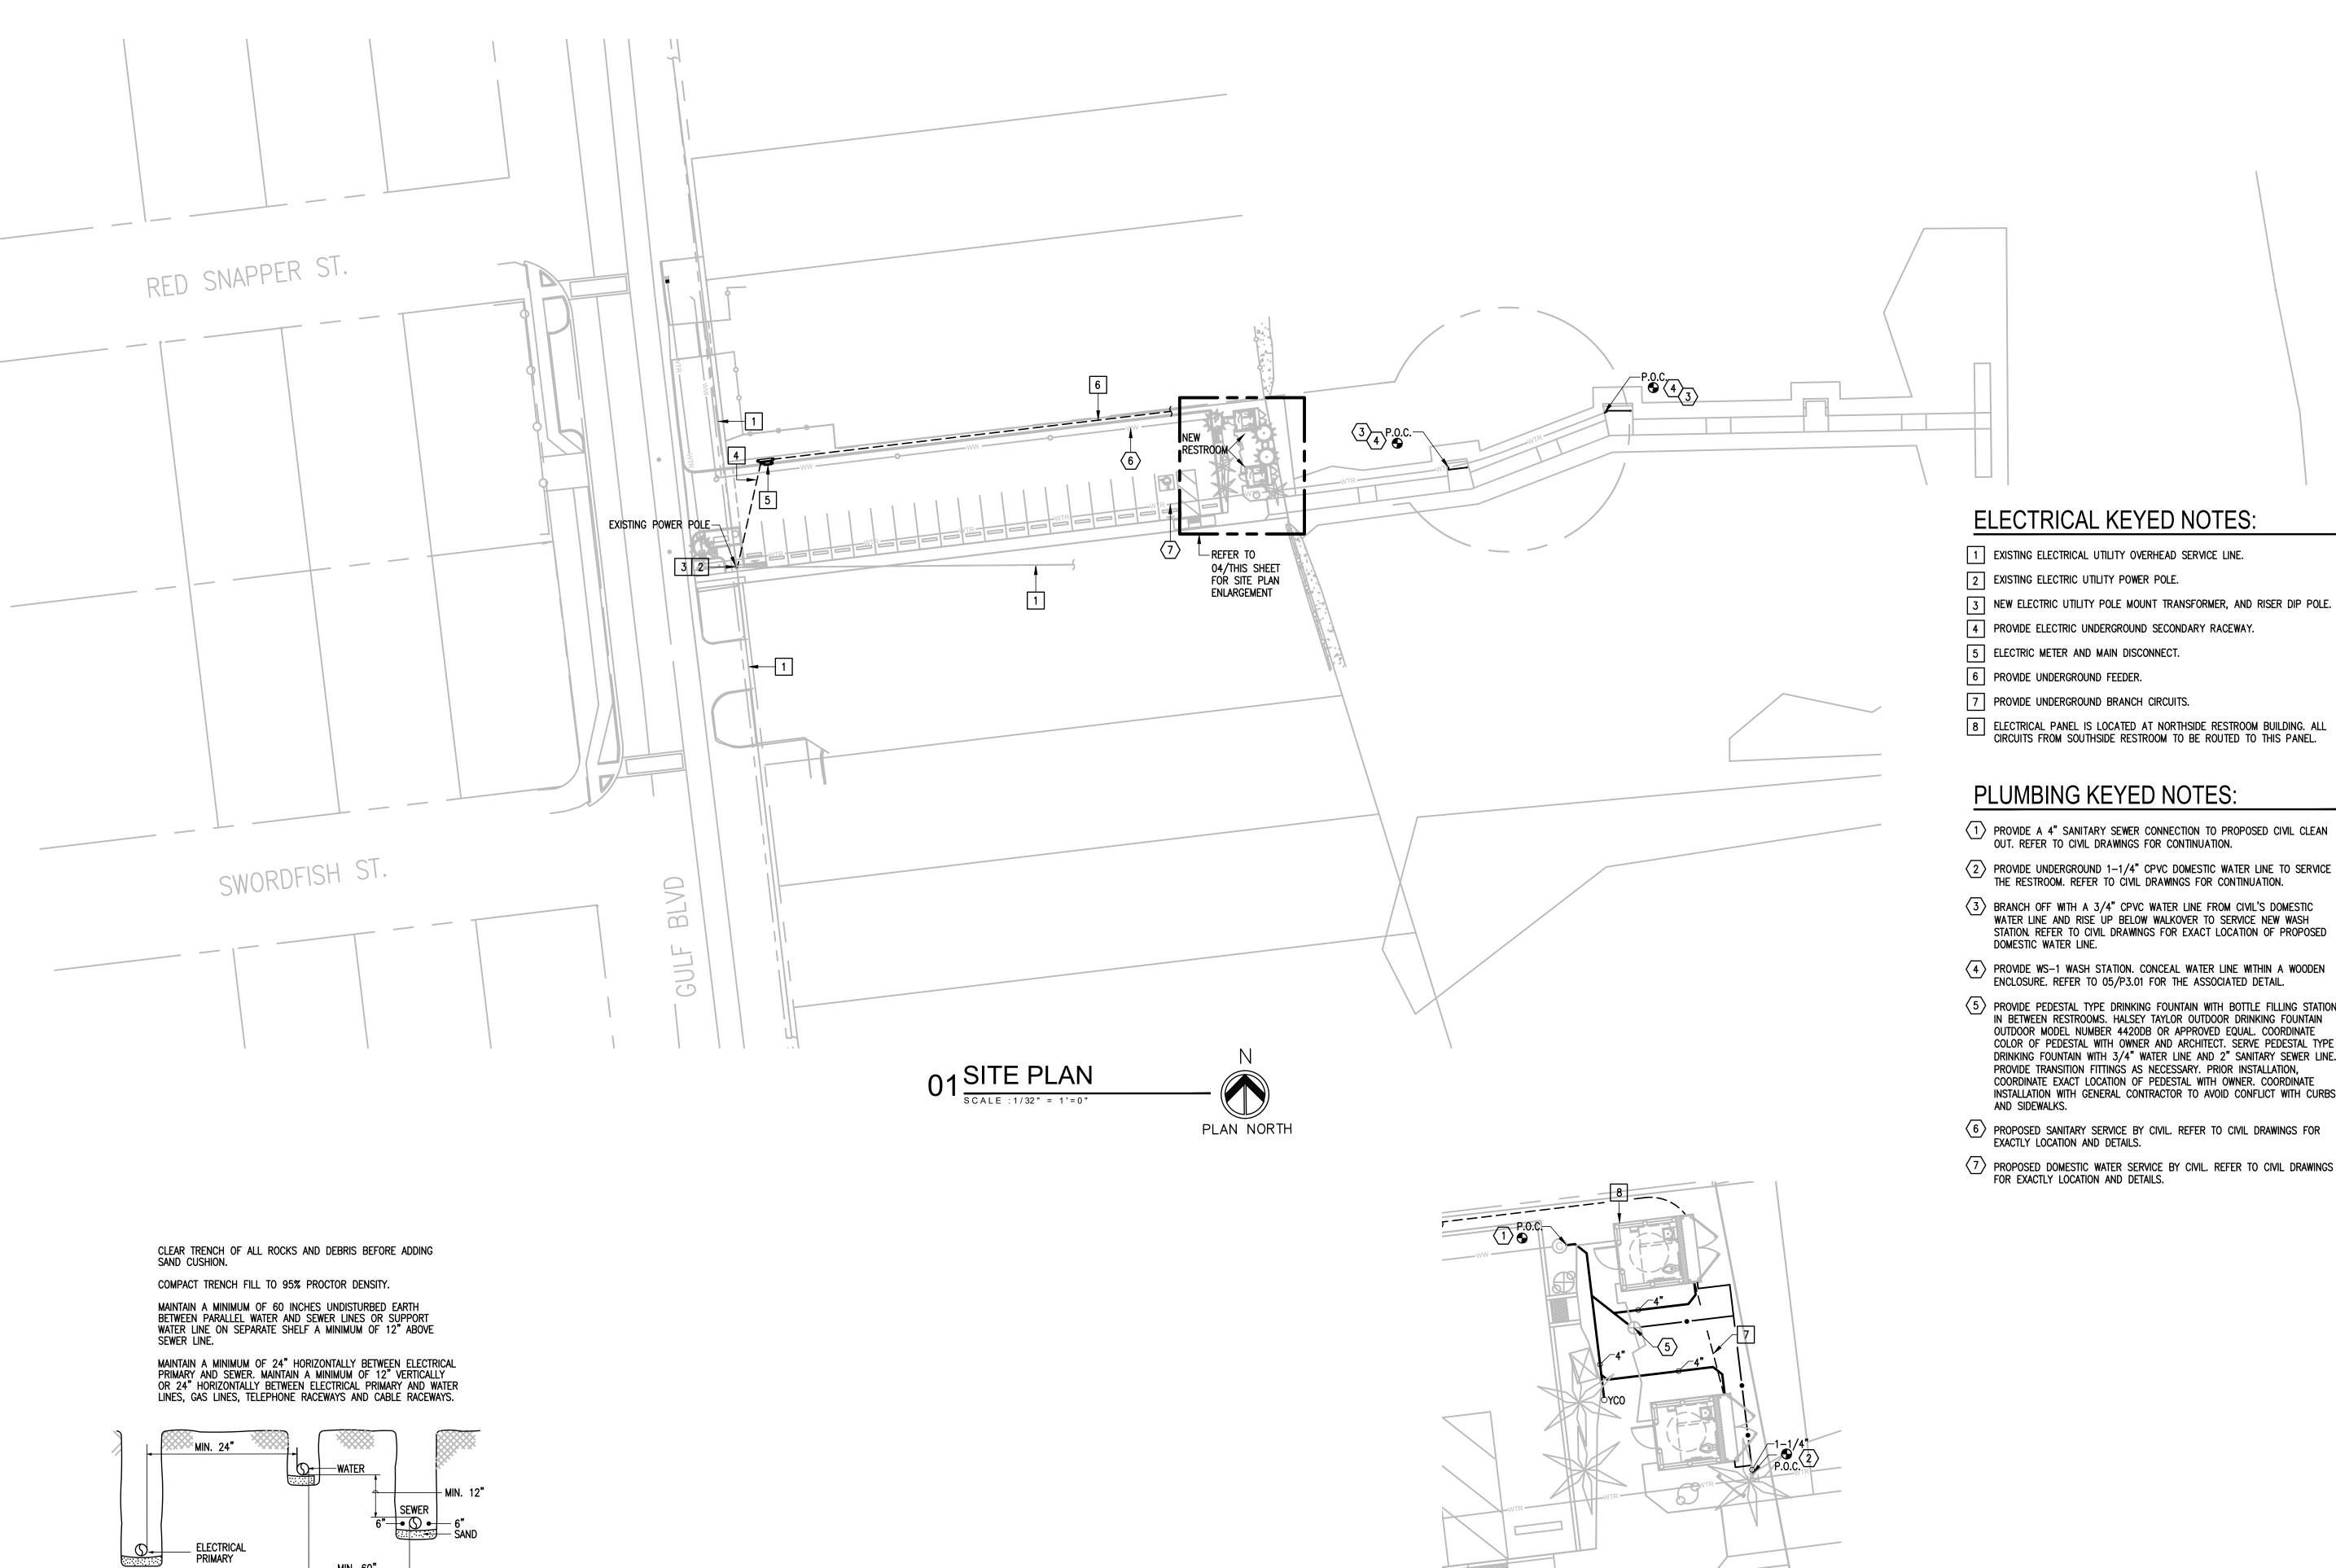

TRENCHING DETAIL



GREEN, RUBIANO & ASSOCIATES

CONSULTING STRUCTURAL ENGINEERS 1220 WEST HARRISON HARLINGEN, TEXAS 78550 PH: (956)428-4461 GRA@GRAENGINEERING.COM

SEAL



PROJECT

WALKOVER AT WHITE CAP CIRCLE

SOUTH PADRE ISLAND, TEXAS

CLIENT

- PROVIDE A 4" SANITARY SEWER CONNECTION TO PROPOSED CIVIL CLEAN OUT. REFER TO CIVIL DRAWINGS FOR CONTINUATION. PROVIDE UNDERGROUND 1-1/4" CPVC DOMESTIC WATER LINE TO SERVICE THE RESTROOM. REFER TO CIVIL DRAWINGS FOR CONTINUATION.
- BRANCH OFF WITH A 3/4" CPVC WATER LINE FROM CIVIL'S DOMESTIC WATER LINE AND RISE UP BELOW WALKOVER TO SERVICE NEW WASH STATION. REFER TO CIVIL DRAWINGS FOR EXACT LOCATION OF PROPOSED DOMESTIC WATER LINE.
- PROVIDE WS-1 WASH STATION. CONCEAL WATER LINE WITHIN A WOODEN ENCLOSURE. REFER TO 05/P3.01 FOR THE ASSOCIATED DETAIL.
- PROVIDE PEDESTAL TYPE DRINKING FOUNTAIN WITH BOTTLE FILLING STATION IN BETWEEN RESTROOMS. HALSEY TAYLOR OUTDOOR DRINKING FOUNTAIN OUTDOOR MODEL NUMBER 4420DB OR APPROVED EQUAL. COORDINATE COLOR OF PEDESTAL WITH OWNER AND ARCHITECT. SERVE PEDESTAL TYPE DRINKING FOUNTAIN WITH 3/4" WATER LINE AND 2" SANITARY SEWER LINE. PROVIDE TRANSITION FITTINGS AS NECESSARY. PRIOR INSTALLATION, COORDINATE EXACT LOCATION OF PEDESTAL WITH OWNER. COORDINATE INSTALLATION WITH GENERAL CONTRACTOR TO AVOID CONFLICT WITH CURBS
- PROPOSED SANITARY SERVICE BY CIVIL. REFER TO CIVIL DRAWINGS FOR EXACTLY LOCATION AND DETAILS.

02 SITE PLAN ENLARGEMENT

PLAN NORTH

PROPOSED DOMESTIC WATER SERVICE BY CIVIL. REFER TO CIVIL DRAWINGS FOR EXACTLY LOCATION AND DETAILS.

CITY OF SOUTH PADRE ISLAND



SOUTH PADRE ISLAND, TEXAS

P: 956-761-3044 F: 956-761-3898





PROJECT NO.	1065–16
DATE	04-22-2022
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CHECKED BY	ETHOS
SCALE	AS SHOWN

SHEET TITLE

EP SITE PLAN

SHEET NO.

EP1.01



SCOPE OF WORK:

- 1. GENERAL: THE "WALKOVER AT WHITE CAP CIRCLE" CONSISTS OF TWO NEW SINGLE STORY BUILDINGS, APPROXIMATE SQUARE FOOTAGE 89FT2 EACH. THESE BUILDING WILL GENERALLY BE OPERATED FROM 8:00AM TO 6:00PM. (7 DAYS A WEEK).
 2. ELECTRICAL: PROVIDE ALL MATERIALS AND LABOR ASSOCIATED WITH COMPLETE OPERATIONAL ELECTRICAL DISTRIBUTION SYSTEM. MAJOR ITEMS OF WORK INCLUDE, BUT ARE NOT LIMITED TO:
- (a) ELECTRICAL SERVICE:
- (i) PROVIDE A NEW UNDERGROUND ELECTRICAL SERVICE; IT SHALL CONSIST OF POLE MOUNTED UTILITY FURNISHED TRANSFORMER AND UNDERGROUND ELECTRICAL RACEWAYS. (ii)UTILITY COMPANY SHALL PROVIDE MEDIUM VOLTAGE CONDUCTORS AND POLE MOUNTED TRANSFORMER.
- (b) LIGHTING SYSTEMS: SHALL CONSIST OF LED TYPE WITH TIME CLOCK CONTROLS.
- (c)POWER SYSTEMS: PROVIDE MISCELLANEOUS DUPLEX RECEPTACLES AND POWER FOR HAND DRYERS.

ABBREVIATIONS:

Α	AMPS	GALV.	GALVANIZED
ABC	ABOVE CEILING LINE	GRND.	GROUND
AC	ABOVE COUNTER BACKSPLASH	HP	HORSEPOWER
AFF	ABOVE FINISHED FLOOR	HVAC	HEATING, VENTILATION,
B.	ВОТТОМ		& AIR CONDITIONING
BLC.	BELOW CEILING LINE	MECH	MECHANICAL
C.	CONDUIT OR COMMON	NTS	NOT TO SCALE
CLG.	CEILING	PH	PHASE
COND.	CONDUIT	RM.	ROOM
CU.	COPPER	SS	STAINLESS STEEL
DISC.	DISCONNECT	UG	UNDERGROUND
EF	EXHAUST FAN	UNO	UNLESS OTHERWISE NOTED
EXT.	EXTERNAL OR EXTERIOR	٧	VOLTS
G.	GROUND	w	WIRE
GA.	GAGE		

WIRING DEVICES SYMBOL LEGEND:

SYMBOL	DESCRIPTION	MNTG. HT. UNO (SEE NOTE 1)
GFCI WICP	DUPLEX RECEPTACLE W/ GROUND FAULT INTERRUPTING TYPE — HUBBELL MODEL #GFRST20X AND WHILE IN USE WEATHERPROOF COVER — HUBBELL MODEL #RW58300	18"AFF

NOTES:

- 1.) U.N.O. INDICATES UNLESS NOTED OTHERWISE. 18" AFF INDICATES TO TOP OF DEVICE;
- ALL OTHER MOUNTING HEIGHTS REFER TO CENTERLINE OF DEVICE.
- AC INDICATES 4" ABOVE COUNTER TO BOTTOM OF DEVICE. ALL RECEPTACLES SHALL BE INSTALLED HORIZONTALLY.


GENERAL SYMBOL LEGEND:

SYMBOL	DESCRIPTION	MNTG. HT. UNO (SEE NOTE 1)
Ю	JUNCTION BOX W/ BLANK COVERPLATE	AS REQUIRED
<u> </u>	ELECTRICAL PANELBOARD — SURFACE MOUNTED	AS REQUIRED
	UNDERGROUND RACEWAY	AS REQUIRED
	CONCEALED RACEWAY	AS REQUIRED
Here	CONDUIT OR EMT HOMERUN TO PANELBOARD CONCEALED IN WALLS OR ABOVE CEILING. LONG CROSSMARKS DENOTE NUMBER OF "HOT" CONDUCTORS SHORT CROSSMARKS INDICATE NEUTRALS AND DOTS INDICATE NUMBER OF GROUND CONDUCTORS. ARROW INDICATES HOME RUN TO ELECTRICAL PANEL.	AS REQUIRED

LIGHTING SYMBOL LEGEND:


SYMBOL	DESCRIPTION	MNTG. HT. UNO (SEE NOTE 1)
0	SURFACE/WRAPAROUND EMERGENCY LIGHT FIXTURE CONNECT BATTERY PACK TO BE ON AT ALL TIMES (UNSWITCHED)	
TC	OUTDOOR TIME CLOCK — 365 DAY, ASTRONOMICAL, 2—CHANNEL, PROGRAMMABLE, CAPABLE OF HAVING MULTIPLE SCHEDULES.	AS REQUIRED

1.) REFERENCE LIGHT FIXTURE SCHEDULE FOR ALL MOUNTING HEIGHTS.

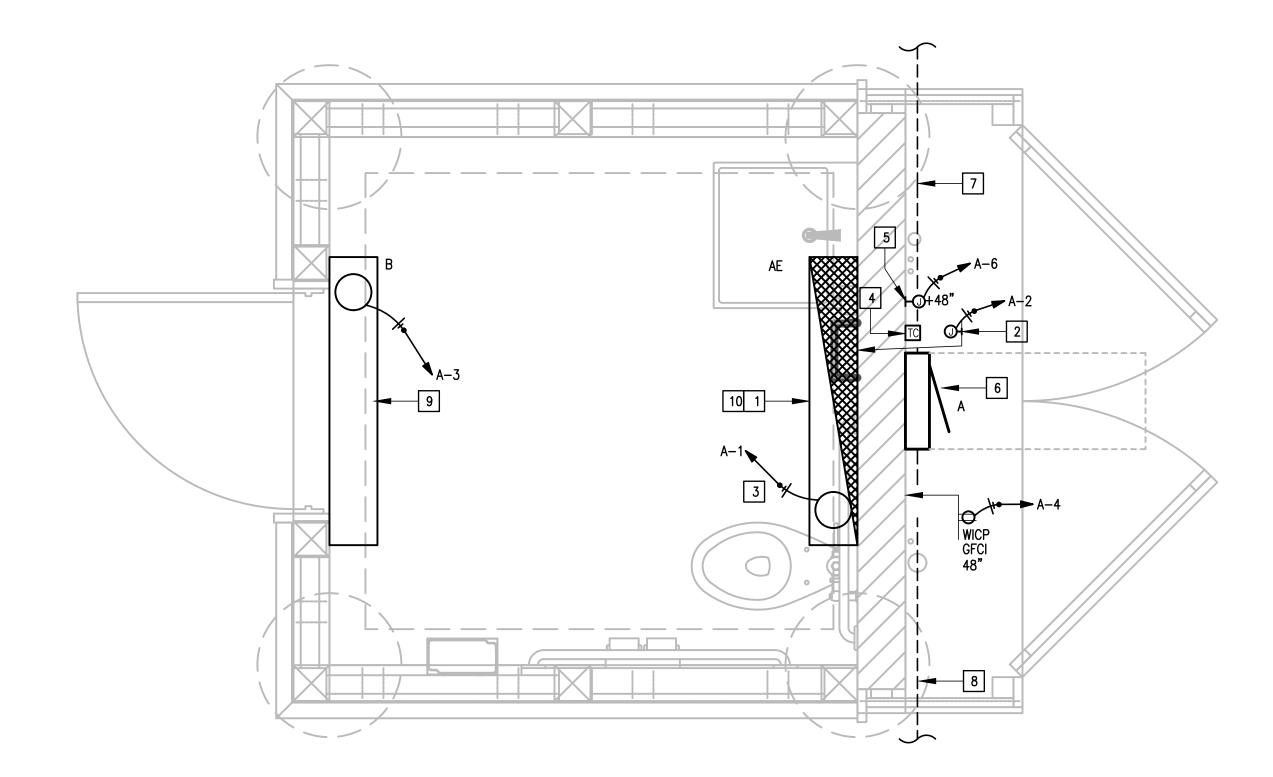

NORTHSIDE RESTROOM 01 LIGHTING AND ELECTRICAL PLAN

NORTH

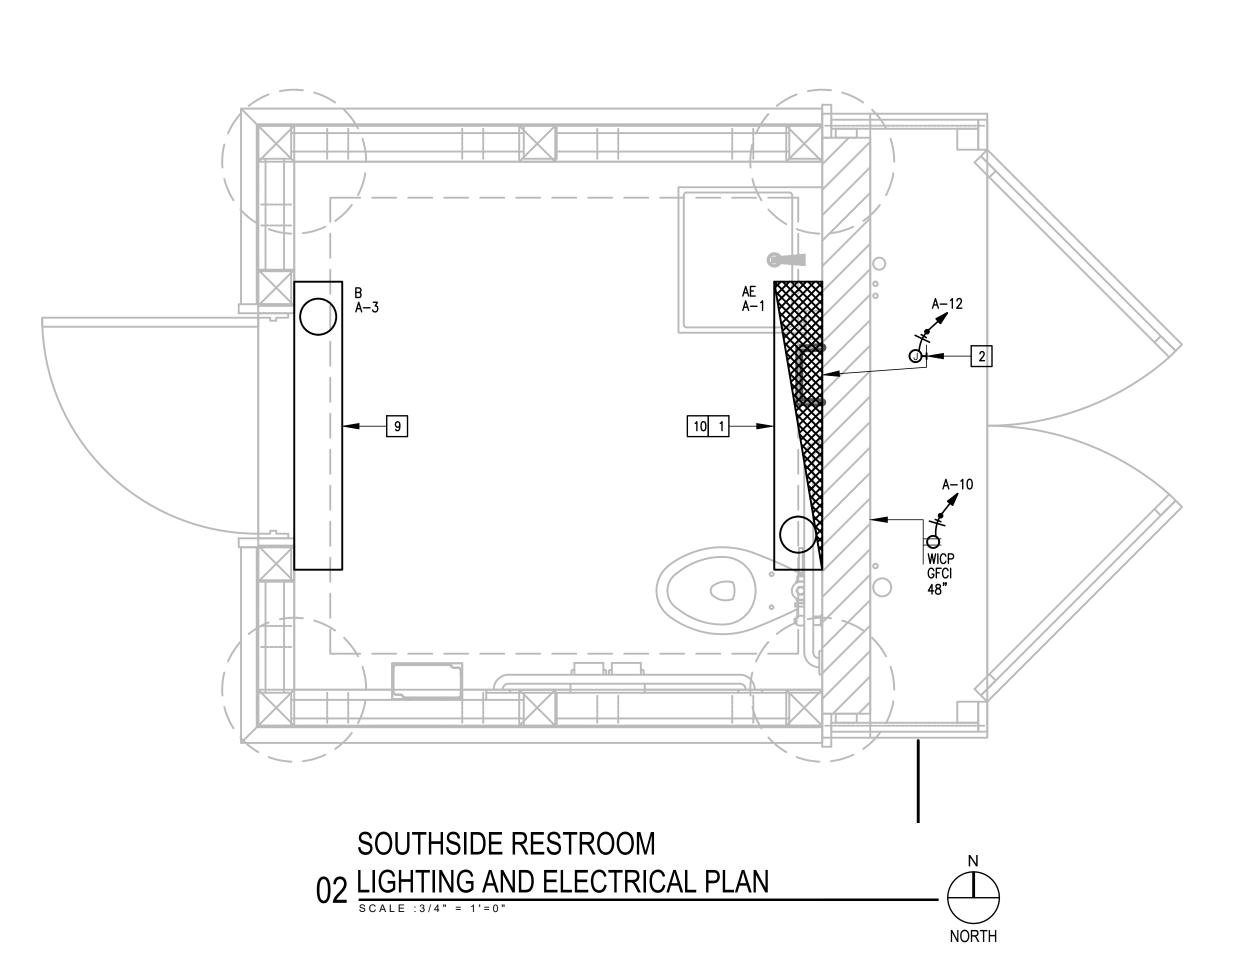

GENERAL NOTES:

- 1. ALL ELECTRICAL MATERIALS (OUTDOORS), INCLUDING BUT NOT LIMITED TO LIGHT FIXTURES, PANELBOARDS, SAFETY SWITCHES, HARDWARE (316 SS), SUPPORTING APPURTENANCES, ETC. SHALL BE SUITABLE FOR MARINE/COASTAL TYPE INSTALLATIONS.
- a. UNISTRUT PVC COATED b. HARDWARE – STAINLESS STEEL 316.
- c. ELECTRICAL GEAR ENCLOSURE REINFORCED FIBERGLASS. d. RACEWAYS ABOVE GROUND - PVC SCHEDULE 80, SUNLIGHT RESISTANT.
- e. RACEWAYS BELOW GROUND PVC SCHEDULE 40.
- 2. LIGHTING BRANCH CIRCUIT HOMERUNS SHALL BE 3/4" 2#12 & #12G. 20A/120V HOMERUNS EXCEEDING 100FT THE WIRE SIZE SHALL BE #10 & #8 FOR 175'.
- 3. INTERIOR LIGHTING CONTROLS SHALL BE BY TIME CLOCK.
- 4. EACH 20A/1P BRANCH CIRCUIT SHALL HAVE A DEDICATED NEUTRAL.
- 5. PROVIDE 0-10V SIGNAL WIRING TO EACH DIMMED LIGHT FIXTURE DRIVER AND WALL
- 6. THE INTENT IS FOR ALL LIGHTING RACEWAYS TO BE CONCEALED WITHIN WALLS AS MUCH AS POSSIBLE. WHERE RACEWAYS ARE TO BE INSTALLED SURFACE MOUNTED TO CEILINGS THEY SHALL FOLLOW THE PATCH INDICATED ON THE ARCHITECTURAL DRAWINGS. PRIOR TO ROUGH-IN OF ANY LIGHTING RACEWAY A SHOP DRAWINGS INDICATING ALL ROUTES SHALL BE SUBMITTED FOR APPROVAL.

ELECTRICAL KEYED NOTES:

- 1 CONNECT EMERGENCY BATTERY PACK TO BE CHARGING AT ALL TIMES (UNSWITCHED). LIGHT FIXTURE SHALL BE OPERATED BY TIME CLOCK. MOUNT AS HIGH AS POSSIBLE - TYPICAL.
- PROVIDE INFRARED RECESSED MOUNTED HAND DRYER SEE SPECIFICATIONS. BRANCH CIRCUIT: 1/2" 2#12 & #12G. MOUNT @ +40" A.F.F. (BOTTOM). VERIFY THE EXACT LOCATION WITH THE ARCHITECTURAL PLANS.
- 3 SWITCH VIA TIME CLOCK. THE INTENT IS FOR LIGHT FIXTURE TO BE "ON" FROM SUNRISE TO SUNSET TYPICAL.
- 4 PROVIDE TIME CLOCK SEE SPECIFICATION.
- 5 CONNECT IRRIGATION CONTROLLER.
- 6 SEE KEYED NOTE #8 ON SHEET MEP1.01.
- 7 UNDERGROUND FEEDER.
- 8 UNDERGROUND BRANCH CIRCUITS TO SOUTH RESTROOM.
- 9 LIGHT FIXTURE SHALL BE OPERATED BY TIME CLOCK (SUNSET TO SUNRISE) - MOUNT FIXTURE AS HIGH AS POSSIBLE -
- 10 CONTROLLED BY TIME CLOCK (SUNRISE TO SUNSET).



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SEAL



PROJECT

WALKOVER AT WHITE CAP CIRCLE

SOUTH PADRE ISLAND, TEXAS

CLIENT

CITY OF SOUTH PADRE ISLAND



SOUTH PADRE ISLAND, TEXAS

> P: 956-761-3044 F: 956-761-3898



MARK	DATE	DESCRIPTION

PROJECT NO.	1065–16
DATE	04-22-202
DRAWN BY	RE
CHECKED BY	CG
SCALE	AS SHOWN


SHEET TITLE

RESTROOM LIGHTING AND ELECTRICAL PLAN

SHEET NO.

E2.01



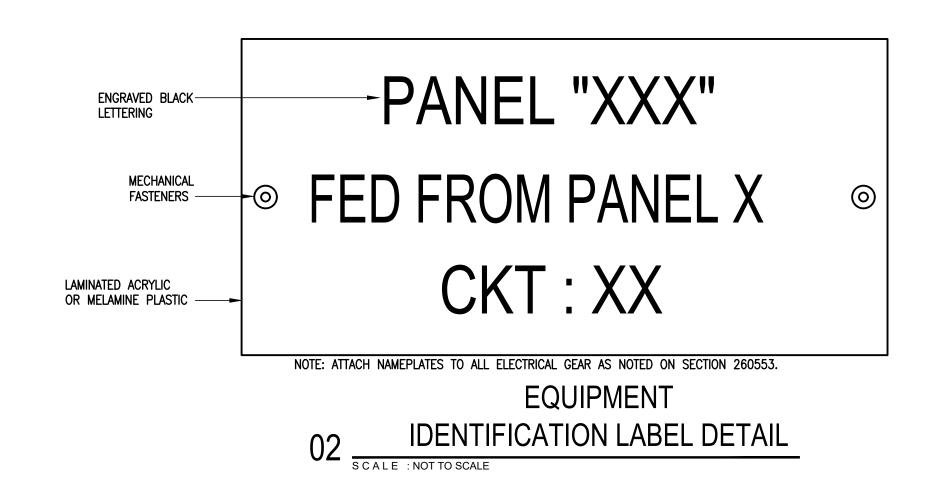




DYSON AIRBLADE V HAND DRYER



LIGHT FIXTURE TYPE "AE, B" S C A L E : NOT TO SCALE

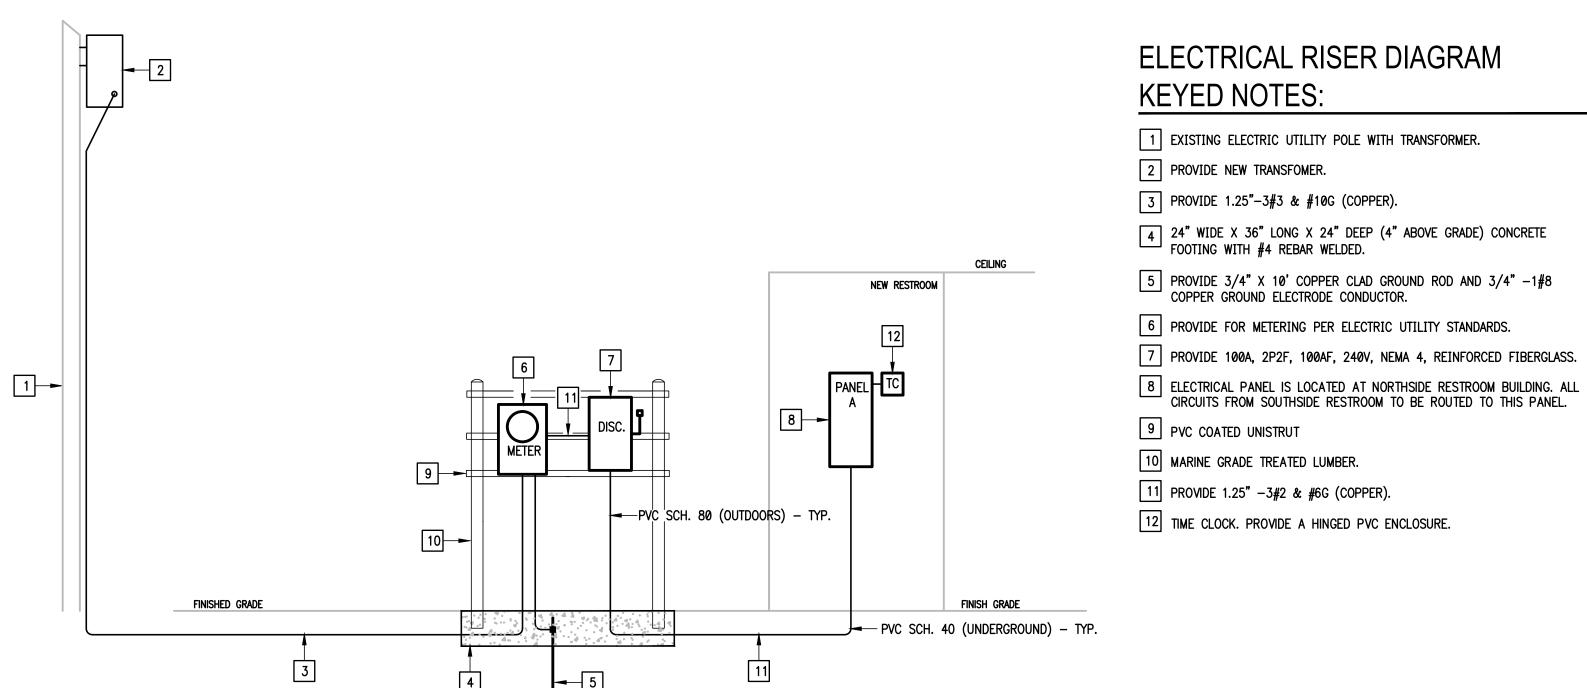

RESTROOM BUILDING

01 ELECTRICAL RISER DIAGRAM

LUMINAIRE SCHEDULE CALLOUT LAMP DRIVER MOUNTING VOLTS INPUT WATTS LUMENS DESCRIPTION 4' VANDAL RESISTANT WRAPAROUND LUMINAIRE LED: VPF4 4FT 25W 4000K 120-277 CLP X EMB310 PROVIDE UL LISTED FOR 0-10V SURFACE 120V 1P 2W DAMP LOCATIONS AND WITH AN EMERGENCY BATTERY 4' VANDAL RESISTANT WRAPAROUND (AMBER DRIVER SURFACE LUMINAIRE LED: VPF4 4FT NODIM 40W AMB 120-277 CLP X 120V 1P 2W PROVIDE UL LISTED FOR DAMP LOCATIONS.


GENERAL NOTES:

1.OTHER LIGHT FIXTURE MANUFACTURERS THAN THOSE LISTED ON THIS SCHEDULE ARE REQUIRED TO OBTAIN PRIOR APPROVAL BY SUBMITTING CUT SHEETS OF THEIR SUBSTITUTIONS AT LEAST (10) DAYS PRIOR TO BID. CUT SHEETS SHALL INDICATE/HIGHLIGHT PHOTOMETRIC CURVE, EFFICIENCY & CONSTRUCTION FOR DIRECT COMPARISON WITH SPECIFIED FIXTURES.

2.EXTRA MATERIALS: SEE SPECIFICATIONS. 3.EMERGENCY BATTERY PACKS SHALL BE COMPLETE FACTORY INSTALLED WITH NI-CAD BATTERY, CHARGER INDICATING LIGHT, ELECTRONIC CIRCUITRY, 1400 LUMENS OUTPUT, 90 MINUTES DURATION & FIVE FULL YEARS WARRANTY.

	NTING SI FROM U		BU NE	DLTS 240/12 US AMPS 100 EUTRAL 100%) %		A NUMBE	AIC 10,000 MAIN BKR N LUGS STAND				
CKT	CKT	DE A TIPE WRITTEN AS	BUILT DIKE	<u> </u>) KVA	CKT	CKT				LOAD	KVA
#	BKR	CIRCUIT DESCRIPTION		A	В	`#`	BKR	CIRCUIT DESCRIPTION	١		A	В
1 3	20/1 20/1	(NORTH AND SOUTH RR) L	IGHTING	0.05	0.08	2 4	20/1 20/1	(NORTHSIDE RR) HAND DI (NORTHSIDE RR) RECEPT.			1.5	1.5
5 7	20/2 I	SPARE		0.9	0.9	6 8	20/1 20/1	IRR. CONTROLLÉR SPARE			0.18	0
9	20/2 	SPARE		0.9	0.9	10 12	20/1 20/1	(SOUTHSIDE RR) RECEPT. (SOUTHSIDE RR) HAND DI			1.5	1.5
		1					<u> </u>	TOTAL CONNECTE	D KVA BY F	PHASE	5.03	4.88
		CONN KVA	CALC KVA					CONN KVA	CALC KVA			
LIGHT	ING	0.13	0.163	— (125 %)		RECEP'	TACLES NTINUOUS	6.18 3.6	6.18 3.6	 (50%) (100%	•	
						TOTAL BALANO	LOAD CED LOAD		9.94 41.4 A	_ `		

PROVIDE NEMA 4 (REINFORCED FIBERGLASS) ENCLOSURE.

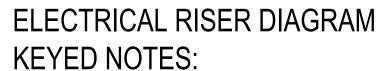

1 EXISTING ELECTRIC UTILITY POLE WITH TRANSFORMER.

2 PROVIDE NEW TRANSFOMER.

3 PROVIDE 1.25"-3#3 & #10G (COPPER).

4 24" WIDE X 36" LONG X 24" DEEP (4" ABOVE GRADE) CONCRETE FOOTING WITH #4 REBAR WELDED.

5 PROVIDE 3/4" X 10' COPPER CLAD GROUND ROD AND 3/4" -1#8 COPPER GROUND ELECTRODE CONDUCTOR.

6 PROVIDE FOR METERING PER ELECTRIC UTILITY STANDARDS.

7 PROVIDE 100A, 2P2F, 100AF, 240V, NEMA 4, REINFORCED FIBERGLASS.

9 PVC COATED UNISTRUT

10 MARINE GRADE TREATED LUMBER.

11 PROVIDE 1.25" -3#2 & #6G (COPPER).

12 TIME CLOCK. PROVIDE A HINGED PVC ENCLOSURE.

GREEN, RUBIANO & ASSOCIATES

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SEAL



PROJECT

WALKOVER AT WHITE CAP CIRCLE

SOUTH PADRE ISLAND, TEXAS

CLIENT

CITY OF SOUTH PADRE ISLAND



TEXAS P: 956-761-3044

F: 956-761-3898





MARK	DATE	DESCRIPTION

PROJECT NO.	1065–16
DATE	04-22-2022
DRAWN BY	RE
CHECKED BY	CG
SCALE	AS SHOWN

SHEET TITLE


ELECTRICAL SCHEDULES

SHEET NO.

1126 SOUTH COMMERCE ST. HARLINGEN, TX PHONE: 956-230-3435 TEXAS REGISTERED ENGINEERING FIRM

- HANGERS SHALL BE STAINLESS STEEL. REFER TO SPECIFICATIONS FOR
- MORE DETAILS.

 2. BALL VALVES AND DOMESTIC WATER PIPING SHALL BE SCH. 40 CPVC. REFER TO SPECIFICATIONS FOR MORE DETAILS.
- PLUMBING KEYED NOTES:
- 1 REFER TO MEP SITE PLAN FOR CONTINUATION.
- 2 SLEEVE ALL GRADE BEAMS, FLOOR SLABS AND MASONRY WALL PENETRATIONS PER DETAIL WHETHER SPECIFICALLY INDICATED ON PLANS OR NOT.
- MOUNT CPVC DOMESTIC WATER PIPING AND PVC VENT PIPING TO THE MASONRY WALL.
 - PROVIDE WATER HAMMER ARRESTOR (WHA), MIFAB OR APPROVED EQUAL. INDICATED MODEL (A,B,C,D,E,F) AS PER MIFAB SIZING CHART. PROVIDE 12"X12" ACCESS PANEL WHERE INSTALLED IN AN INACCESSIBLE AREA. ACCESS PANEL EQUAL TO ACUDOR MODEL UF5000 WITH CYLINDER LOCK AND KEY AND PAINT TO MATCH THE WALL/CEILING. (TYPICAL)
- 5 INSTALL WATER CLOSET FLUSH VALVE HANDLE TOWARDS WIDE SIDE OF THE ROOM. COORDINATE WITH GENERAL CONTRACTOR. (TYPICAL)
- 6 PROVIDE CPVC BALL VALVE IN LINE OF WATER ENTRANCE. SEE ASSOCIATED DETAIL ON DETAIL SHEET.
- PROVIDE 1" CLOSED-CELL INSULATION WITH METAL JACKET ON EXPOSED PIPING. PENETRATE EXTERIOR WALL AS LOW AS POSSIBLE. TURN DOWN TO UNDERGROUND.
- 8 PROVIDE WALL HYDRANT AS SCHEDULED. PROVIDE CLOSE COUPLED HYDRANT TO ENSURE PIPE TURNS UP INSIDE BLOCK WALL. COORDINATE WALL THICKNESS WITH WALL HYDRANT MANUFACTURER DATA. (TYPICAL)
- 9 PAINT ALL EXPOSED PIPING TO MATCH ARCHITECTURAL FINISHES. COORDINATE COLOR WITH ARCHITECT.
- 10 PROVIDE 2" VENT TO 2" VENT THRU ROOF.
- 11 INSTALL CLEANOUT WITH PLUG FACING UP.
- 12 CAP HOT WATER LAVATORY FAUCET LINE. HOT WATER WILL NOT BE SUPPLIED.
- START ELEVATION OF WATER CLOSET AT 34" TO CLEAR 6" BELOW STRUCTURAL GRADE BEAM. REFER TO GRADE BEAM DETAIL ON DETAILS SHEET.

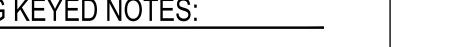



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SEAL



PROJECT

WALKOVER AT WHITE CAP CIRCLE

SOUTH PADRE ISLAND, TEXAS

CLIENT


CITY OF SOUTH PADRE ISLAND



SOUTH PADRE ISLAND, TEXAS

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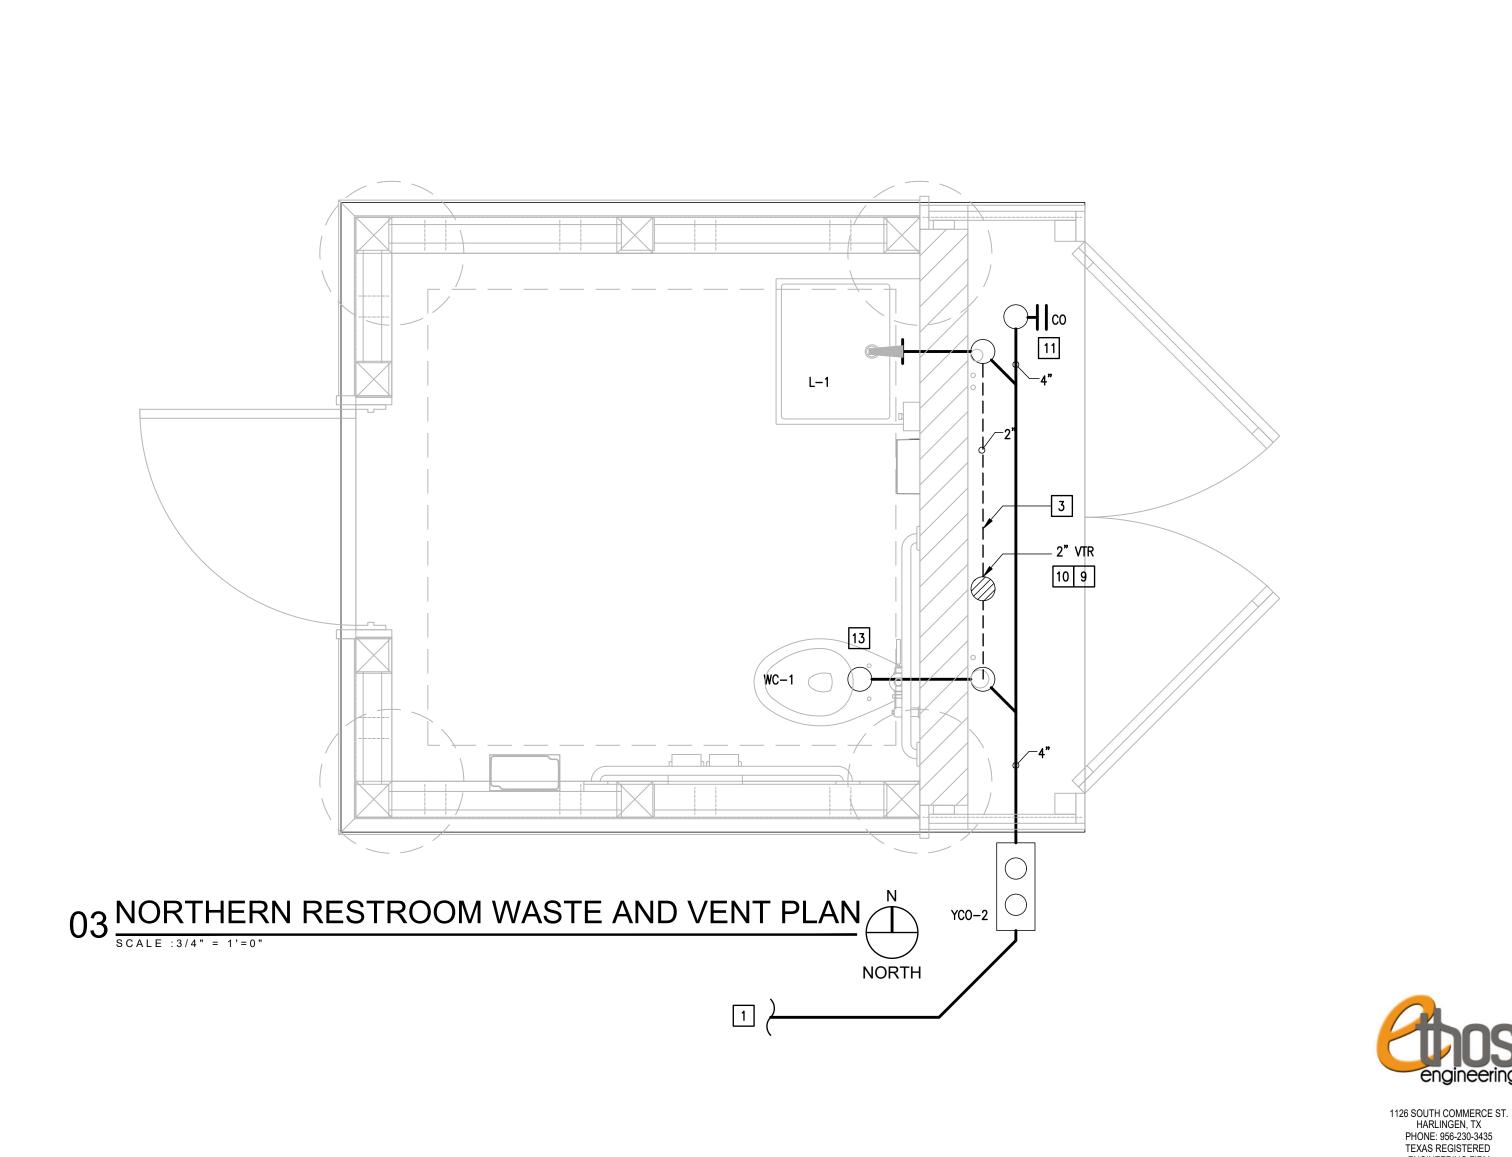
PROJECT NO.	1065–16
DATE	04-22-2022
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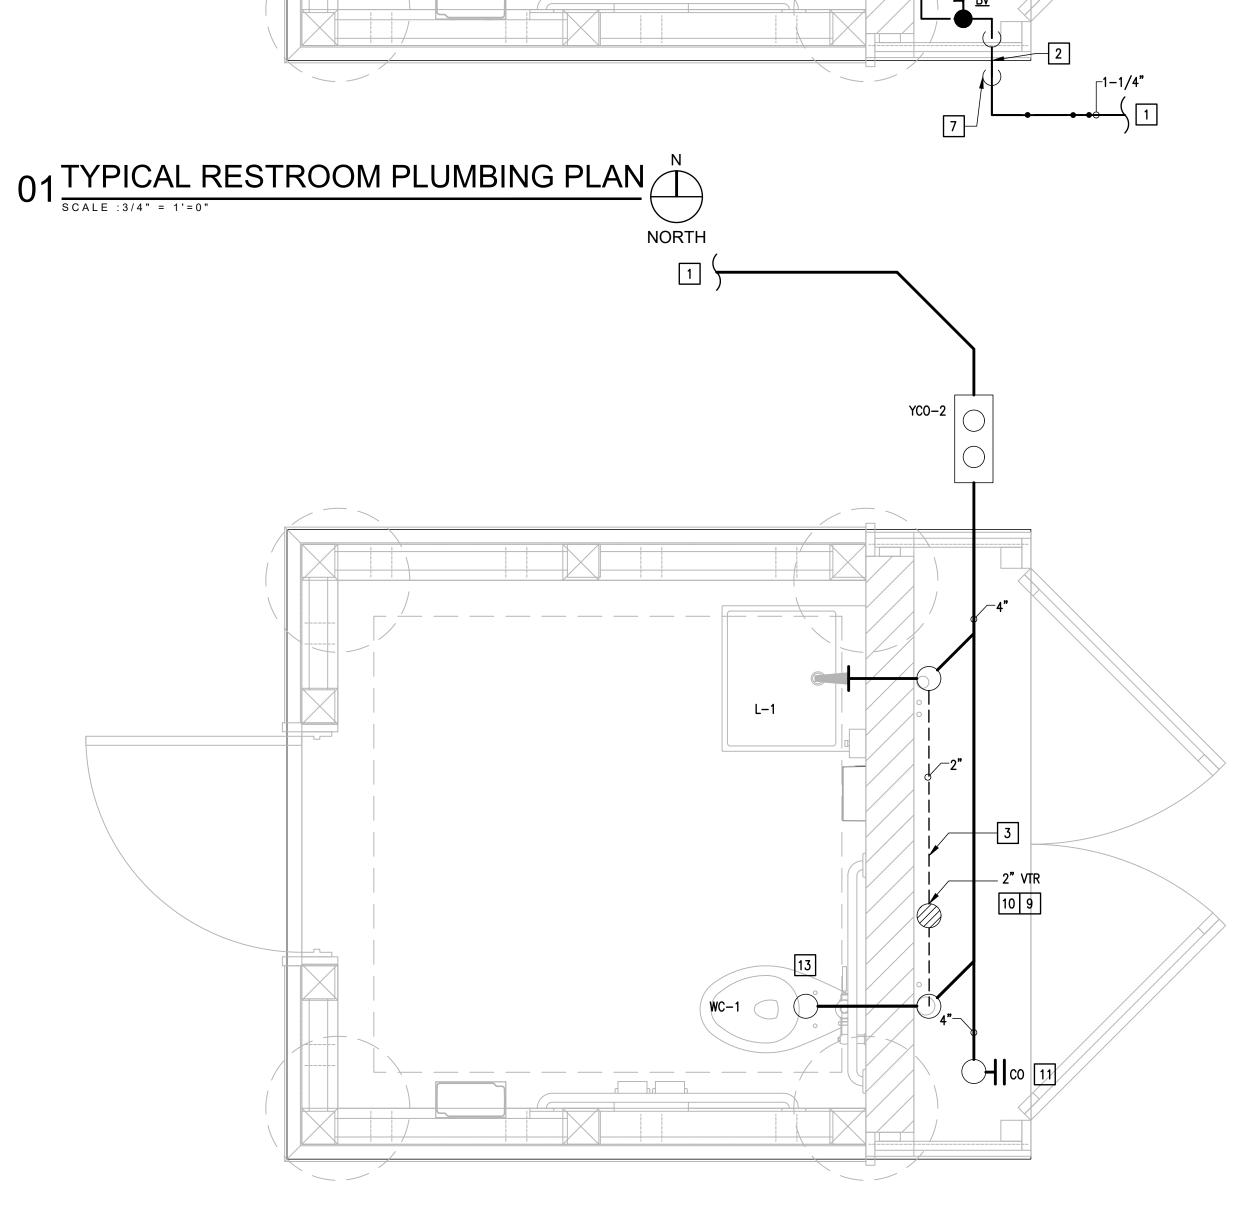
RESTROOM
PLUMBING,
WASTE, AND
VENT PLAN

SHEET NO.

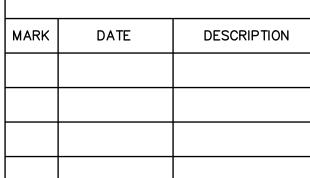ENGINEERING FIRM

P2.01





02 SOUTHERN RESTROOM WASTE AND VENT PLAN NORTH

Project: V	Valkover at White Cap Circle							
MARK	MANUFACTURER & MODEL NUMBER	DESCRIPTION		CO	DEMARKO			
WC-1	AMERICAN STANDARD 3461.001 5901.100 SEAT (1" THICK) SLOAN ROYAL #111-1.28	16-1/2" FLOOR MOUNTED, ELONGATED BOWL, HIGH EFFICIENCY, LOW CONSUMPTION FLUSH VALVE, WHITE VITREOUS CHINA WATER CLOSET WITH SIPHON JET ACTION BOWL, 1.28 GPF TOP FLUSH VALVE, WHITE OPEN FRONT TOILET SEAT LESS COVER AND BOLT CAPS. ADULT ADA MOUNTING	WASTE 4"	VENT	1"	HW -	NOTES	REMARKS 18" TO TOP OF SEAT
L-1	KOHLER K2314-1 CHICAGO FAUCET #410-T41E2805ABCP 0 5 GPM AERATOR MOUNTING BRACKET K-9583 17 GA. DRAIN AND 17 GA P-TRAP W/CLEAN OUT TRUEBRO KIT	24" X 24" WALL MOUNTED SQUARE SHALLOW BASIN, 4" SINGLE FAUCET HOLES LAVATORY, SINGLE LEVER,, CHROME PLATED SUPPLY STOPS WITH STAINLESS STEEL FLEXIBLE CONNECTORS, CHROME PLATED DRAIN GRID AND TAILPIECE. DECK MOUNTED, SINGLE LEVER FAUCET WITH SINLGE HOLE MOUNTING ON CENTER WITH THERMOSTATIC MIXING CARTRIDGE, SET AT NO MORE THAN 105 DEGREES FAHRENHEIT AND MOUNTING BRACKET	2"	2"	1/2"	1/2"	3	SEE ARCHITECTURAL
WS-1	ACORN 53 SHOWER HEAD ONLY ACORN -DIV DIVERTER VALVE AMERICAN GRANBY AIHBB50SS HOSE BIBB	OUTDOOR BUILT-IN SHOWER. MARINE GRADE TYPE 316 STAINLESS STEEL EXPOSED PARTS, STAINLESS STEEL DIVERTER VALVE, STAINLESS STEEL NON-USER ADJUSTABLE SHOWER HEAD, STAINLESS STEEL HOSE BIBB			3/4"			MOUNTED WITHIN CUSTOM CEDAR ENCLOSURE SEE ARCHITECTURAL
WH-1	ZURN # Z1300-SS-34UN	ENCASED ANTI-SIPHON AUTOMATIC DRAINING WALL HYDRANT FOR FLUSH INSTALLATION. COMPLETE WITH NON-FREEZE TYPE INTEGRAL BACKFLOW PREVENTER, BRONZE CASING, ALL BRONZE INTERIOR PARTS, NON-TURNING OPERATING ROD WITH FREE-FLOATING COMPRESSION CLOSURE VALVE, REPLACEABLE BRONZE SEAT AND SEAT WASHER, STAINLESS STEEL BOX AND HINGED COVER WITH OPERATING KEY LOCK AND "WATER" CAST ON COVER.	-	-	3/4"	-	-	

NOTES:

- 1. INSTALL FLUSH VALVE ON THE WIDE SIDE OF STALL.
- 2. PROVIDE ADA APPROVED FLUSH VALVE HANDLE FOR ALL ADA PLUMBING FIXTURES.
- 3 PROVIDE TRUEBRO LAVATORY GUARD MODEL #103 E-Z COLOR WHITE. COVER SHALL BE SECURED WITH SNAP-SLIP FLUSH REUSABLE FASTENERS.


PLUMBING S	SYMBOLS LEGEND		
•	- COLD WATER SUPPLY	wco ⊦ 	WALL CLEANOUT
• •	- HOT WATER SUPPLY	─ >>	*GATE VALVE (GV)
G G-	- GAS LINE	•	*BALL VALVE (BV)
	SOIL & WASTE LINE - ENLARGED PLANS	₹	VALVE IN RISER TYPE AS NOTE
	- VENT LINE - ENLARGED PLANS	WC	WATER CLOSET
AW	ACID WASTE LINE - ENLARGED PLANS	UR	URINAL
AV	ACID VENT LINE - ENLARGED PLANS	L	LAVATORY
F	FIRE SPRINKLER LINE	SK	SINK
FCO O	FLOOR CLEANOUT	EDF	ELECTRIC DRINKING FOUNTAIN
	FLOOR CLEANOUT - 2 WAY	MSB	MOP SERVICE BASIN
FD 🚳 C FD 📆	FLOOR DRAIN/SINK WITH DEEP SEAL TRAP	EESHR	EMERGENCY EYE/SHOWER
HD∝	HUB DRAIN WITH DEEP SEAL TRAP	TP	TRAP PRIMER
FS D	FLOOR SINK	EWH	ELECTRIC WATER HEATER
YCO 🕒	YARD CLEANOUT	VTR	VENT THRU ROOF
	YARD CLEANOUT - 2 WAY	CO	CLEANOUT
wh -	WALL HYDRANT	A.F.F.	ABOVE FINISH FLOOR
@	TRAP PRIMER	ADT	ACID DILUTION TANK
7	*WATER HAMMER ARRESTOR (WHA)	GT	GREASE TRAP
⊕ P.0.C.	POINT OF CONNECTION	S.S.	SANITARY SEWER
	WASHING MACHINE BOX		

* PROVIDE 12"x12" ACCESS PANEL WHERE INSTALLED IN AN INACCESSIBLE AREA.


GENERAL NOTES:

(APPLY TO ALL PLUMBING SHEETS)

- 1. ALL PLUMBING WORK SHALL BE IN COMPLIANCE WITH ALL APPLICABLE CODES AS ADAPTED AND AMENDED BY THE INSPECTING AUTHORITIES.
- 2. DRAWING IS DIAGRAMMATIC ONLY. CONTRACTOR SHALL COORDINATE EXACT LOCATIONS OF PIPING, DEVICES AND EQUIPMENT WITH BUILDING ELEMENTS AND THE WORK OF OTHER TRADES.
- 3. ALL PLUMBING WORK SHALL BE INSTALLED SO AS TO AVOID CONFLICT WITH THE WORK OF OTHER TRADES. COORDINATE WITH MECHANICAL, ELECTRICAL AND STRUCTURAL FOR PROPER CLEARANCES.
- 4. REFER TO ARCHITECTURAL DRAWINGS AND SPECIFICATIONS FOR PHASING AND SEQUENCE OF CONSTRUCTION WORK.
- 5. COORDINATE WORK AMONG ALL DISCIPLINES. IT IS NOT THE INTENT OF THESE DOCUMENTS TO DICTATE WHO MUST DO THE WORK. ALL WORK SHOWN IS THE RESPONSIBILITY OF THE PRIME CONTRACTOR.
- 6. SLEEVE ALL OUTSIDE WALLS, FOUNDATION GRADE BEAMS, INTERIOR WALL PENETRATIONS, AND FIRE SEAL ALL PENETRATION THROUGH FIRE WALLS AND FLOORS WHETHER SHOWN ON PLANS OR NOT.
- 7. PROVIDE MINIMUM 15' OF SEPARATION BETWEEN HVAC INTAKES AND VENT THRU ROOFS.
- 8. RECORD INVERT ELEVATIONS OF ALL YARD CLEAN OUT (YCO) ON "AS-BUILT" DRAWINGS.
- 9. PROVIDE SHUT-OFF VALVES (STOPS) ON ALL ROUGH-INS TO FIXTURES AND EQUIPMENTS.
- 10. PROVIDE WATER HAMMER ARRESTORS AS INDICATED ON THE DRAWINGS. AIR CHAMBERS NOT AN APPROVED SUBSTITUTE
- 11. PROVIDE ANY BACKFLOW PREVENTION DEVICE REQUIRED BY CODE OR LOCAL AUTHORITIES. CONTRACTOR SHALL VERIFY THIS WITH CITY AND LOCAL AGENCIES AND INCLUDE COST IN BID. CONTRACTOR TO HAVE BACK
- 12. REFER TO PLUMBING FIXTURE ROUGH-IN SCHEDULE FOR INDIVIDUAL PIPE CONNECTIONS TO FIXTURES.
- 13. PRIOR TO POURING FOUNDATION AND ERECTING WALLS, COORDINATE INSTALLATION OF PLUMBING FIXTURE CARRIERS WITH GENERAL CONTRACTOR.
- 14. STUDS AT DRY WALLS SHALL NOT BE CUT THRU HORIZONTAL DIRECTION. COORDINATE WITH DRY WALL CONTRACTOR.
- 15. CONTRACTOR SHALL NOT CUT ANY EXTERIOR WALL STUD.

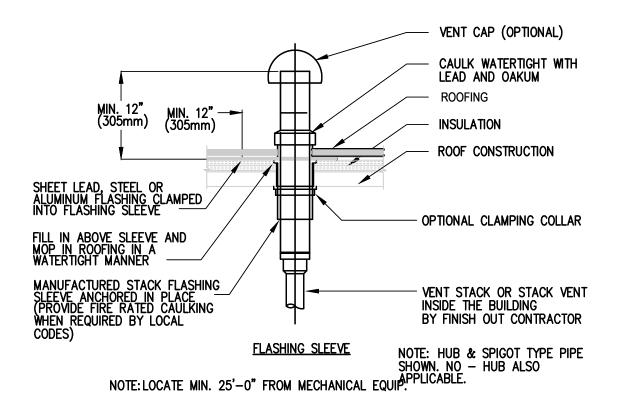



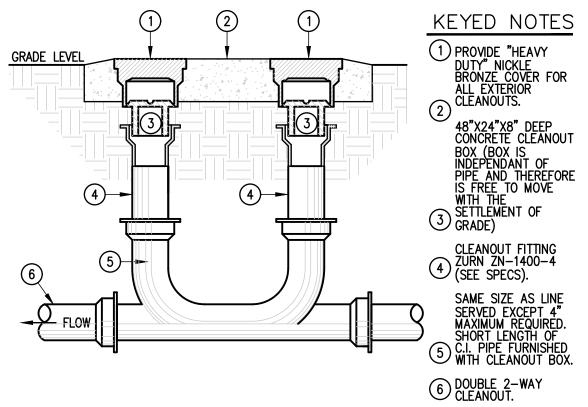


02 2-WAY YARD CLEANOUT DETAIL

SEWER LINE.

SEWER LINE.


GRADE LEVEL

CLEANOUT FITTING ZURN

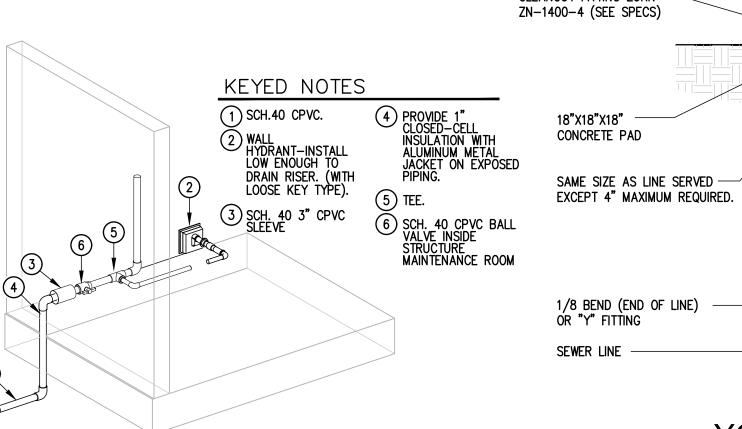

03 WATER ENTRANCE DETAIL

YCO-1
04 YARD CLEANOUT DETAIL

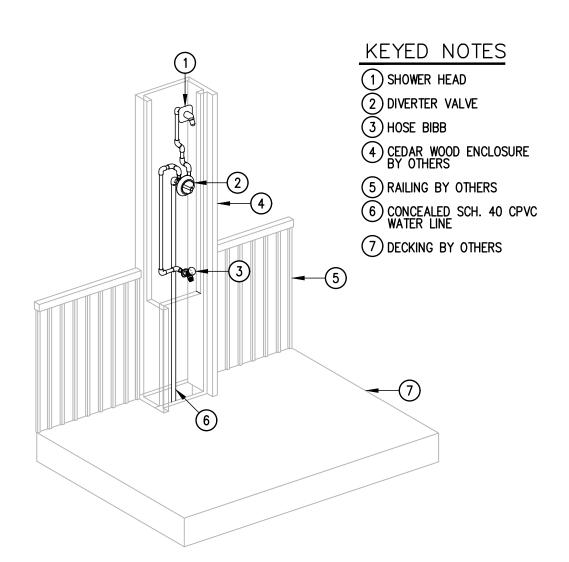

5 (WS-1)WASH STATION DETAIL



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SEAL



PROJECT

WALKOVER AT WHITE CAP CIRCLE

SOUTH PADRE ISLAND, TEXAS

CLIENT

CITY OF SOUTH PADRE ISLAND



SOUTH PADRE ISLAND, TEXAS

P: 956-761-3044 F: 956-761-3898



MARK	DATE	DESCRIPTION

PROJECT NO.	1065–16
DATE	04-22-2022
DRAWN BY	CAR
CHECKED BY	GV
SCALE	AS SHOWN

SHEET TITLE

PLUMBING SCHEDULE AND DETAILS

SHEET NO.

P3.01
















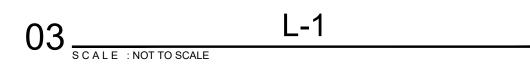









WS-1



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SHEET TITLE

PLUMBING FIXTURE IMAGES





P3.02