NOTICE OF REGULAR MEETING OF SOUTH PADRE ISLAND SHORELINE TASK FORCE

NOTE: One or more members of the City of South Padre Island City Council may attend this meeting; if so, this statement satisfies the requirements of the OPEN MEETINGS ACT.

NOTICE IS HEREBY GIVEN THAT THE SHORELINE TASK FORCE OF THE CITY OF SOUTH PADRE ISLAND, TEXAS, WILL HOLD A MEETING ON:

TUESDAY, APRIL 9, 2019
3:00 p.m. at the Municipal Building,
CITY COUNCIL CHAMBERS, 2ND FLOOR
4601 PADRE BOULEVARD, SOUTH PADRE ISLAND, TEXAS

- 1. Call to Order.
- 2. Pledge of Allegiance.
- 3. Public Comments and Announcements: This is an opportunity for citizens to speak to Task Force relating to agenda or non-agenda items. Speakers are required to address the Shoreline Task Force at the podium and give their name before addressing their concerns. [Note: State law will not permit the Shoreline Task Force to discuss, debate, or consider items that are not on the agenda. Citizen Comments may be referred to City Staff or may be placed on the agenda of a future Shoreline Task Force meeting.]
- 4. Approval of the minutes of the February 26, 2019 meeting.
- 5. Discussion and action to recommend to City Council the approval of a Beach and Dune Permit to construct a single-family residence with associated amenities located at 8414 Breakers Boulevard South Padre Island, Texas (Boburka).
- 6. Discussion and action to select and move forward with potential projects and improvements based upon the Shoreline Master Plan (Boburka).
- 7. Discussion and possible action on dog water fountains at the City's beach accesses (Boburka).
- 8. Discussion and possible action on improvements to ensure our beach and dune ecosystem is well protected (Wall).
- 9. Discussion on Mobi-Mat maintenance (Wall).
- 10. Adjournment.

DATED THIS THE 4TH DAY OF APRIL 2019.

Susan Hill, City Secretary

I, THE UNDERSIGNED AUTHORITY, DO HEREBY CERTIFY THAT THE ABOVE NOTICE OF MEETING OF THE SHORELINE TASK FORCE OF THE CITY OF SOUTH PADRE ISLAND, TEXAS IS A TRUE AND CORRECT COPY OF SAID NOTICE AND THAT I POSTED A TRUE AND CORRECT COPY OF SAID NOTICE ON THE BULLETIN BOARD AT CITY HALL/MUNICIPAL BUILDING ON APRIL 4, 2019 AT/OR BEFORE 5:00 P.M. AND REMAINED SO POSTED CONTINUOUSLY FOR AT LEAST 72 HOURS PRECEDING THE SCHEDULED TIME OF SAID MEETING.

Susan Hill, City Secretary

THIS FACILITY IS WHEELCHAIR ACCESSIBLE, AND ACCESSIBLE PARKING SPACES ARE AVAILABLE. REQUESTS FOR ACCOMMODATIONS OR INTERPRETIVE SERVICES MUST BE MADE 48 HOURS PRIOR TO THIS MEETING. PLEASE CONTACT BUILDING OFFICIAL, DAVID TRAVIS; ADA DESIGNATED RESPONSIBLE PARTY AT (956) 761-8103.

MINUTES OF REGULAR MEETING OF SOUTH PADRE ISLAND SHORELINE TASK FORCE

TUESDAY, FEBRUARY 26, 2019

1. Call to Order.

The Shoreline Task Force of the City of South Padre Island, Texas held a meeting on Tuesday, February 26, 2019, at the Municipal Complex Building, 2nd Floor, 4601 Padre Boulevard, South Padre Island, Texas. Chairman Neil Rasmussen called the meeting to order at 3:00 p.m. A quorum was present with the following Task Force Members in attendance: Chairman Neil Rasmussen, Vice-Chairman Virginia Guillot, Stormy Wall, Robert Nixon, Abbie Mahan, and Patrick McNulty.

Mayor Pro-Tem Ken Medders along with City Council member Eva Jean Dalton were present. City staff members present included Interim City Manager Randy Smith, Assistant City Manager Darla Jones, Shoreline Director Brandon Hill, and Coastal Resource Manager Kristina Boburka.

2. Pledge of Allegiance.

Chairman Neil Rasmussen led the Pledge of Allegiance.

3. Public Comments and Announcements.

There were none received.

4. Approval of the minutes of the January 28, 2019 meeting.

Task Force Member Guillot, seconded by Task Force Member Mahan, moved to approve the meeting minutes as submitted. Task Force Member Nixon abstained; motion carried unanimously.

5. Discussion and action to recommend to City Council the approval of a Beach and Dune Permit for 2100 Gulf Boulevard South Padre Island, Texas.

Task Force Member Rasmussen opened with discussing one of the Shoreline Task Force's goals to build a more resilient beach by eliminating or reducing the amount of cuts in the dune system.

Task Force Member McNulty motioned to approve the permit as it was submitted, and was seconded by Task Force Member Mahan. Task Force Member Rob noted that in addition to the motion stated, would like the property to make sure the vegetation in the area grows back so the dune can grow underneath the ramp and along the walkway.

The manager of 2100 Gulf Boulevard stated the proposed project is only to cover the stairs that are presently there to make their private access ADA compliant. In response, Task Force Member Wall stated their recommendation to connect with the public access that is there is only based on their recent decision to build a more resilient dune system.

With a 4:2 vote, the motion carried.

6. Discussion and action to select and move forward with potential projects and improvements based upon the Shoreline Master Plan.

Shoreline Director Brandon Hill explained that not all matrices were turned in and offered to give the Shoreline Task Force additional time to review and make their decisions. The motion was made to table the item until the next meeting and carried unanimously.

7. Discussion and possible action on the proposed 2019 Beach User Fee Plan.

Shoreline Director Brandon Hill stated that City staff decided to cancel the public meeting for February 28 to allow for more preparation time. He offered that instead of presenting continuously, as was recommended, to create a video that would be played with all relevant information in the EOC room. He also noted that Michael Gray, the City Marshal for the City of Galveston, is interested in attending as well to provide his knowledge on paid parking.

Task Force Member Nixon motioned to move forward with an amendment to the Beach Management Plan and to submit to the Texas General Land Office. This amendment would remove the paid parking aspect, but contain the correct number of parking spaces the City currently has in order to be in compliance with the GLO. At a future date, the Beach User Fee Plan will be revisited. This was seconded by Task Force Member Guillot; motion carried unanimously.

8. Adjournment.

There being no further business, Chairman I	Rasmussen adjourned the meeting at 3:33 p.m.
Kristina Boburka, Coastal Resource Manago	er Neil Rasmussen, Chairman

CITY OF SOUTH PADRE ISLAND CITY COUNCIL MEETING AGENDA REQUEST FORM

MEETING DATE: A ₁	pril 9, 2019	
NAME & TITLE: K	ristina Boburka, Interim Shorelii	ne Director
DEPARTMENT: Sh	noreline Department	
	nily residence with associated am	e approval of a Beach and Dune Permit nenities located at 8414 Breakers
	he construction of a single-family tigation plan of the damaged dur	y residence, which will not have an access ne area is in place.
BUDGET/FINANCIAL SU	MMARY	
None.		
dunes, wetlands, Lagur sustainable use and enjoy	esources ensure protection and conservation a Madre waterfront and native yment by future generations.	ion of natural resources, such as beaches, we flora and fauna, allowing for their both natural and artificial erosion.
LEGAL REVIEW		
Sent to Legal: Approved by Legal:	YES: YES:	NO:X NO:
Comments:		

Rev. #4 - 8/25/11

RECOMMENDATIONS/COMMENTS
Staff recommends the approval.



Beach & Dune Application

City of South Padre Island 4601 Padre Blvd. South Padre Island, TX 78597 Phone: (956) 761-3044 Fax: (956) 761-3898

	Site for Pro	oposed Work		
Legal Description:	Lot 4, Block 4, The Shores Subdivision, Phase One, Section Two	Physical Address;	8414 XXXXX Breake	rs Blvd
	Property Owner Information		Applicant / Agent for O	wner
Name:	Stan Richards	Name:	Daniel de la Cru	z
Mailing Address:	2801 North Central Expressway, Suite 100	Mailing Address	: 164 Barcelo	na Ave.
City:	Dallas State: Tx	City;	Brownsville	State: Tx
Zip: 7:	5204 Country: United States	Zip:	78526 Country:	United States
Phone Number:	(a14) 91a-2098	Phone Number:	(95¢) 533-1881	
Fax Number:		Fax Number:	<u>. </u>	
E-Mail Address:		E-Mail Address:		
Date: 2/8//9 Project Description Describe with as much as detail as possible, the construction proposed. If more room is needed, please include an additional page. Include the number of habitable units, amenities, swimming pools, fences, kinds of fences, whether foolings and/or retaining walls will be installed, and locations of proposed landscaping and parking.				
Single family home	with a foolprint of 2632 sq ft. Floor plans provided (Exhibit A).			
Total Square Foot	tage of Footprint of Habitable Structure:		2632	
Total Area of Impe	ervious Surface (i.e. retaining walls, walkways, drives, patios, etc.):		2632	
Percentage Imper	rvious Surface [(impervious surface / habitable footprint)* 100]:		100%	
Please Note: the p	percentage of impervious surface cannot exceed 5% in an erodin	g area.		
Approximate Dura	ation of Construction:	12	months	

Desc	cribe the methods which you will use to avoid, minimize, mitigate	and/or compensate for any adverse effects on dunes or dune vegetation.	
Explanation / Other Information;	Existing vegetation will be relocated as per mitigation in	plan provided (Exhibit C).	
inancial Plan for Pugo Mitigat	Non		Villanditera escribitera
inancial Plan for Dune Mitigat required by the City Council, a skes place as proposed and req	financial guarantee (irrevocable letter of credit or a perf	formance bond, etc.) may be necessary to insure the mitigation of dunes/dune ve	egelation

Checklist of Additional Required Application Information

	An accurate map	, plat o	r site plan	showing
--	-----------------	----------	-------------	---------

- X 1. Legal description of the property (list, block, subdivision) and the immediately adjoining property.
- 2. Location of all existing structures including the habitable and inhabitable structures, swimming pools, decks, fences, parking areas, landscape areas, etc.
- 3. Location of the Historical Building Line on the subject property and the extension of the line on the properties immediately adjoining the subject property to the north and to the south. Exhibit C
- 4. Location and elevation of existing retaining walls both on the subject property and those properties immediately adjoining the subject property to the north and to the south.
- 5. Location of proposed structure(s) if proposing the construction of a retaining wall, please also include the proposed elevation of the retaining wall.
- 6. Location of proposed driveways, parking areas (showing the # of proposed parking spaces) and landscape areas.
- 7. Location of all existing and proposed beach access paths and/or dune walkovers.
- X 8. Location and extent of any man-made vegetated mounds, restored dunes, fill activities, or any other pre-existing human modifications on the tract.
- 9. Topographical survey of the site identifying all elevations, existing contours of the project area (including dunes and scales) and the proposed contours of the final grade. Exhibit G

Other required application information:

- 1. A grading and layout plan showing proposed contours for the final grade. Exhibit B
- 2. The floor plan(s) and elevation(s) of the structure proposed to be constructed or expanded. Exhibit A
- 3. Photographs of the site which clearly show the current location of the vegetation line & existing dunes on the tract within the last 6 months. Exhibit D
- 4. Copy of the Flood Rate Map showing the location of the subject property. (FEMA.GOV Map Search) Exhibit E
- 5. Copy of the Historical Erosion Rate Map as determined by the University of Texas at Austin, Bureau of Economic Geology. (beg.utexas.edu) EXhibit F
- 6. Application Fee of \$180 for Staff Approved applications and \$300 for City Council Approved applications.

Your application is not complete unless all information requested above is submitted.

Application submissions require only three (3) copies of the complete information plus a digital copy.

	Financial Plan for the Remo	oval of All Hard Structures
Department of the City of South Padre Island. Remi	rval of the retaining wall at the owner's expense may	condition that a financial plan for the removal of the retaining wall is submitted to the Public Works be required iffence the retaining wall comes into reguter contact with wave action for liverny (20) out of recitl guarantee, insuring the removal of the retaining wall if the required conditions are met.
Type of Plan Submitted:	N/A	Date Submitted:
	- April annut militari - Li annut militari - L	
	Drain	age
Describe	the impact that the proposed construction will have o	on the natural drainage pattern on the site and adjacent lats.
No change in the drainage on site.		
The proposed construction will change t	he grading and the drainage on the subject pr	operty. (An explanation will be required detailing where the water will drain.)
Explanation / Other Information:		
-		
And the second s	Impacts to Beacl	/ Dune System
	Answer each question as complet	ety as possible in nametive form.
1. What damage will this proposed construct	ion have on the dune vegetation located at th	e project site?
No damage to dune vegetation whatsoe	ver.	
The proposed construction will impact _	100 % of the dune vegetation site. (A	in explanation of the "impact" will be required.)
The proposed construction will require t	ne removal and relocation of $\phantom{00000000000000000000000000000000000$	of the dune vegetation on site. (The submission of a mitigation plan will be required.)
Explanation / Other Information:	·	
How will the proposed construction after t	Calis toeima adi to enodologio enub en	
No change to dune size/shape whatsoe		
The proposed construction will change.		site /Dateile will be required 1
		of the dunes on site. (The submission of a mitigation plan will be required.)
	tile tellinovst stig telocstigit of	or the dunies of tiste. (The submission of a minganon plan will be required.)
Explanation / Other Information:		

3. How will the proposed construction chang	e the hydrology of the dunes at the project sit	e?
No change to dune hydrology whatsoev	er.	
The proposed construction will impact of	une hydrology on site. (Details will be require	rd.)
Explanation / Other Information: Please see	drainage plan provided (Exhibit 8).	
A. Dosoriha alternatives to the proposed cor	which which the translation which will	cause fewer or no adverse effects on dunes and dune vegetation.
N/A	STABILITY OF MEDICA OF CONSTRUCTOR PRIOR THE	outse is to the service and th
13/15.		
5. Describe alternatives to the proposed cor	struction or method of construction which will	cause fewer or no adverse impairment to beach access.
N/A		

MEMORANDUM

TO: Shoreline Task Force

Natalie Bell, General Land Office

FROM: Brandon N. Hill, Shoreline Director

DATE: February 14, 2019

RE: 8414 Breakers Boulevard, Lot 4, Block 4 The Shores Subdivision, Phase One, Section

Two

The applicant has requested permission to build a single family home with a footprint of 2632 square foot. The applicant has provided a signed Beach and Dune Application, floor plan and site plan.

With consideration given to conformance with TAC regulations our preliminary determination is that:

- 1. The proposed activity will not reduce the size of the public beach. [TAC 15.5 (b)(1)]
- 2. The proposed activity does not appear to involve construction upon the public beach. [TAC 15.5 (c)(1)] The proposed activity will involve accessing private property from the public beach for the purpose on construction.
- 3. The proposed activity will not encroach upon the public beach. [TAC 15.5 (c)(1)]
- 4. The proposed activity will not close any existing public beach accesses within the area, nor will the construction close or prevent the use of any existing public beach parking spaces. [TAC 15.5 (d)(1)]

With consideration given to the City's *Dune Protection and Beach Renourishment and Access Plan* [B&D Ord. Section 22-10]:

- 1. The proposed activity will not result in the potential for increased flood damage to the subject property or adjacent properties.
- 2. The proposed activity will not result in run-off or drainage patterns that aggravate erosion on and off the site.
- 3. The proposed activity will cause no permanent changes to the existing dune hydrology east of the Historic Building Line.
- 4. The proposed activity will result in adverse effects on dune vegetation. These effects will be mitigated through the actions outlined in the attached application.
- 5. The proposed activity will not significantly increase the potential for washover or blowouts.

Brandon N. Hill



March 4, 2019

Via Electronic Mail

Brandon Hill
Director, Shoreline Management Department
City of South Padre Island
P.O Box 3410
South Padre Island, Texas 78597-3410

Beachfront Construction Certificate & Dune Protection Permit in the City of South Padre Island

Site Address: 8414 Breakers Boulevard, South Padre Island

Legal Description: Lot 4, Block 4, The Shores Subdivision, Phase I, Section II

Lot Applicant: Stan Richards c/o Daniel de la Cruz

GLO ID No.: BDSPI-19-0044

Dear Mr. Hill:

The General Land Office (GLO) has reviewed the application materials submitted for a dune protection permit and beachfront construction certificate for the above-referenced location. The applicant proposes to construct a single-family residence with associated amenities in an area landward of the Historic Building Line (HBL) and Setback Line (SBL). The applicant also proposes off-site compensation for adverse effects to 7,490 square feet of dune vegetation on common area tracts owned by The Shores subdivision in areas seaward of the HBL. The applicant proposes to plant 8,220 square feet of dune vegetation in the areas outlined on Exhibit C of the application materials. According to the Bureau of Economic Geology, the area is eroding at a rate of four to five feet per year.

Based on the materials forwarded to our office for review, we have the following comments:

- The City shall allow restoration of dune vegetation on the public beach no more than 20 feet seaward of the landward boundary of the public beach, or the line of vegetation. The City shall ensure that the 20-foot restoration area follows the natural migration of the vegetation line.¹
- Construction activities must not impact the public's ability to access or use the beach.
- The applicant must restore or repair dune vegetation using indigenous vegetation that will achieve the same protective capability or greater capability as the surrounding natural dunes.²
- The proposed construction activities must minimize impacts on natural hydrology and not cause erosion of adjacent properties, critical dune areas, or the public beach.³

¹ 31 Tex. Admin. Code §15.7(e)(1).

² 31 Tex. Admin. Code §15.4(f)(3)(A)(iv).

³ 31 Tex. Admin. Code § 15.6(g).

- The City must require the applicant to demonstrate that it has achieved a 1:1 ratio of the adverse effects upon successful, complete, and stabilized restoration prior to beginning construction.⁴
- The City shall include a condition in the permit which requires the permittee to notify the City in writing of the actual date of initiation of compensation within ten working days after compensation is initiated.⁵
- The City must require the applicant to conduct compensation efforts continuously until the dune vegetation is equal or superior to the pre-existing dune vegetation. These efforts shall include preservation and maintenance pending completion of compensation.⁶
- The City shall determine a mitigation and compensation project is complete when the dune restoration project's position, contour, volume, elevation, and vegetative cover have reached a level that matches or exceeds the surrounding naturally formed dunes.⁷
- The City shall provide written notification to the GLO after determining that the mitigation and compensation is complete. The GLO may conduct a field inspection to verify compliance.⁸
- The City must ensure the proposed construction is consistent with FEMA minimum requirements or with the FEMA-approved local ordinance.⁹
- Construction activities must not impact the public's ability to access or use the beach.

If you have any questions, please contact me by phone at (512) 463-0413 or by email at natalie.bell@glo.texas.gov.

Sincerely,

Natalie Bell

Manager, Beach Access & Dune Protection Program

Coastal Resources Division

Texas General Land Office

⁴ 31 Tex. Admin. Code § 15.4(f)(4)(B).


⁵ 31 Tex. Admin. Code § 15.4(f)(4)(C)(vii).

⁶ 31 Tex. Admin. Code § 15.4(g)(2).

⁷ 31 Tex. Admin. Code § 15.4(g)(3).

⁸ 31 Tex. Admin. Code § 15.4(g)(4).


⁹ 31 Tex. Admin. Code § 15.6 (e)(3).

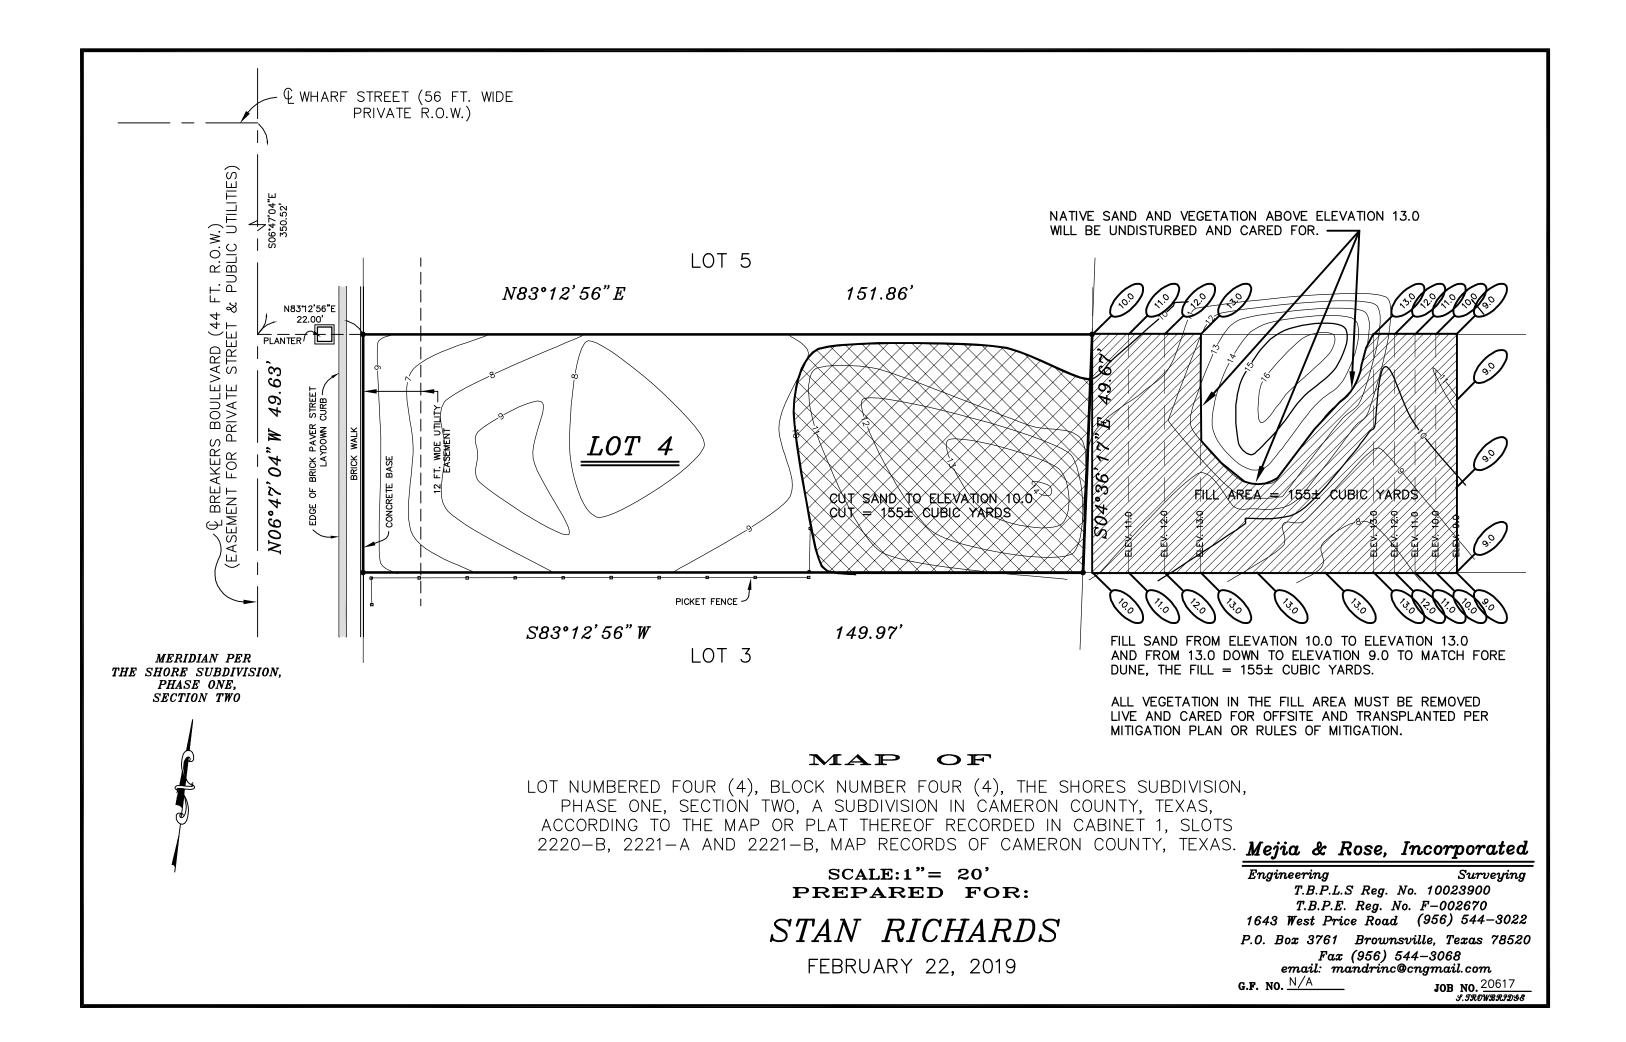


DRAWING TITLE

SITE PLAN

A1.02

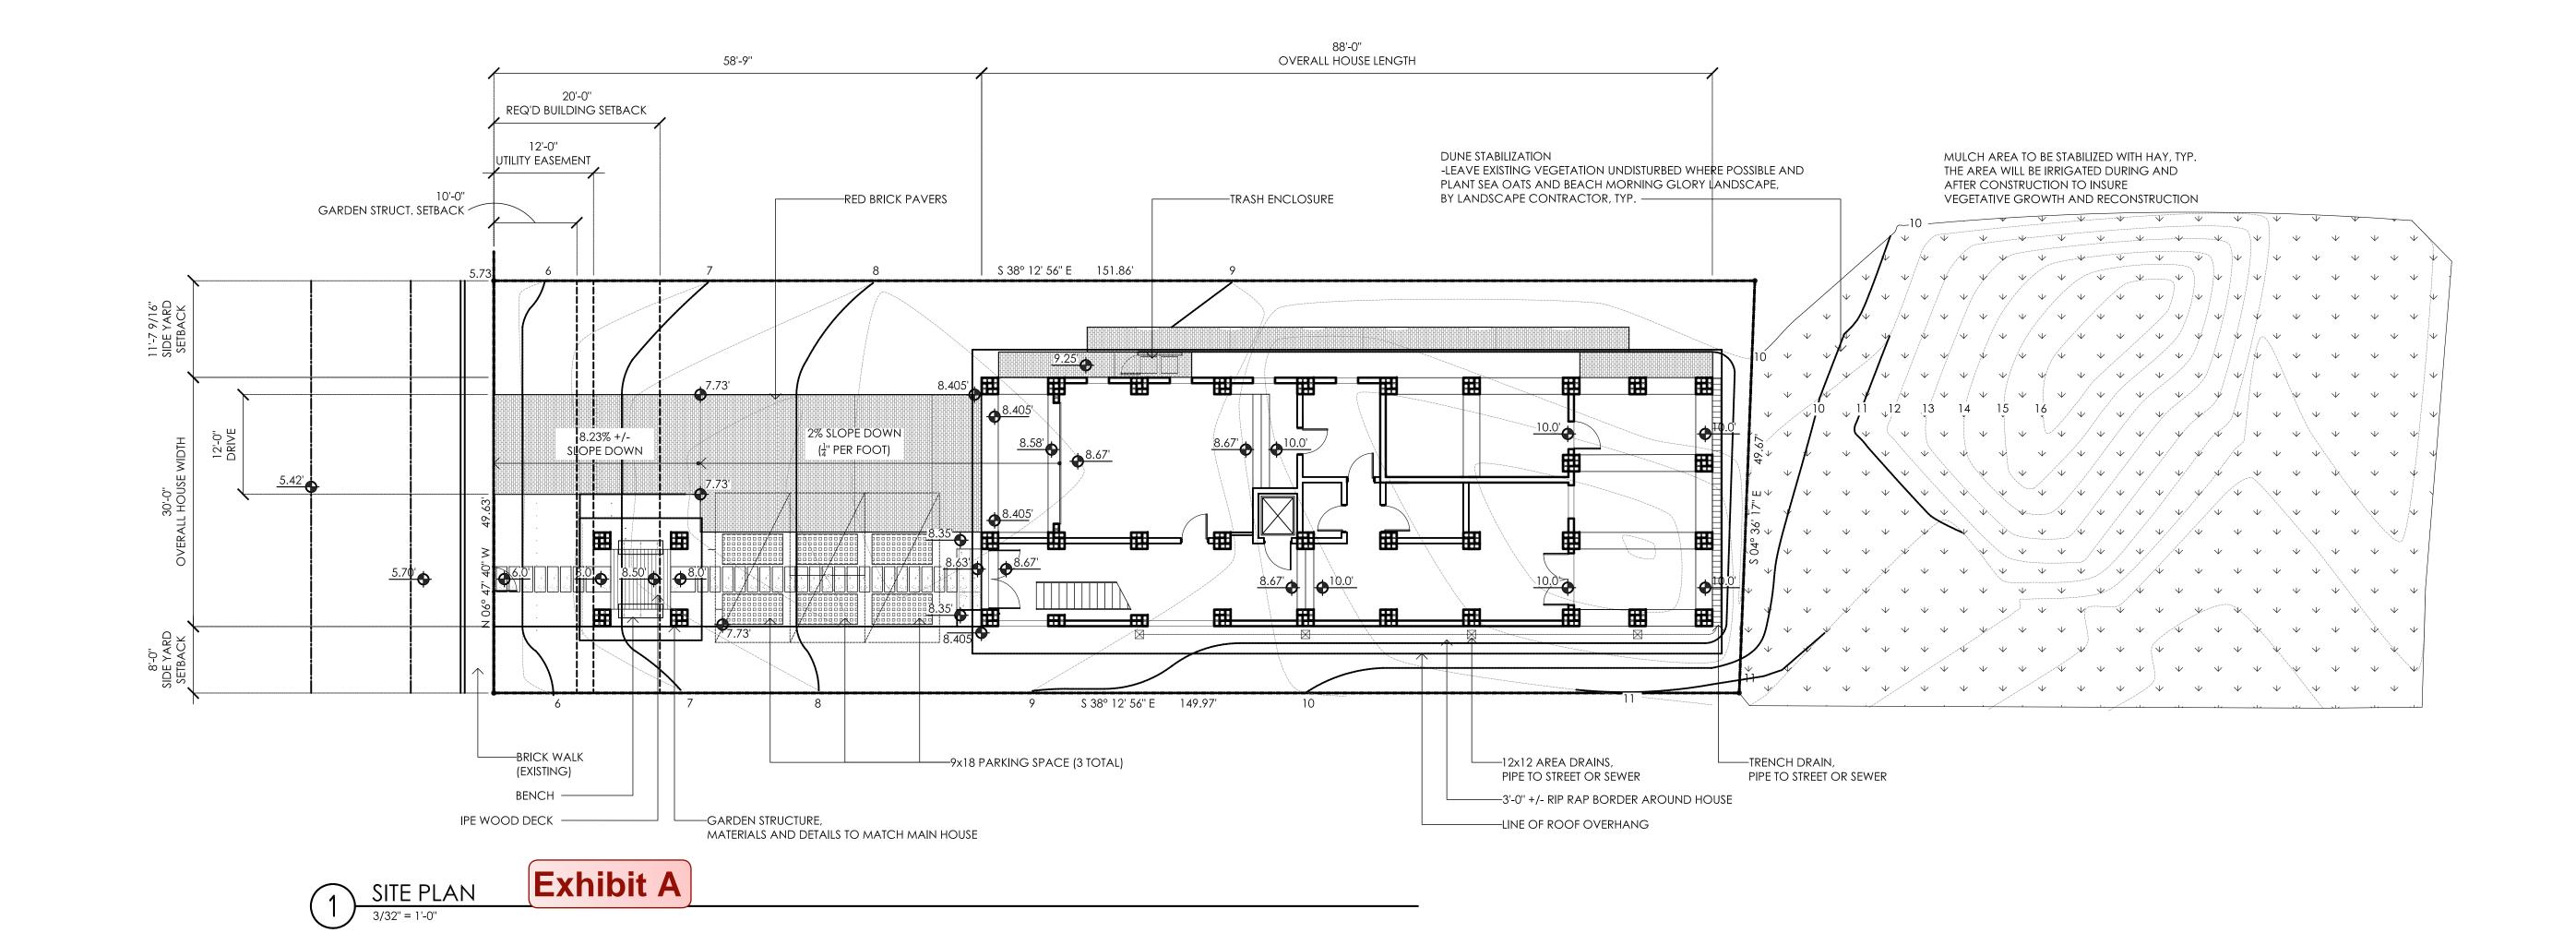

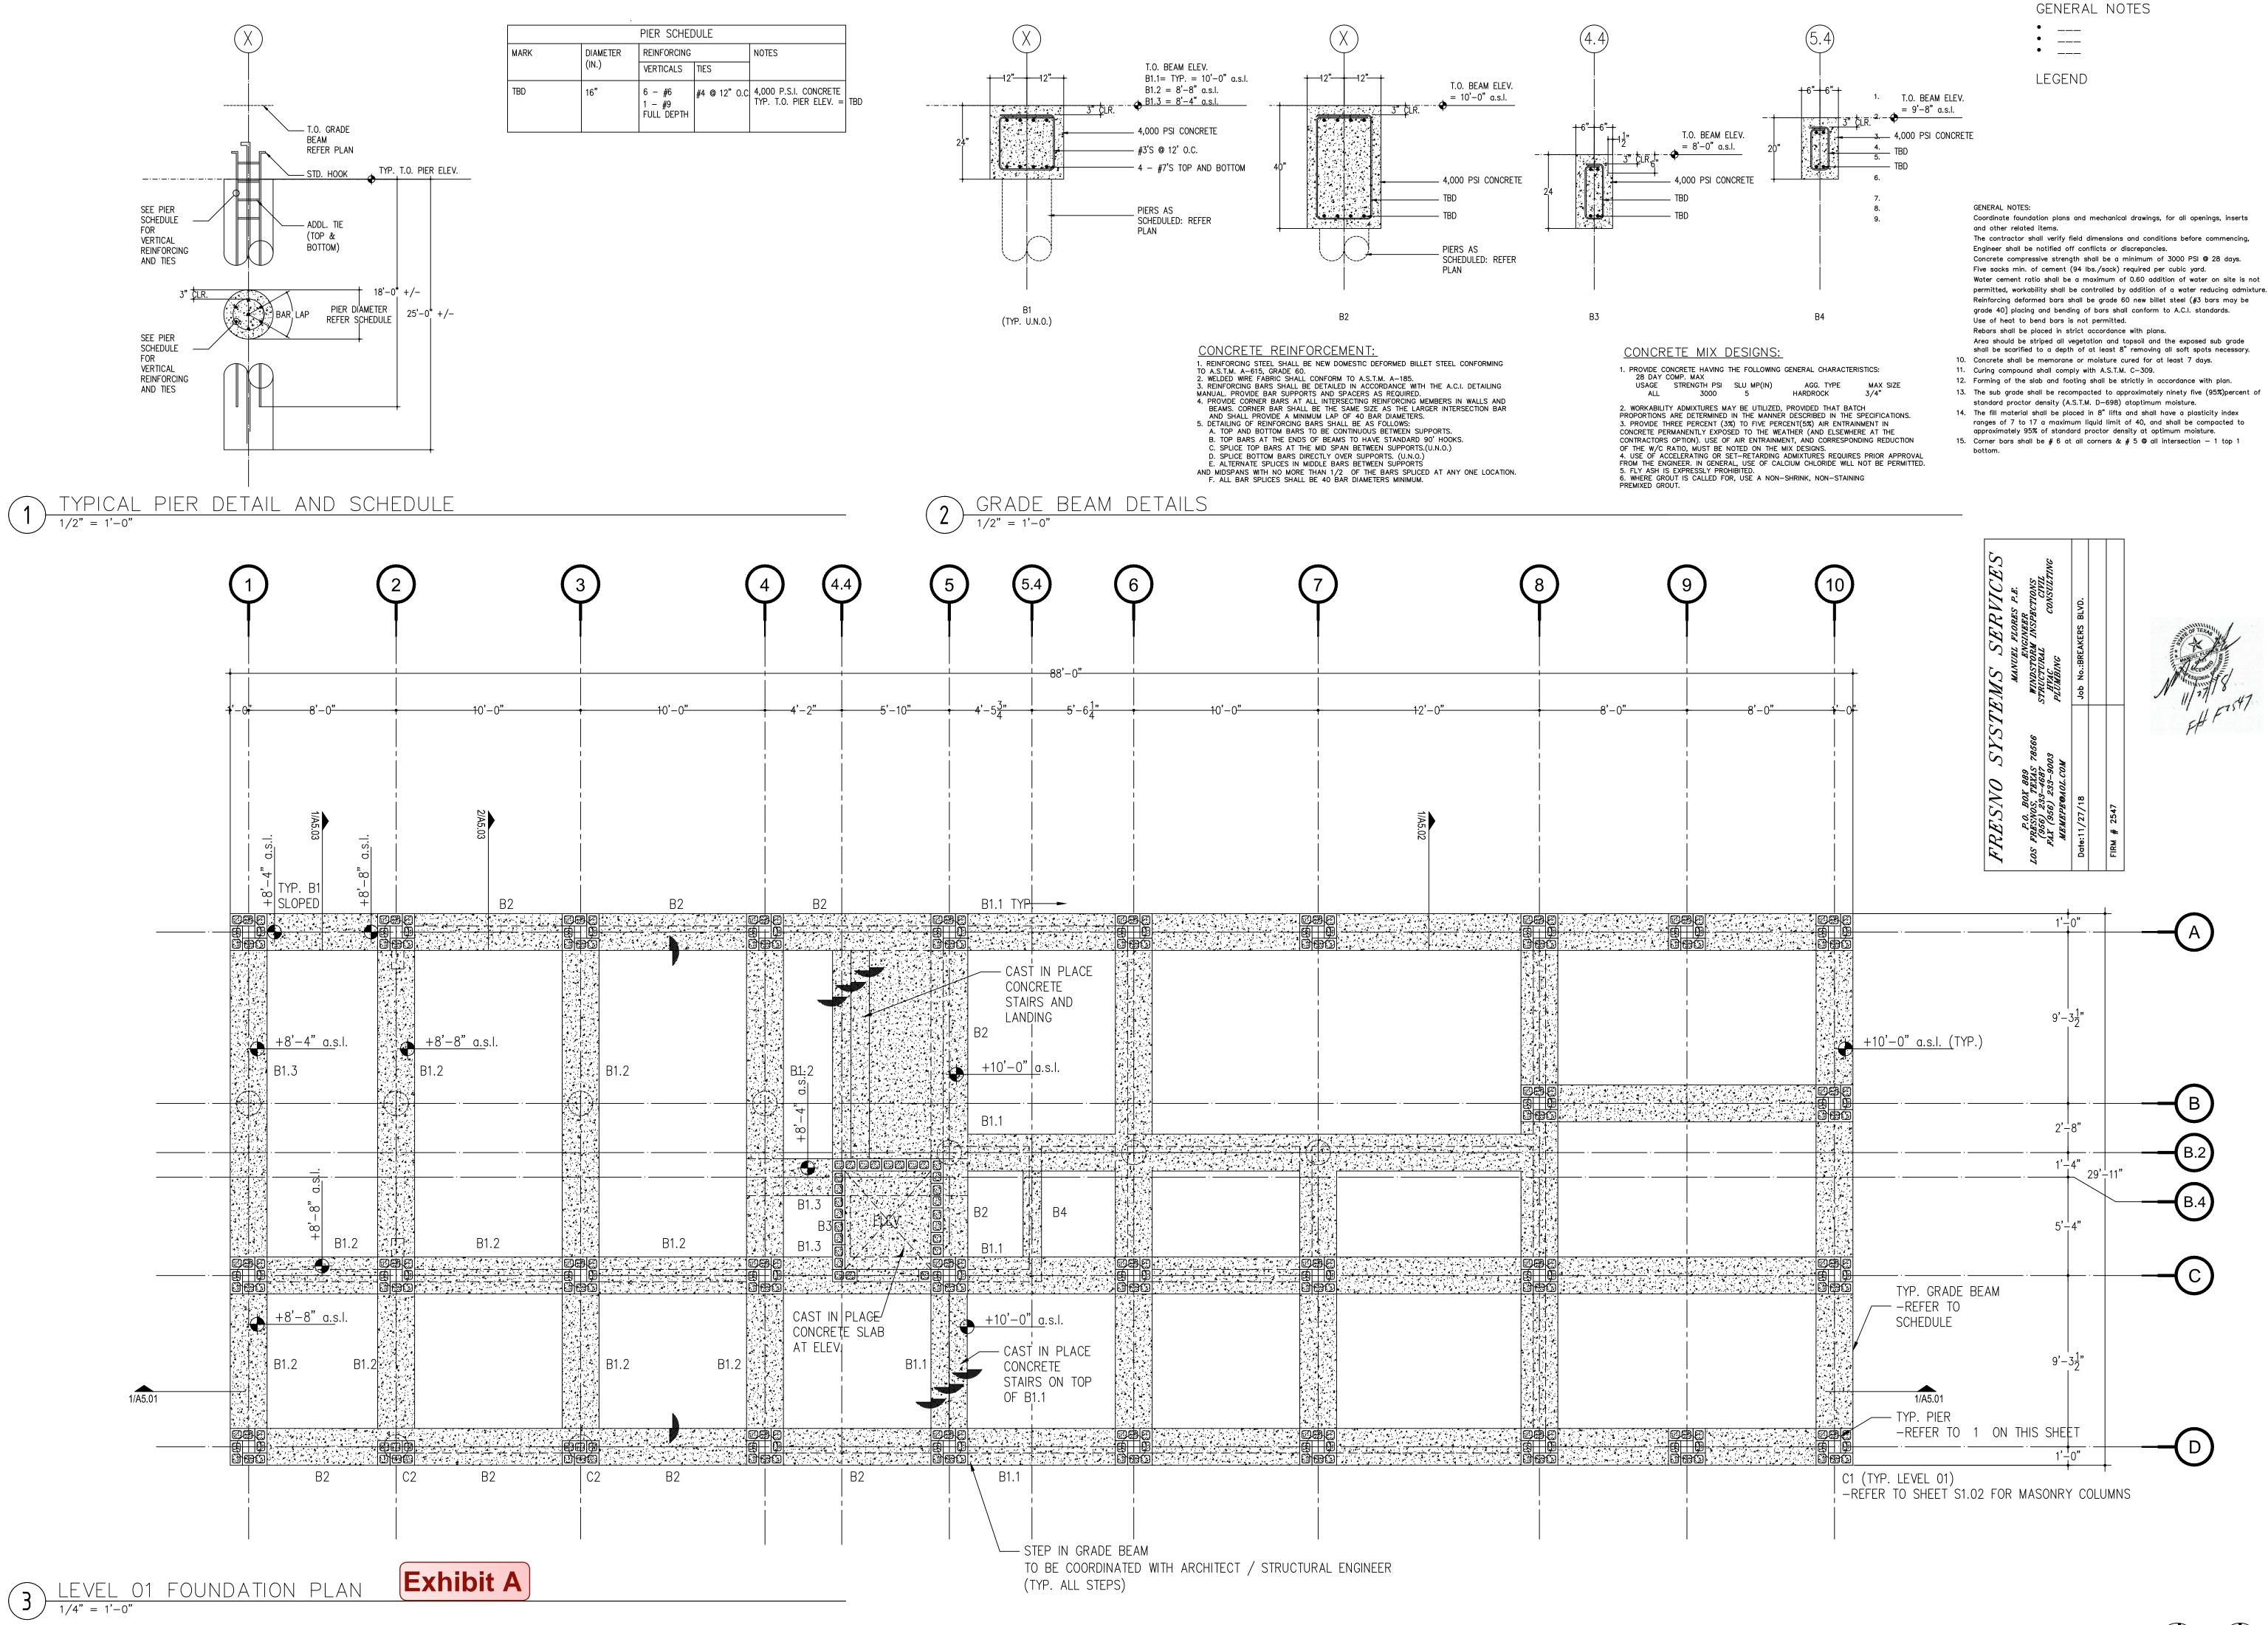

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architect.



for regulatory approval, permitting or construction.

SE cunningha

SHEAKERS BLVD

84xx BREAKERS BLVD

800TH PADRE ISLAND, TEXAS 7859

DRAWING TITLE

LEVEL 01 FOUNDATION PLAN

SHEET NO.

TRUE NORTH PLAN NORTH S1.0

andeson "a series" STORM WATCH COASTAL IMPACT WINDOWS REFERENCE EXTERIOR

ELEVATIONS FOR WEILAND WINDOW FRENCH DOOR ALTERNATIVE AT EAST AND WEST FACADES

LEGEND


• ___

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ninghamarc, 1918 Dragon Street, Dallas, Texas 7520

cum



LEVEL 1 GROSS SQUARE FOOTAGE=
2642 SF INCLUDING PORCHES
2000 SF EXCLUDING PORCHES

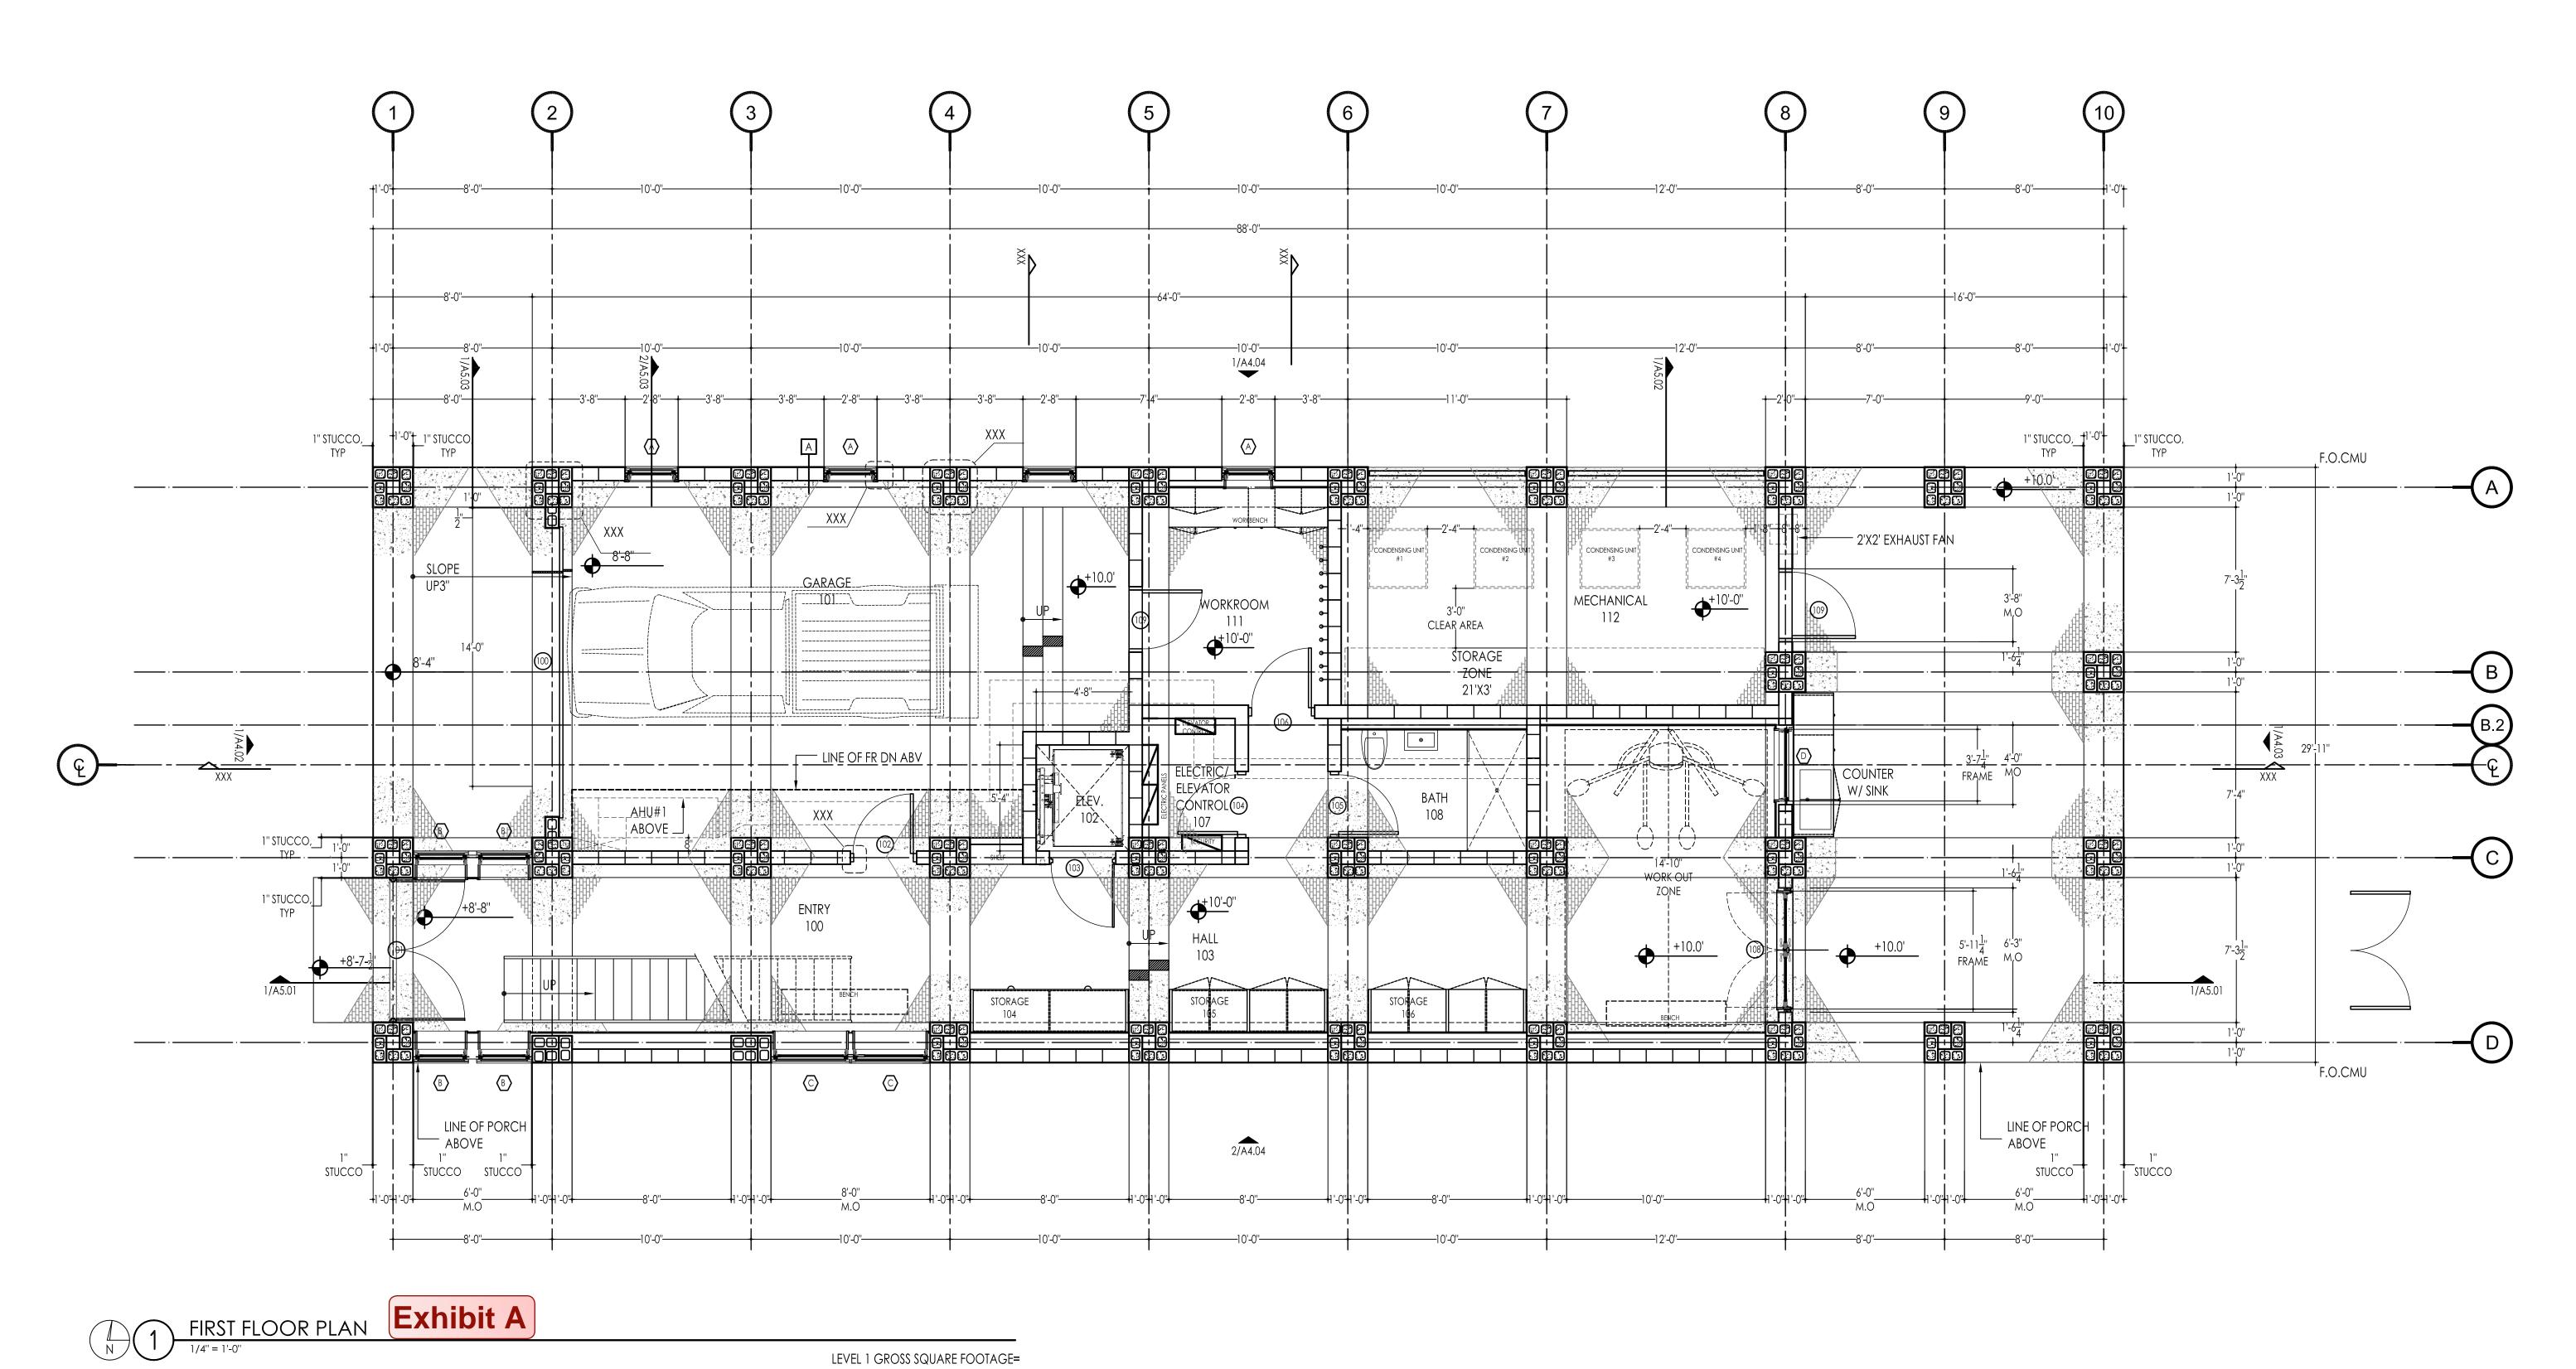832 SF AIR COND.

11.16.18 REVIEW

RICHARD'S BEACH HOUSE

DRAWING TITLE

FIRST FLOOR PLAN

SHEET NO.

A2.01

 ALL WINDOWS ARE ANDESON "A SERIES" STORM WATCH COASTAL IMPACT WINDOWS REFERENCE EXTERIOR

ELEVATIONS FOR WEILAND WINDOW FRENCH DOOR ALTERNATIVE AT EAST AND WEST FACADES

LEGEND


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ninghamarchitect
918 Dragon Street, Dallas, Texas 75207 - v.214.915.0900 - f.214.915.

cuni



RICHARD'S BEACH HOUSE
84xx BREAKERS BLVD
SOUTH PADRE ISLAND, TEXAS 78597

ISSUED 11.16.18 REVIEW

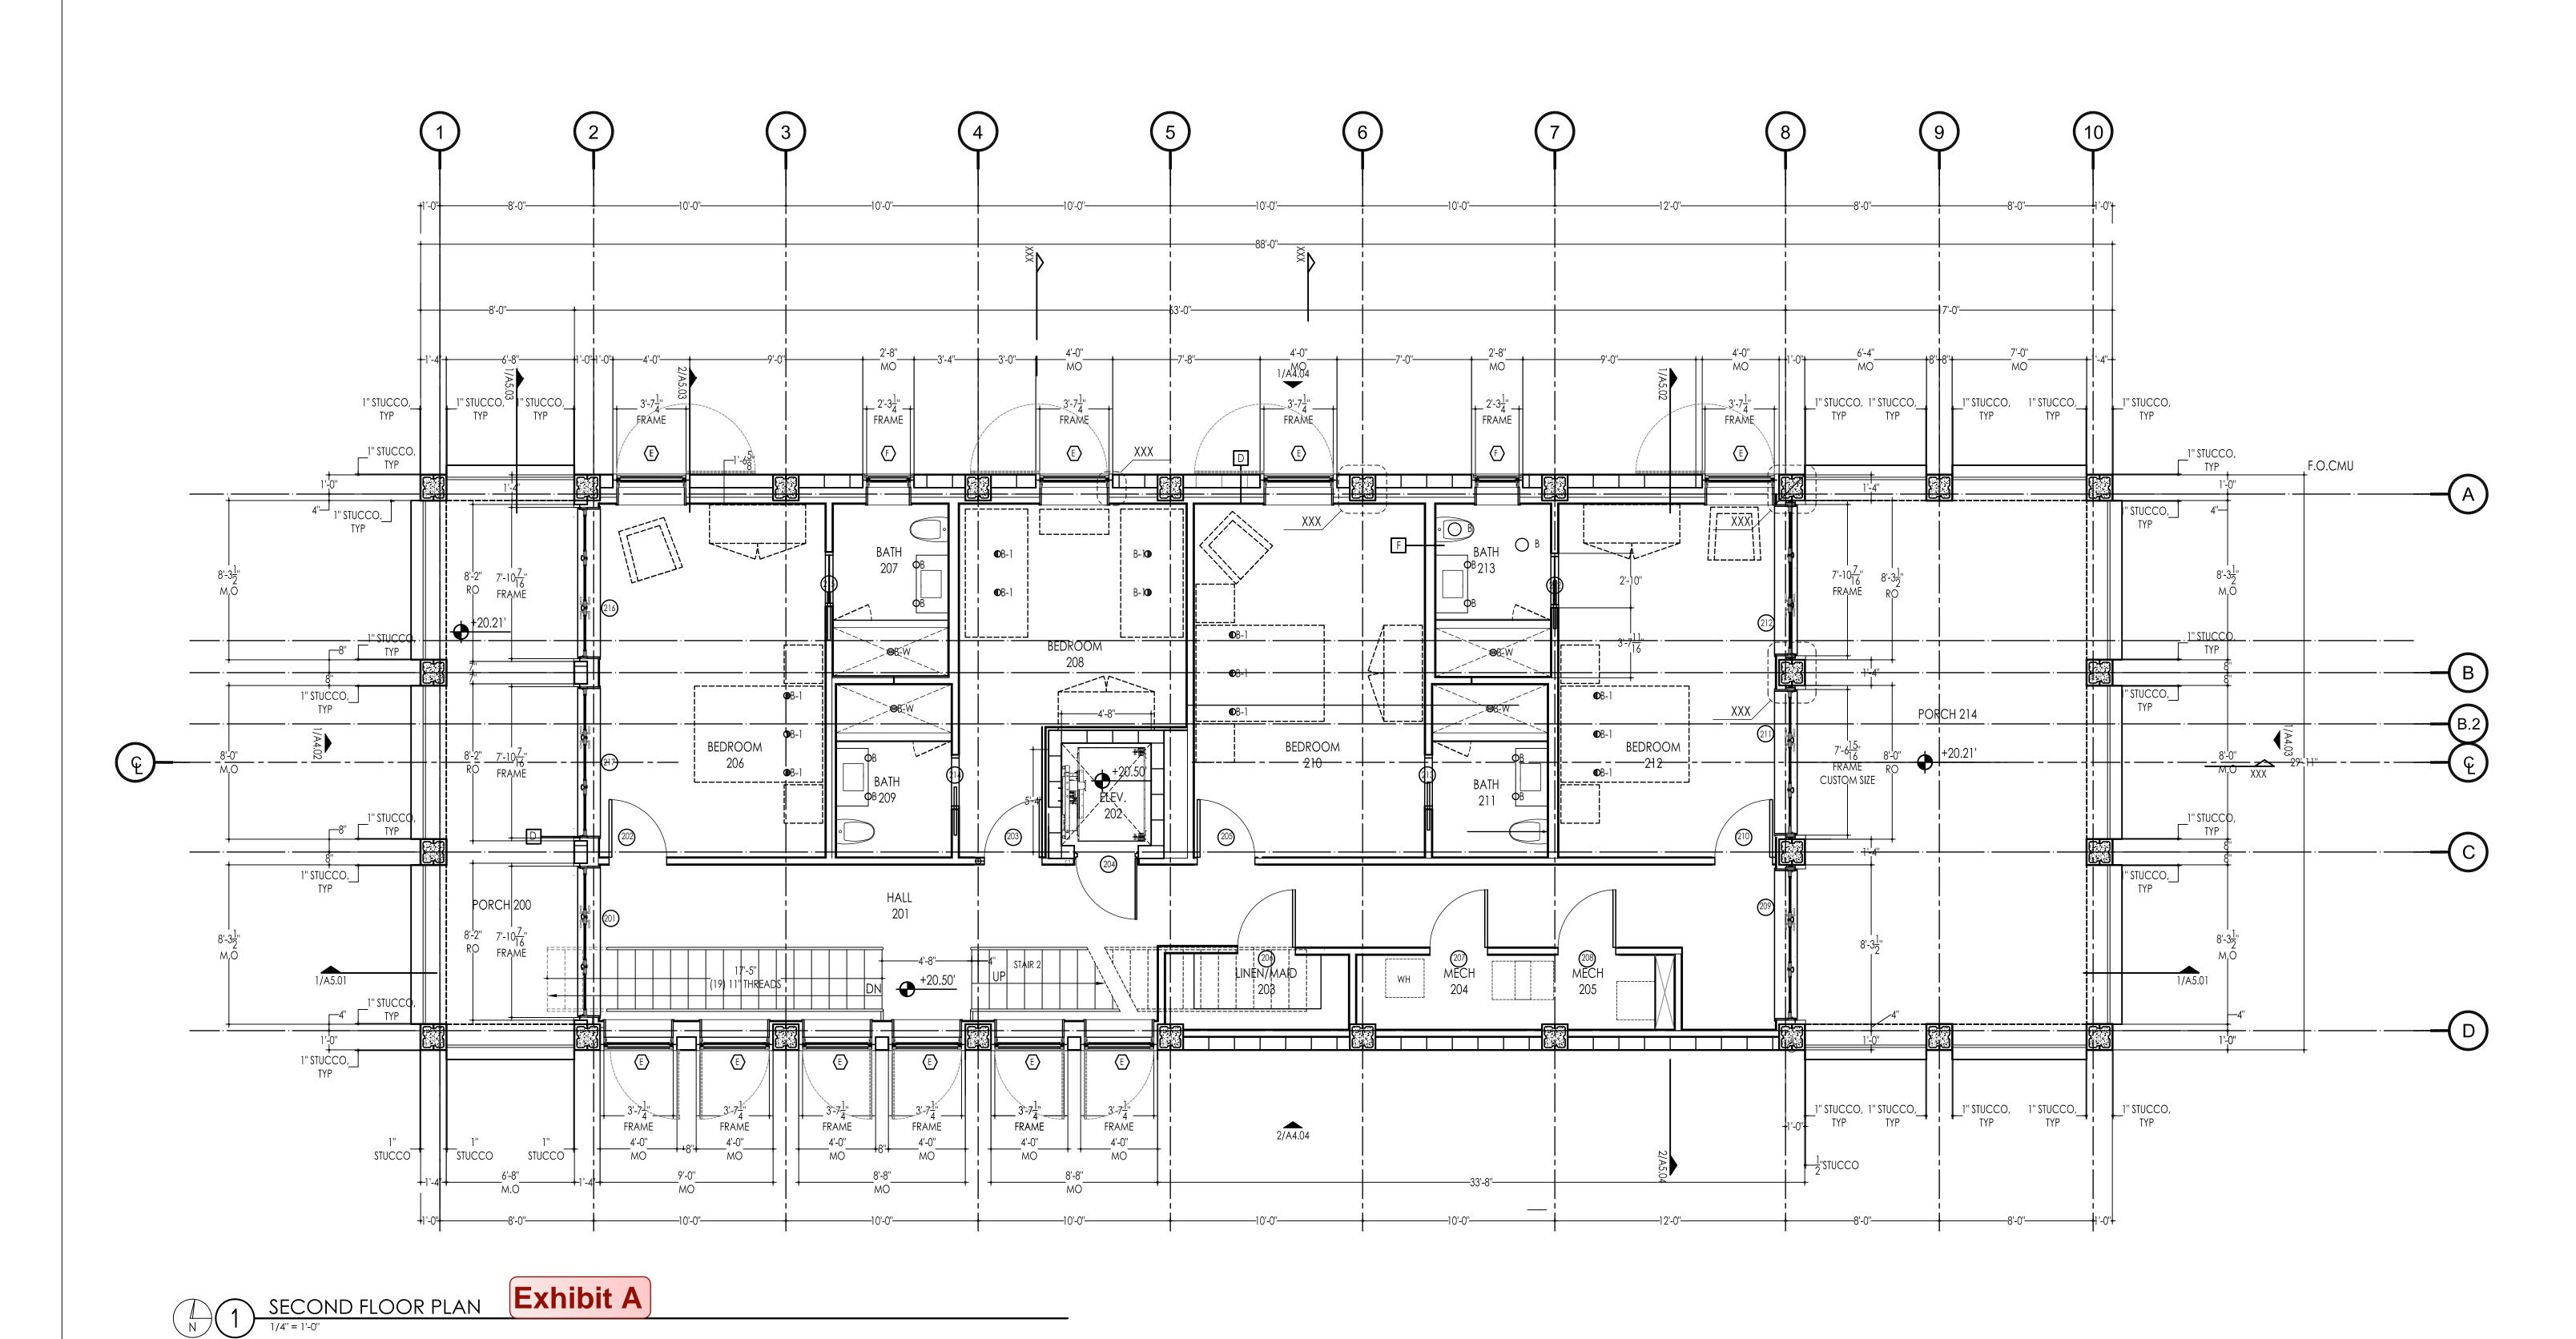DRAWING TITLE

SECOND FLOOR PLAN

SHEET NO.

A2.02


- ALL WINDOWS ARE ANDESON "A SERIES"
- STORM WATCH COASTAL IMPACT WINDOWS REFERENCE EXTERIOR ELEVATIONS FOR WEILAND WINDOW
- FRENCH DOOR ALTERNATIVE AT EAST AND WEST FACADES • ___

LEGEND

approval, permitting or construction.

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cunt

RICHARD'S BEACH HOUSE
84xx BREAKERS BLVD
SOUTH PADRE ISLAND, TEXAS 78597

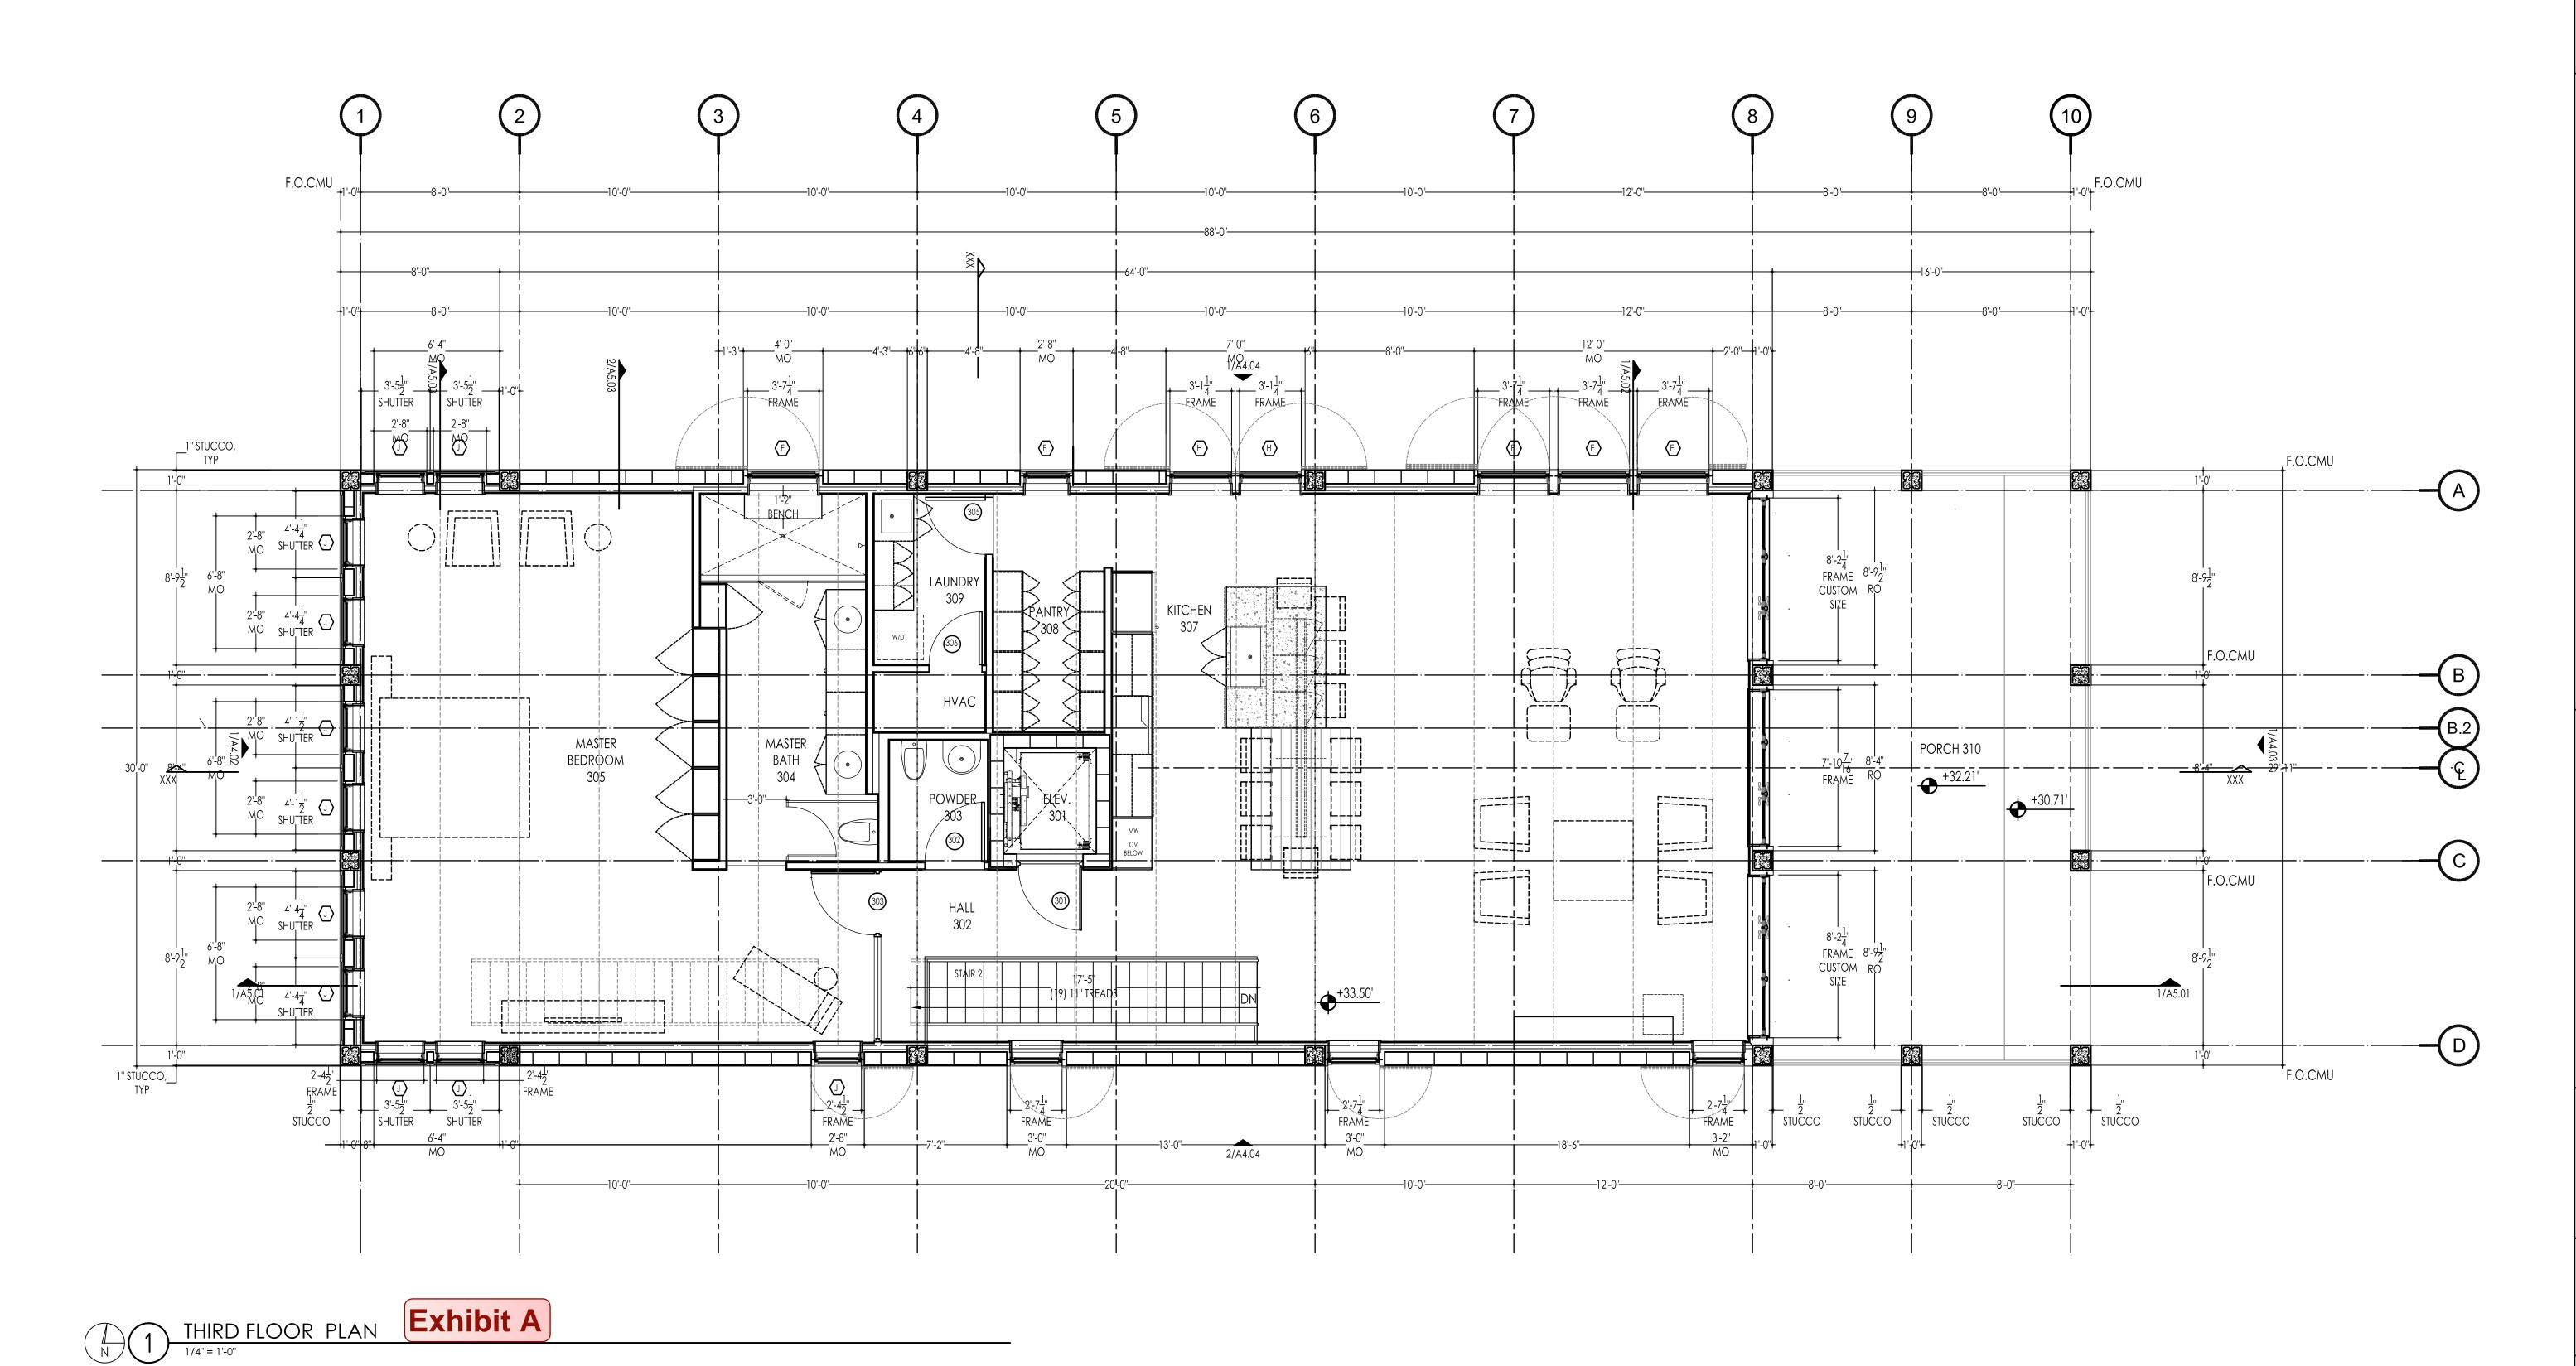ISSUED 11.16.18 REVIEW

DRAWING TITLE

THIRD FLOOR PLAN

SHEET NO.

A2.03

GENERAL NOTES

ALL WINDOWS ARE ANDESON "A SERIES"

STORM WATCH COASTAL IMPACT WINDOWS

EAST AND WEST FACADES
 HAVE WEILAND WINDOW
 FRENCH DOORS AS


ALTERNATES

DRAWING TITLE

EXTERIOR ELEVATIONSanderson BASE PRICE

SHEET NO.

A4.01

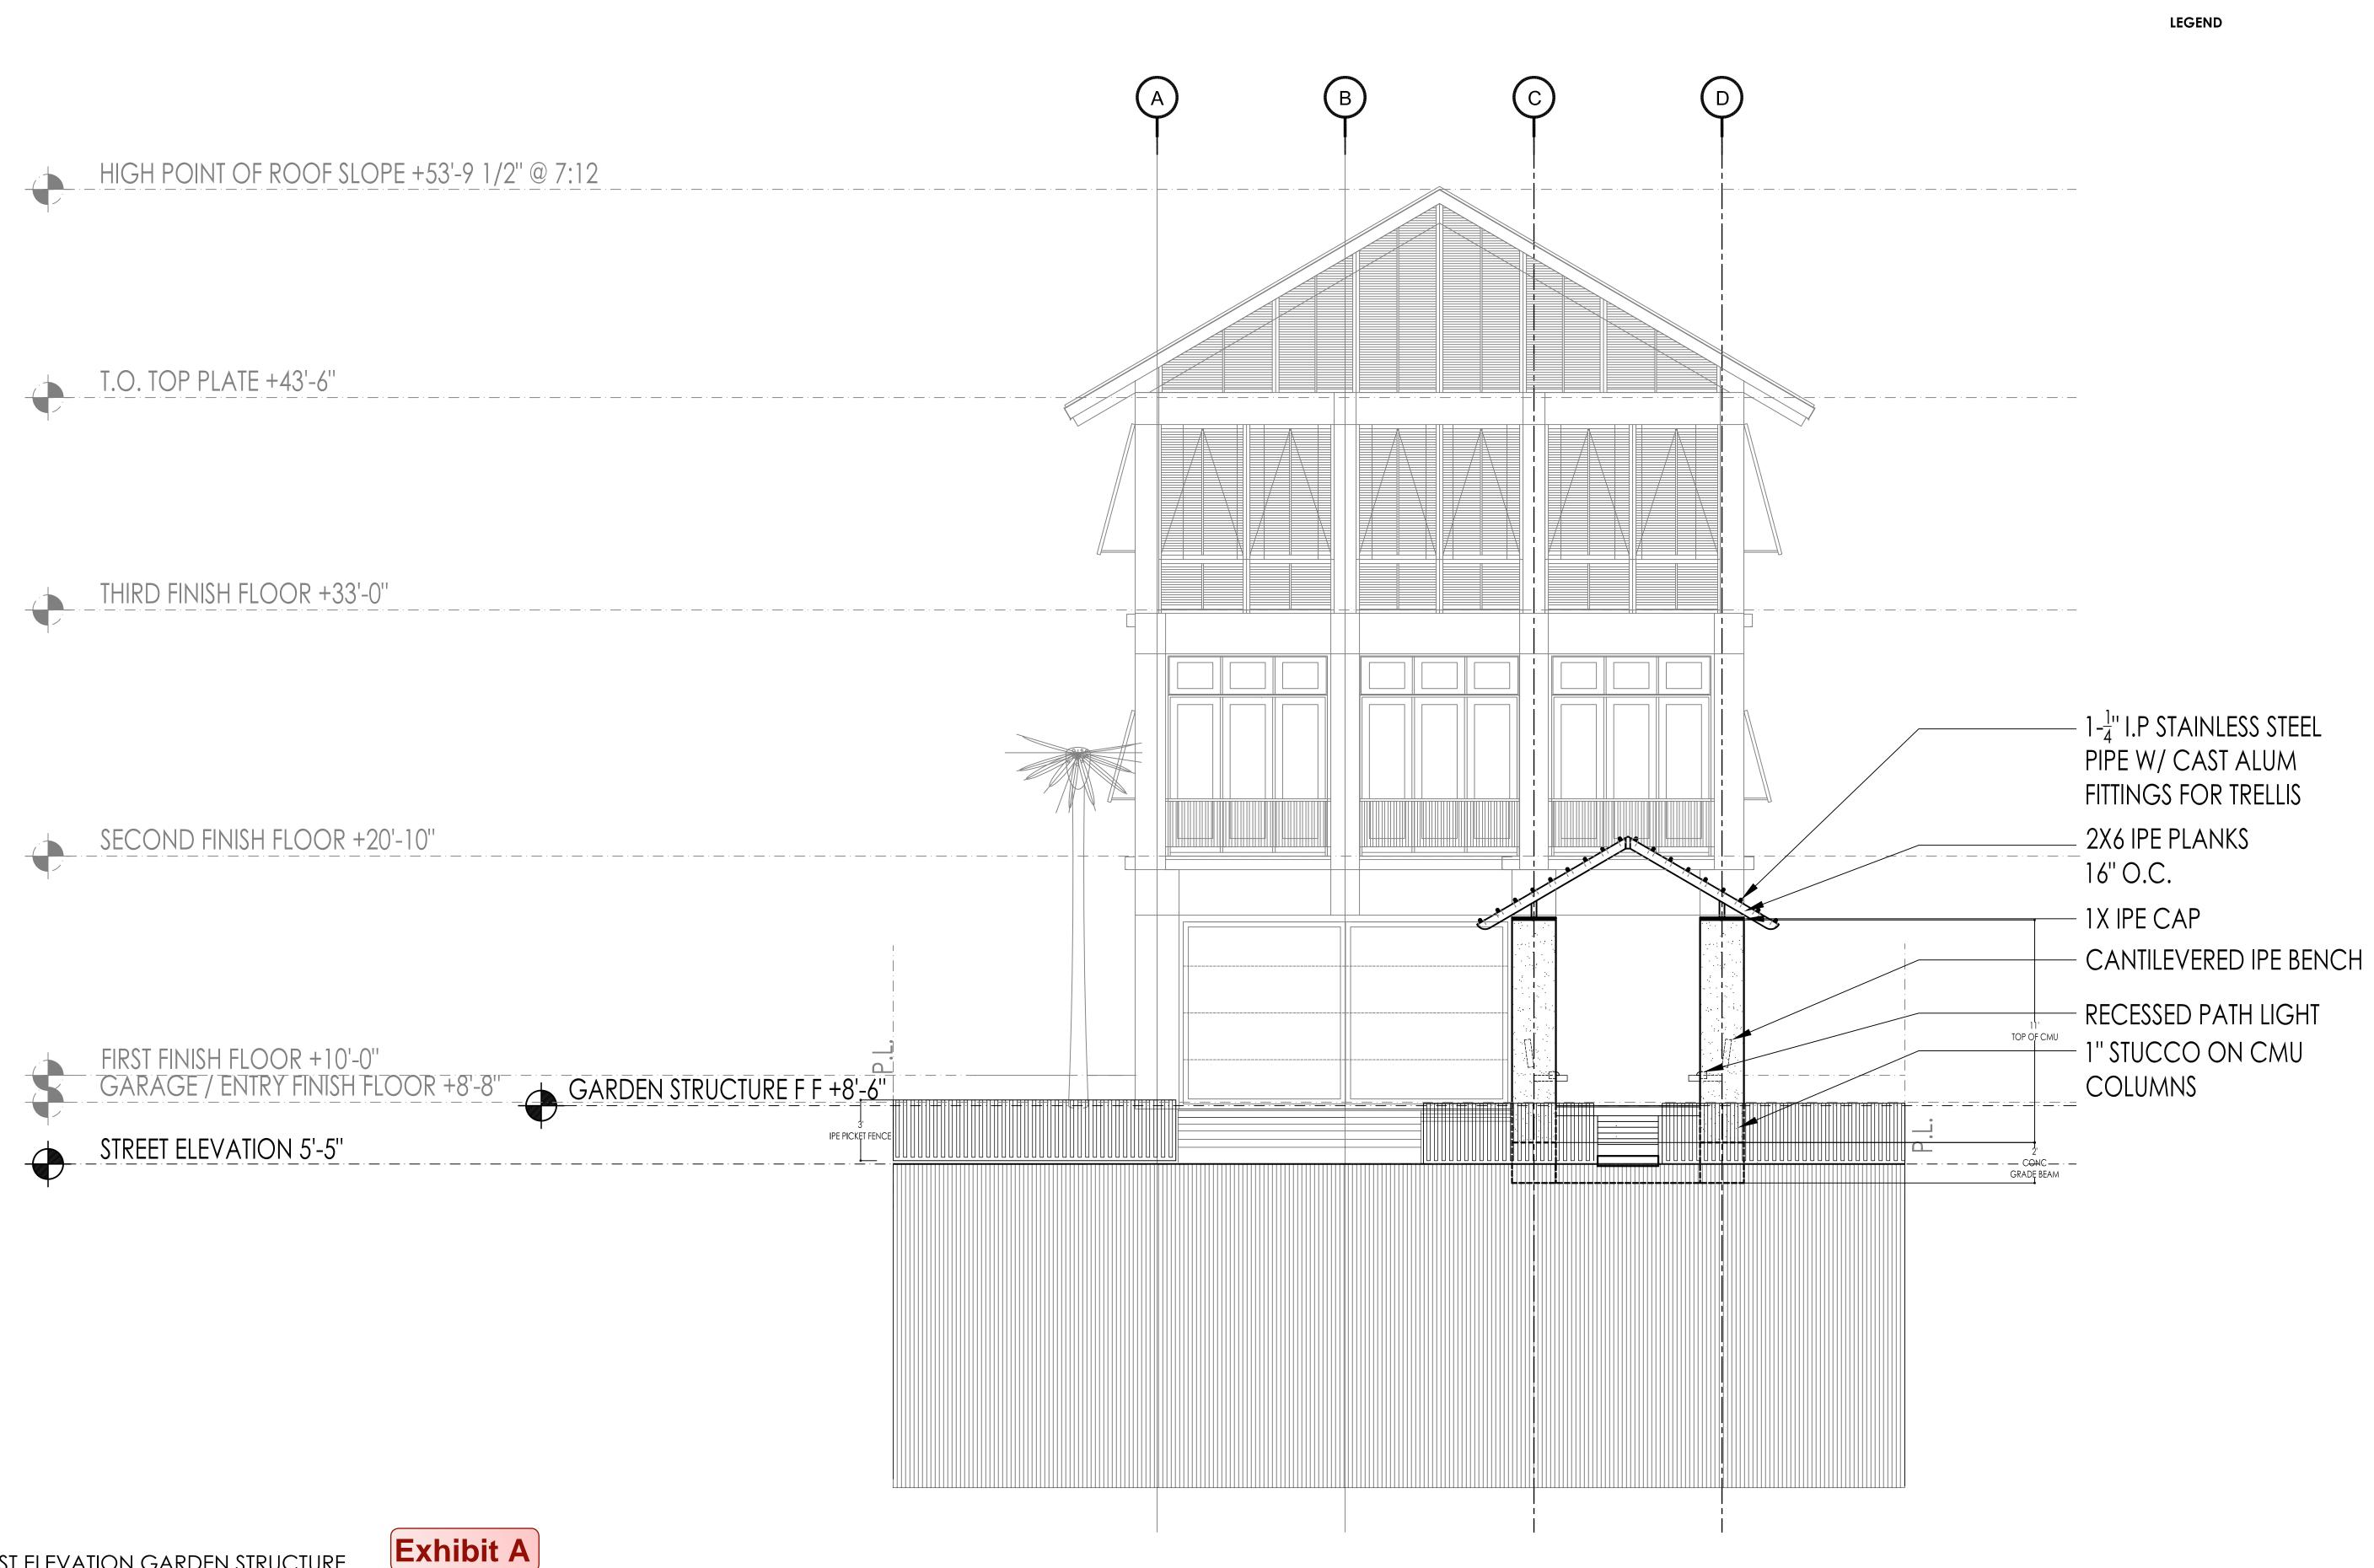

WEST ELEVATION GARDEN STRUCTURE

1/4" = 1'-0"

IMPACT WINDOWS


EAST AND WEST FACADES
 HAVE WEILAND WINDOW
 FRENCH DOORS AS

ALTERNATES

cuni

SHEET NO.

A4.02.a

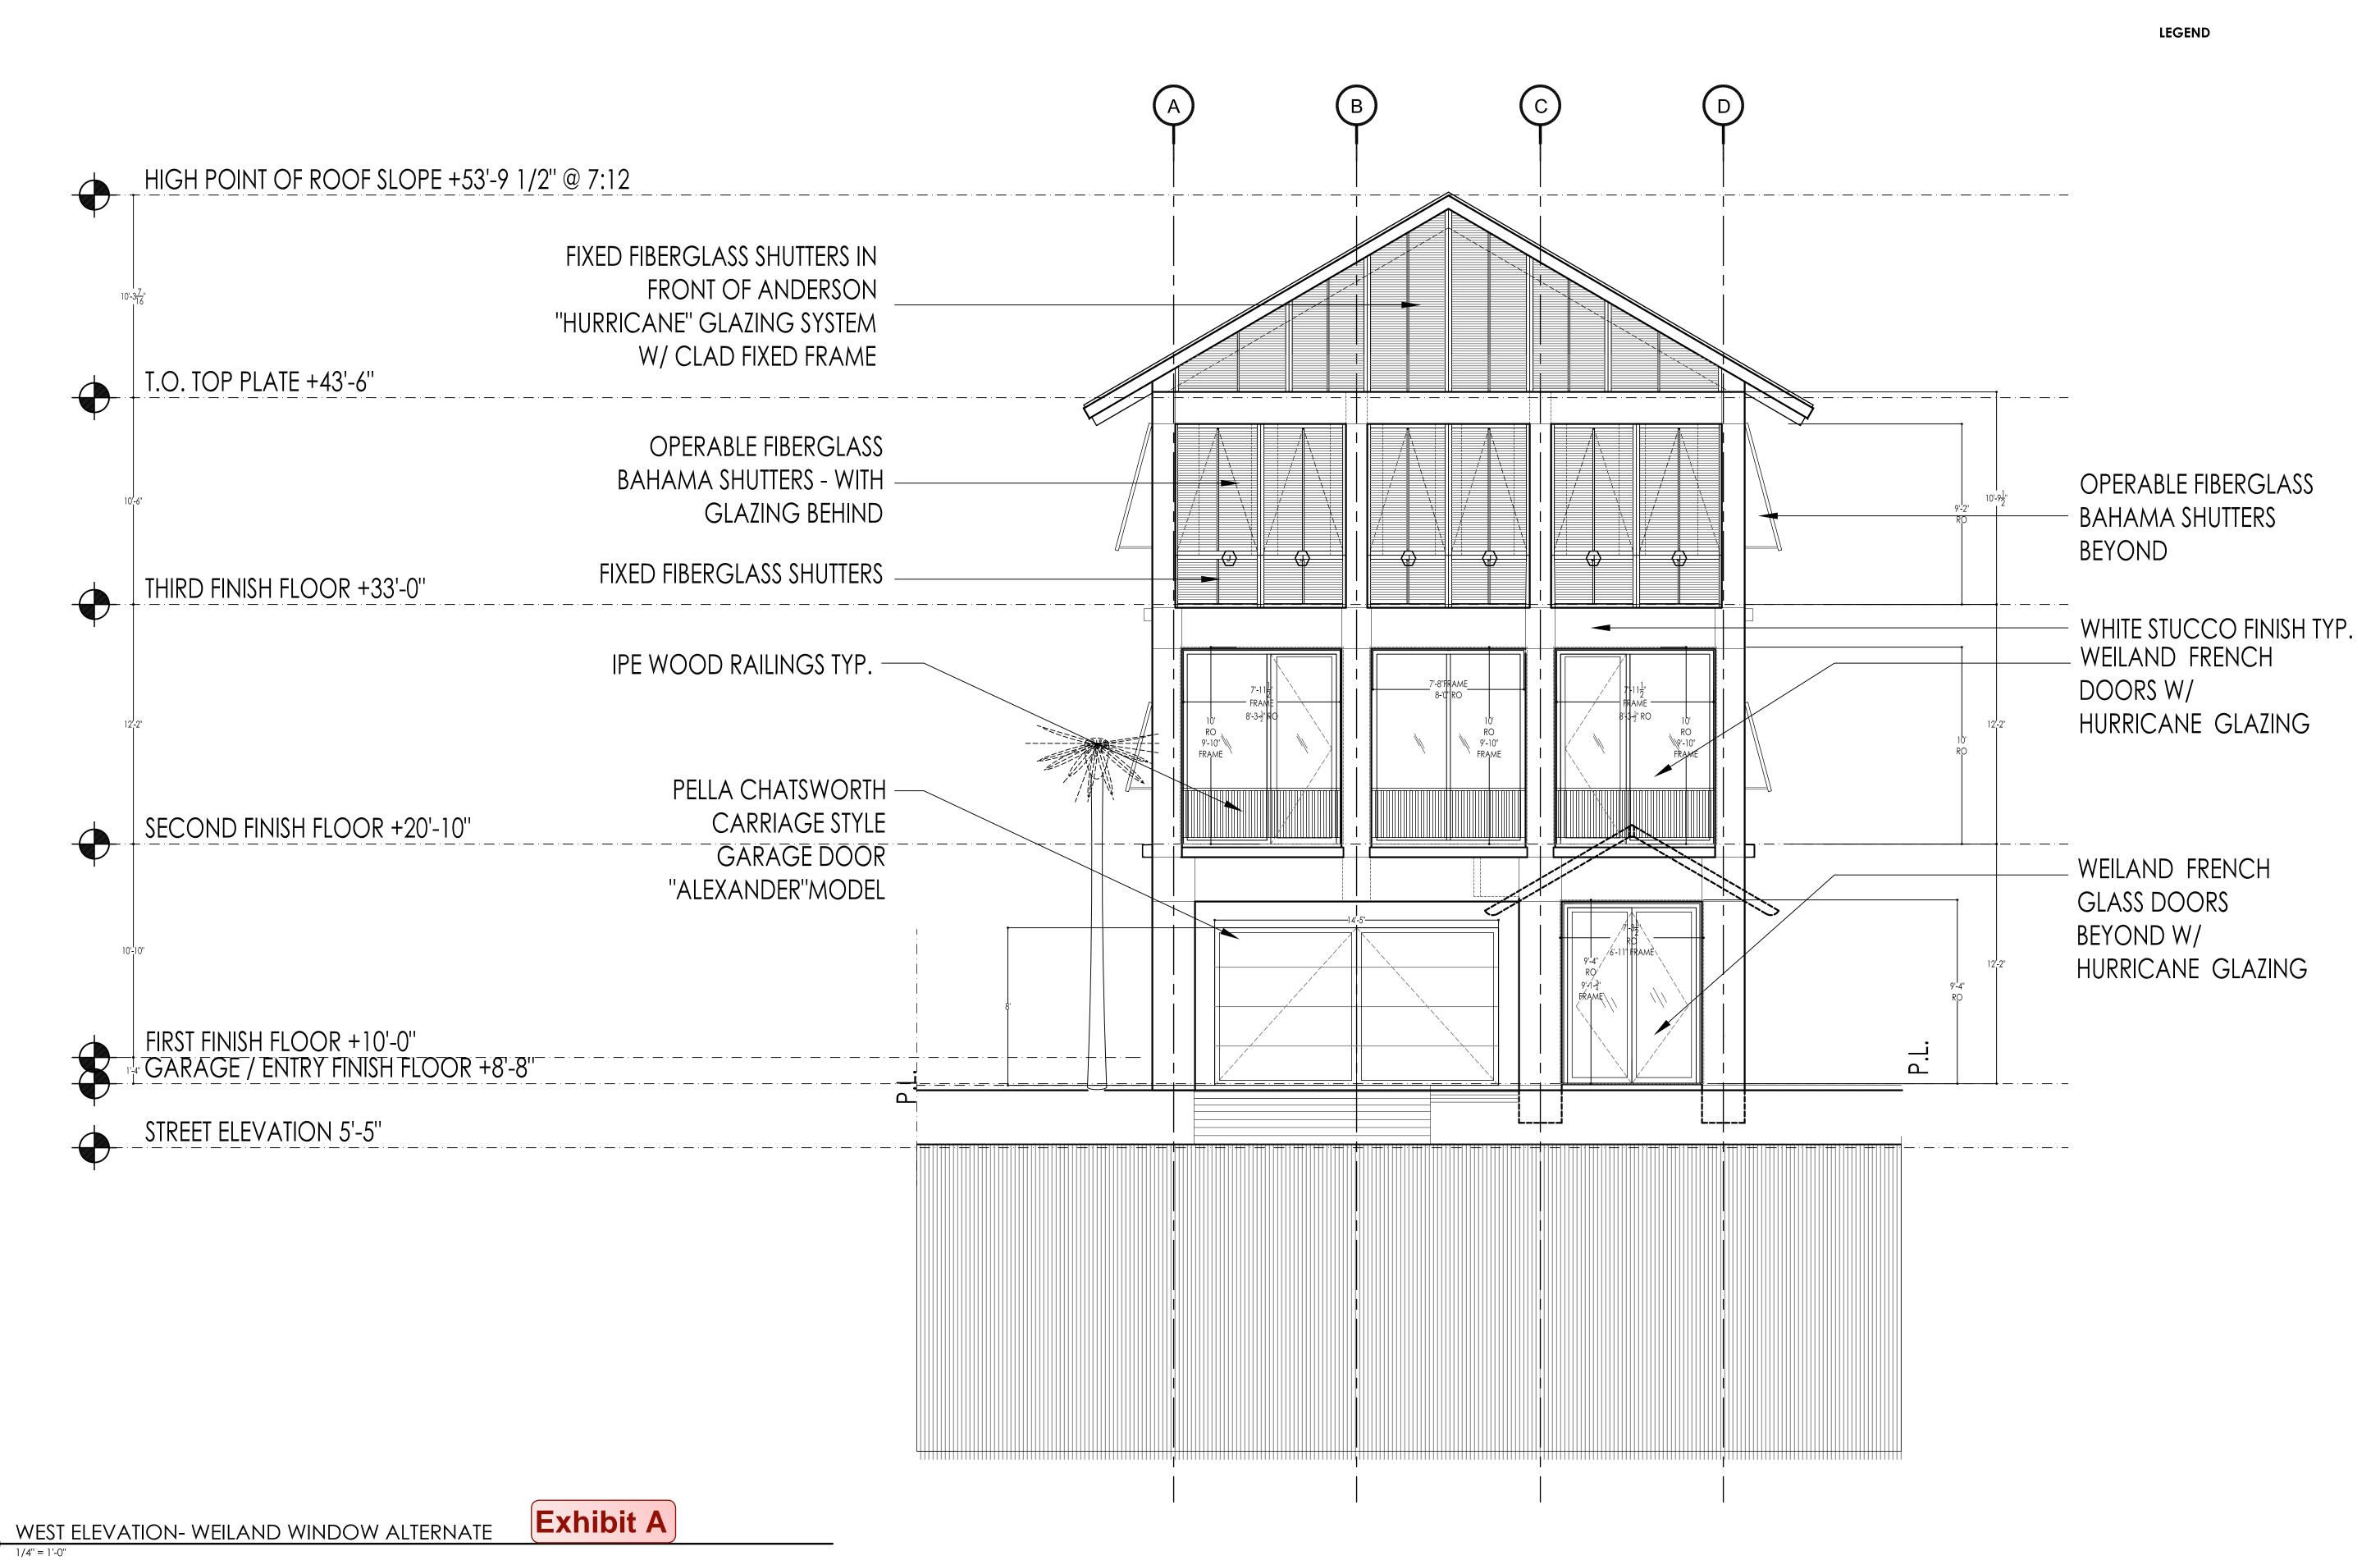

IMPACT WINDOWS

EAST AND WEST FACADES
 HAVE WEILAND WINDOW
 & FRENCH DOORS AS

ALTERNATES

ningham architects


918 Dragon Street, Dallas, Texas 75207 - v.214.915,0900 - f.214.915,0901 cuni

RICHARD'S BEACH HOUSE


DRAWING TITLE

EXTERIOR **ELEVATIONS-**ANDERSON BASE PRICE

A4.02.b

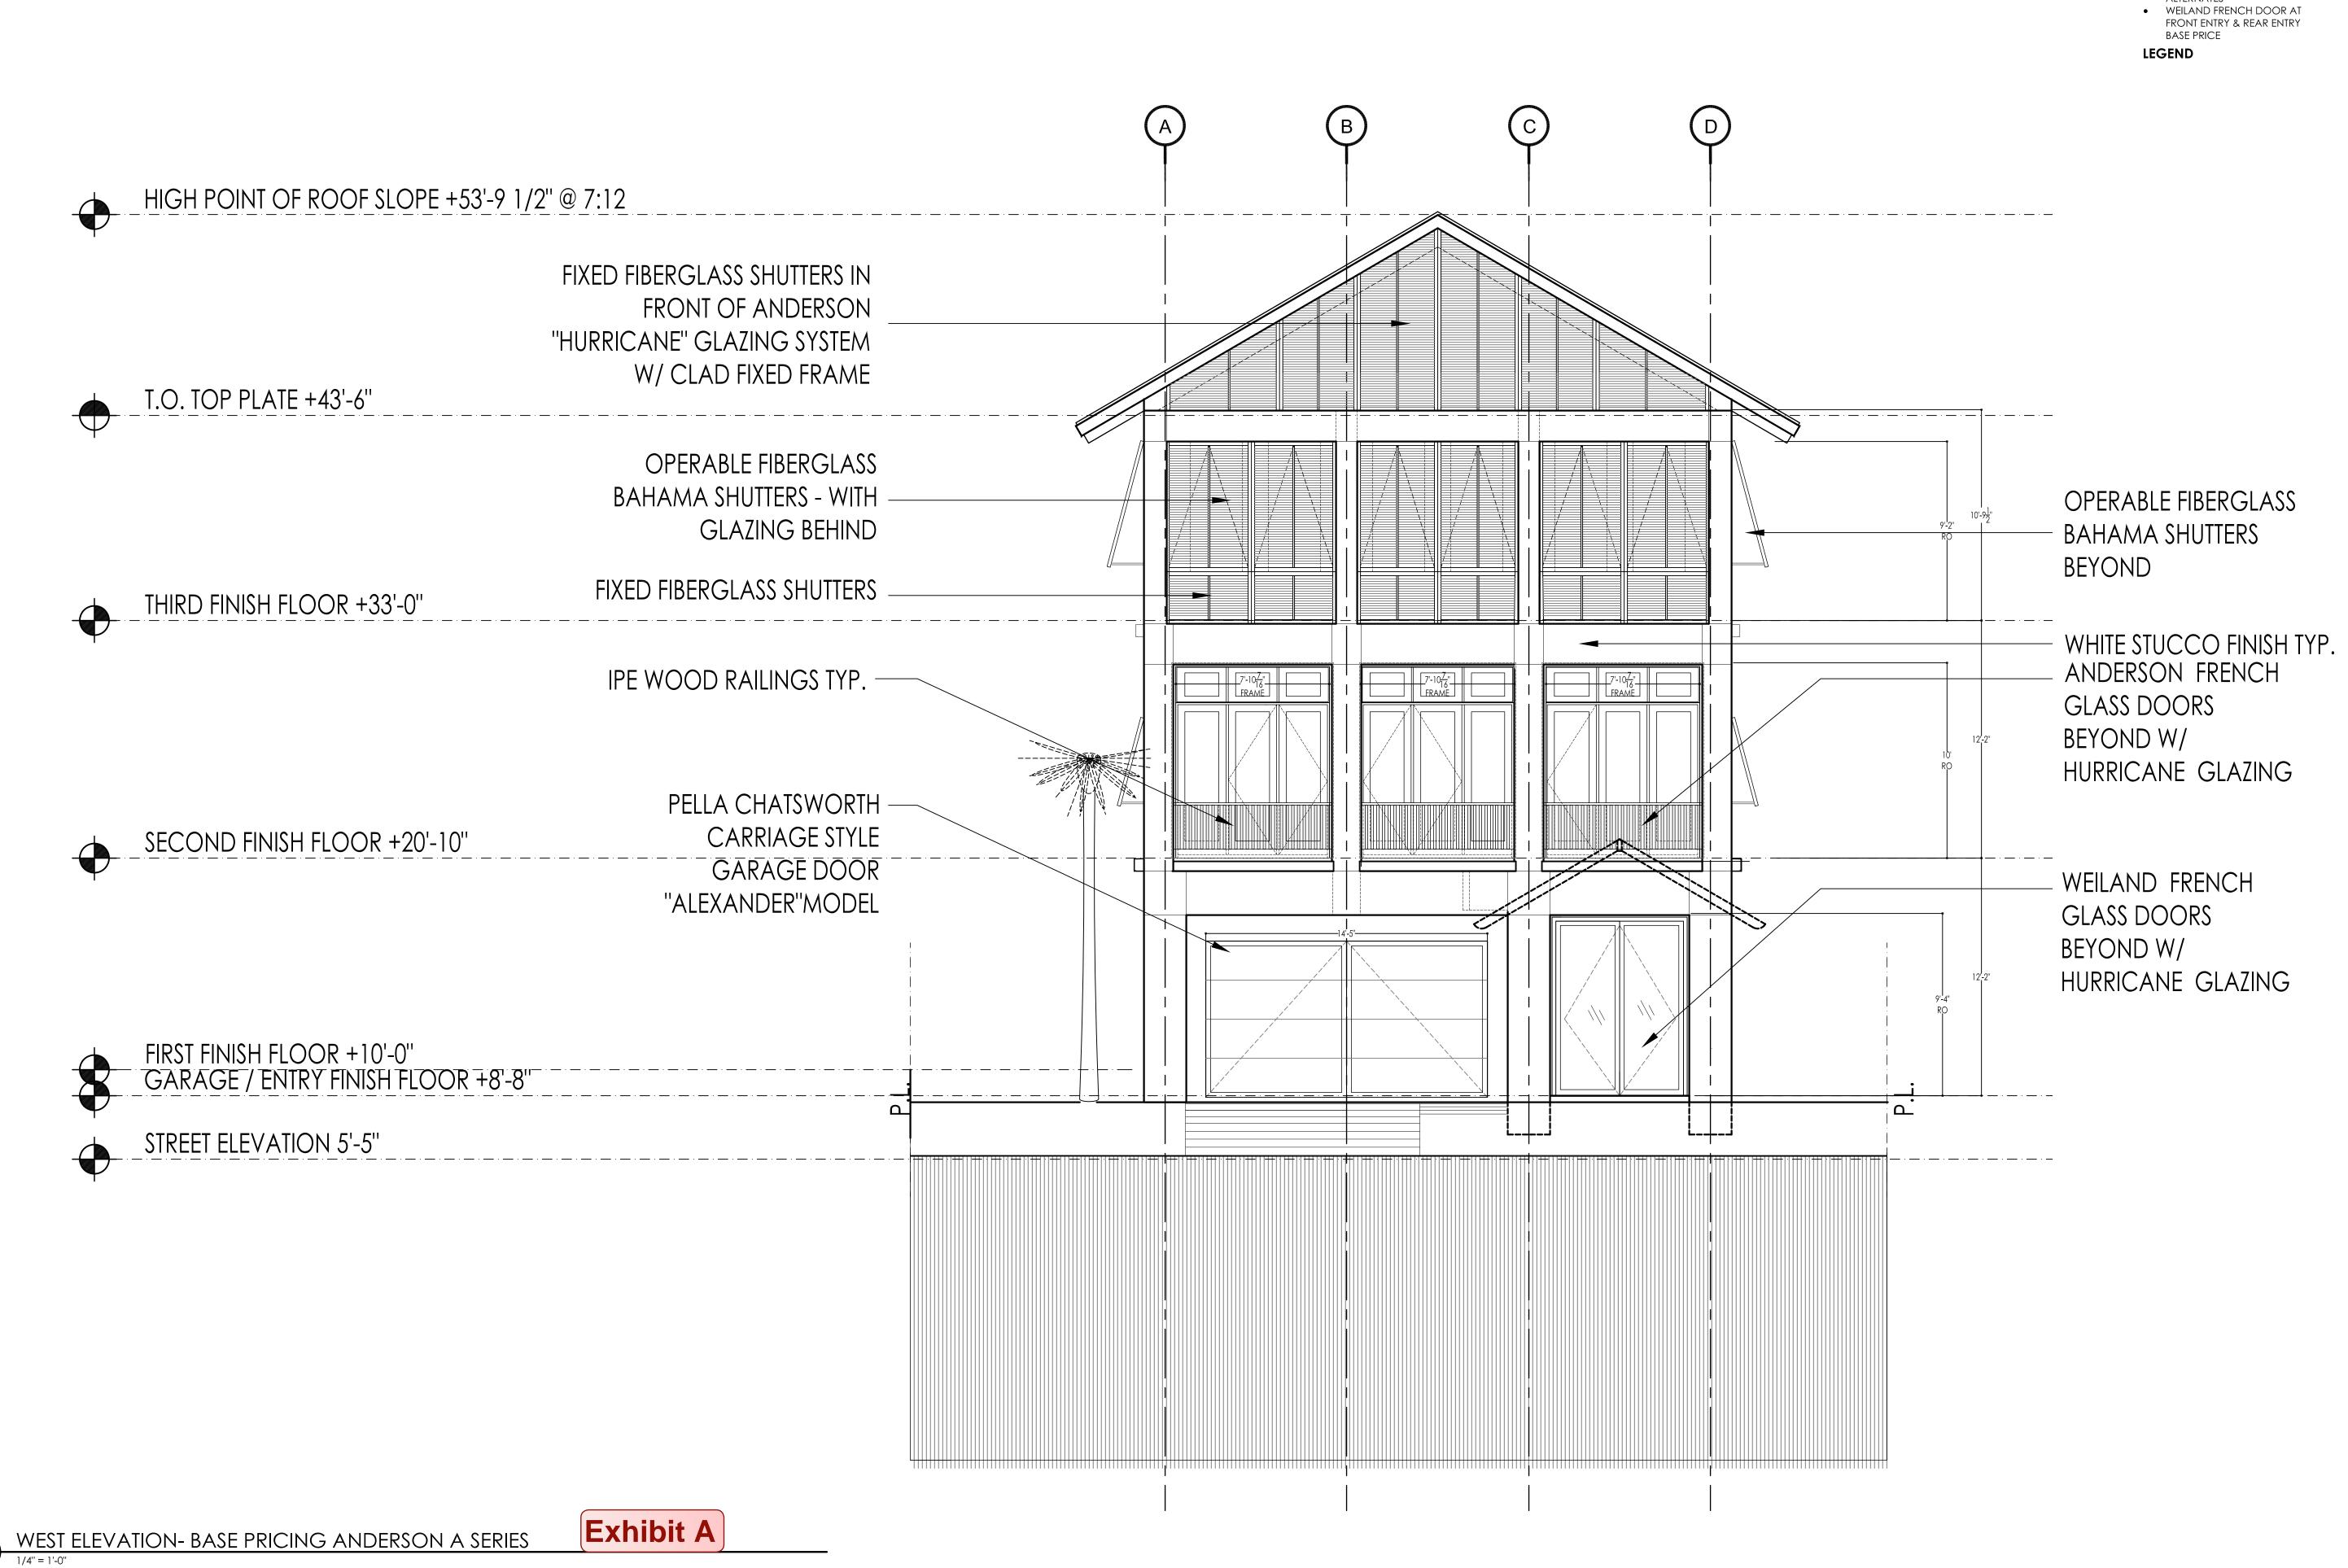

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EAST ELEVATION- WEILAND WINDOW ALTERNATE

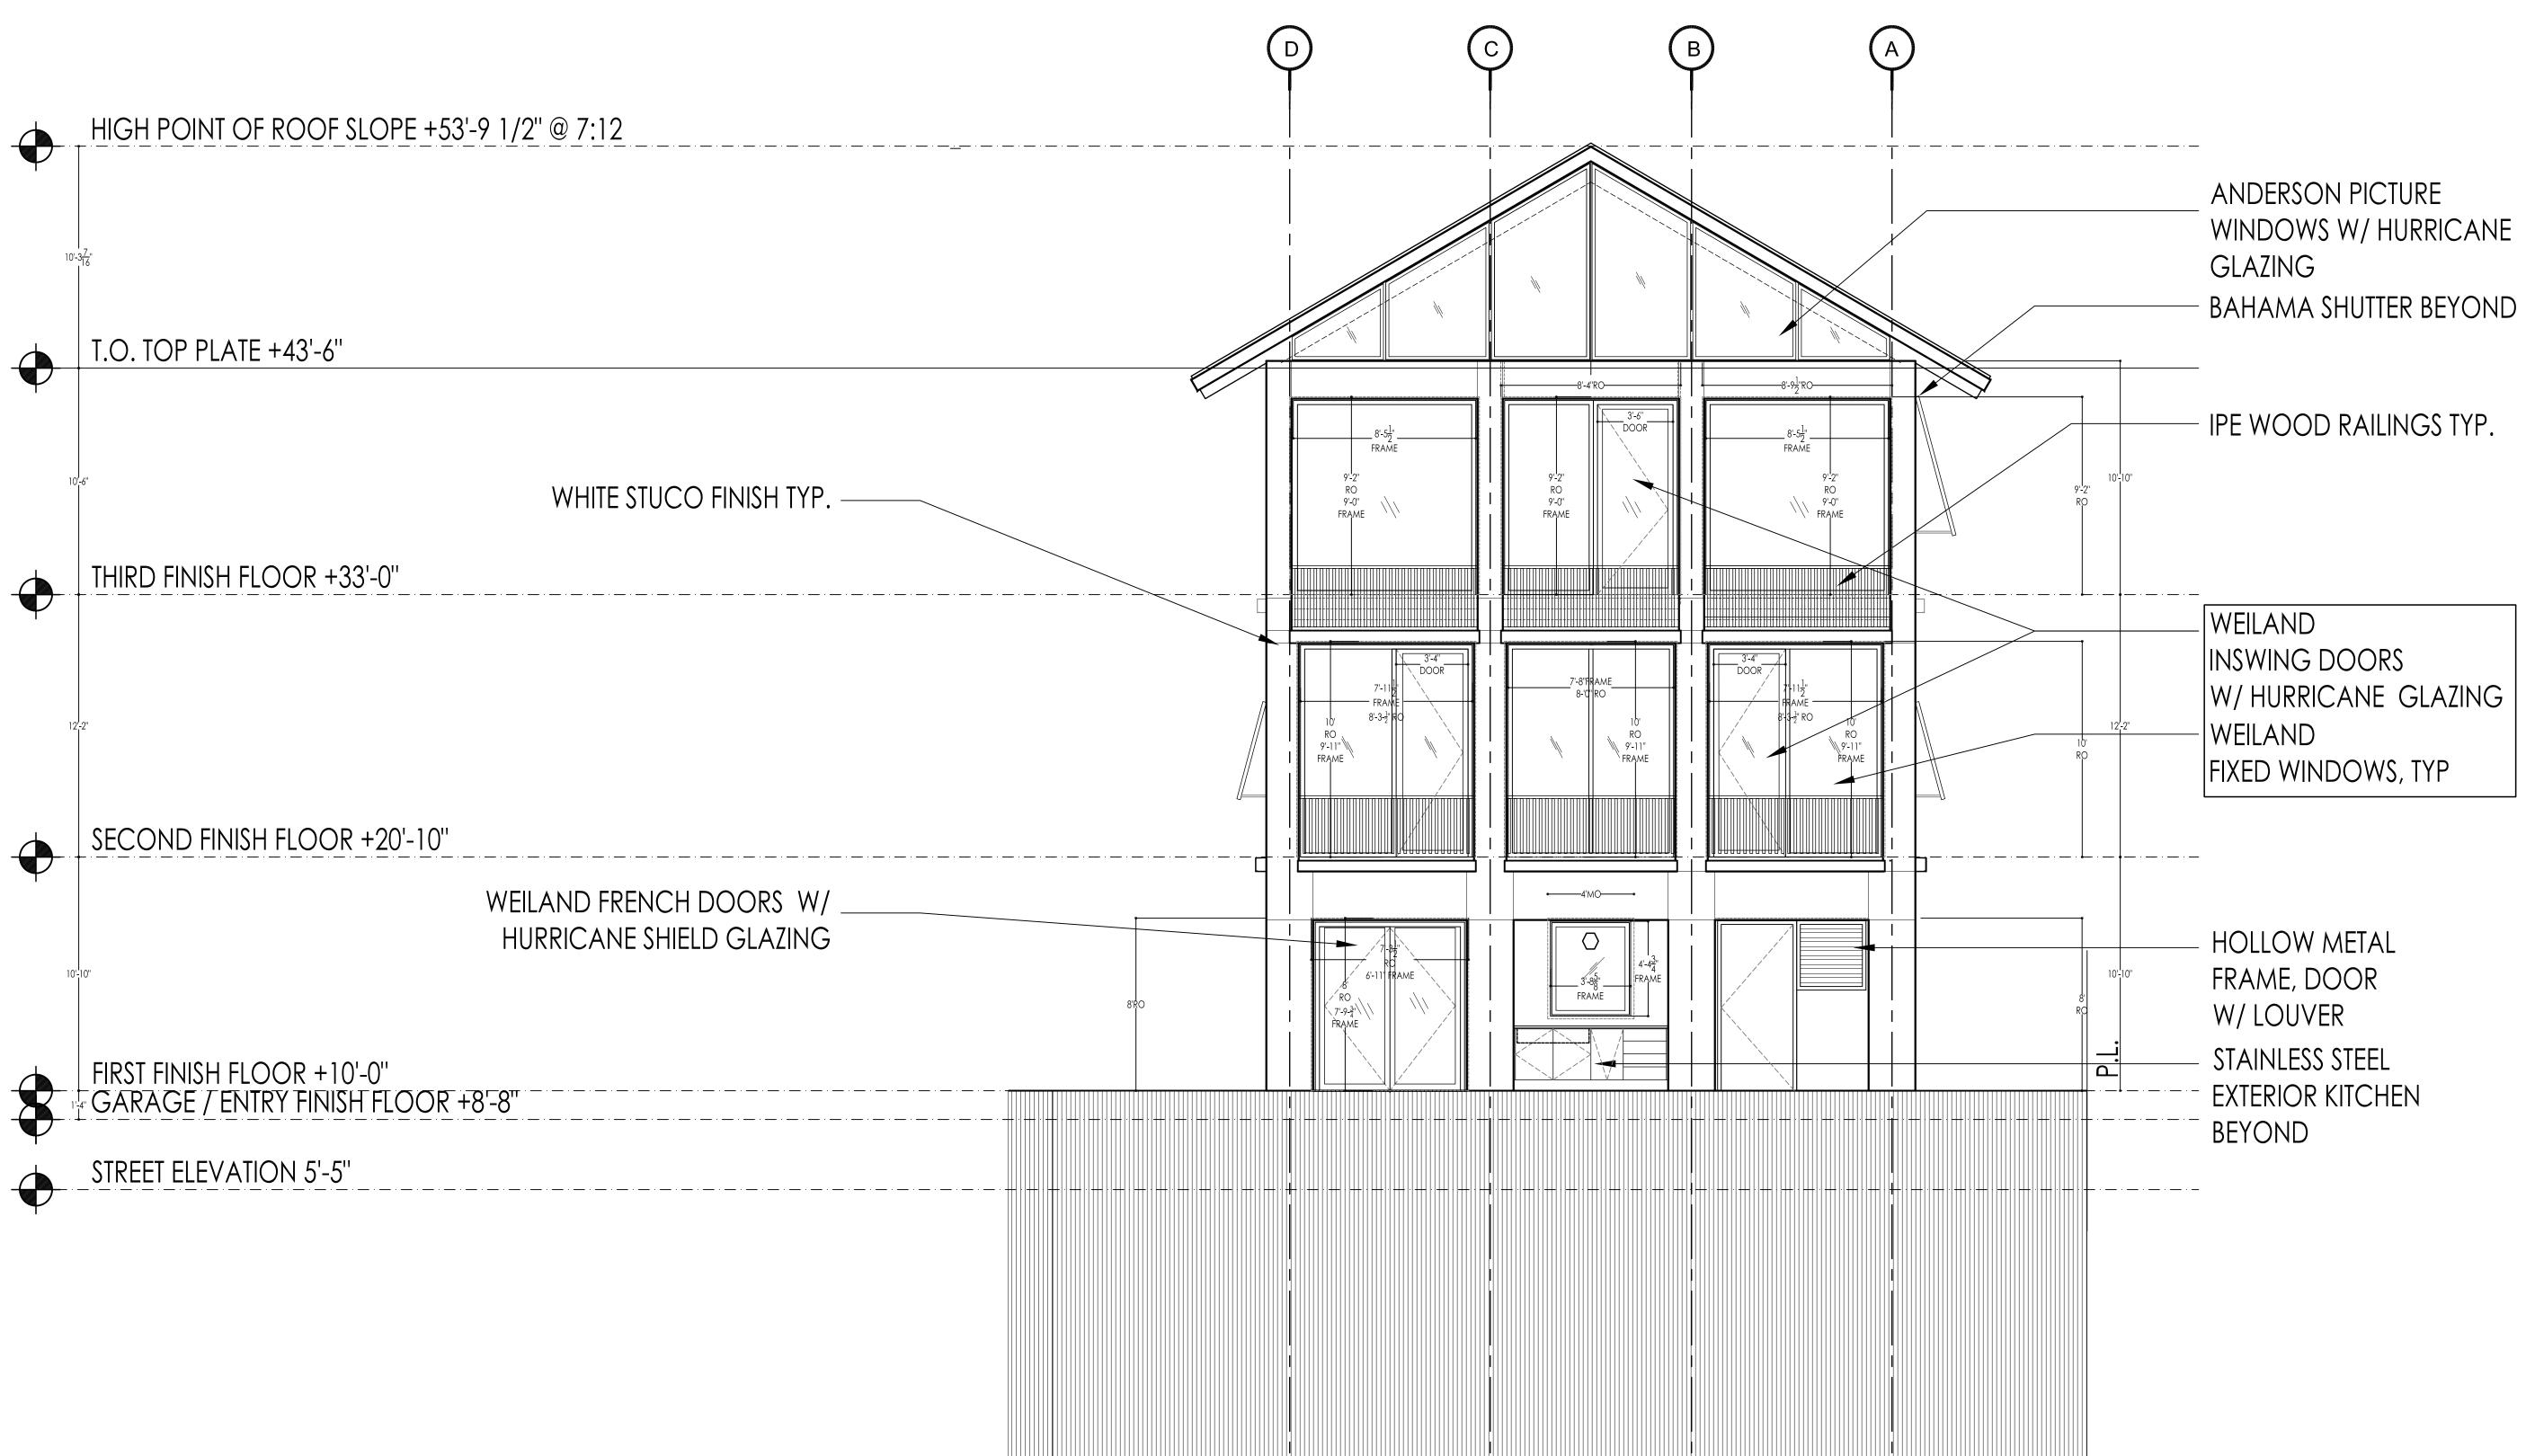Exhibit A

WEILAND ALTERNATE


A4.03.a



EAST ELEVATION- BASE PRICING ANDERSON A SERIES


Exhibit A


A4.03.b

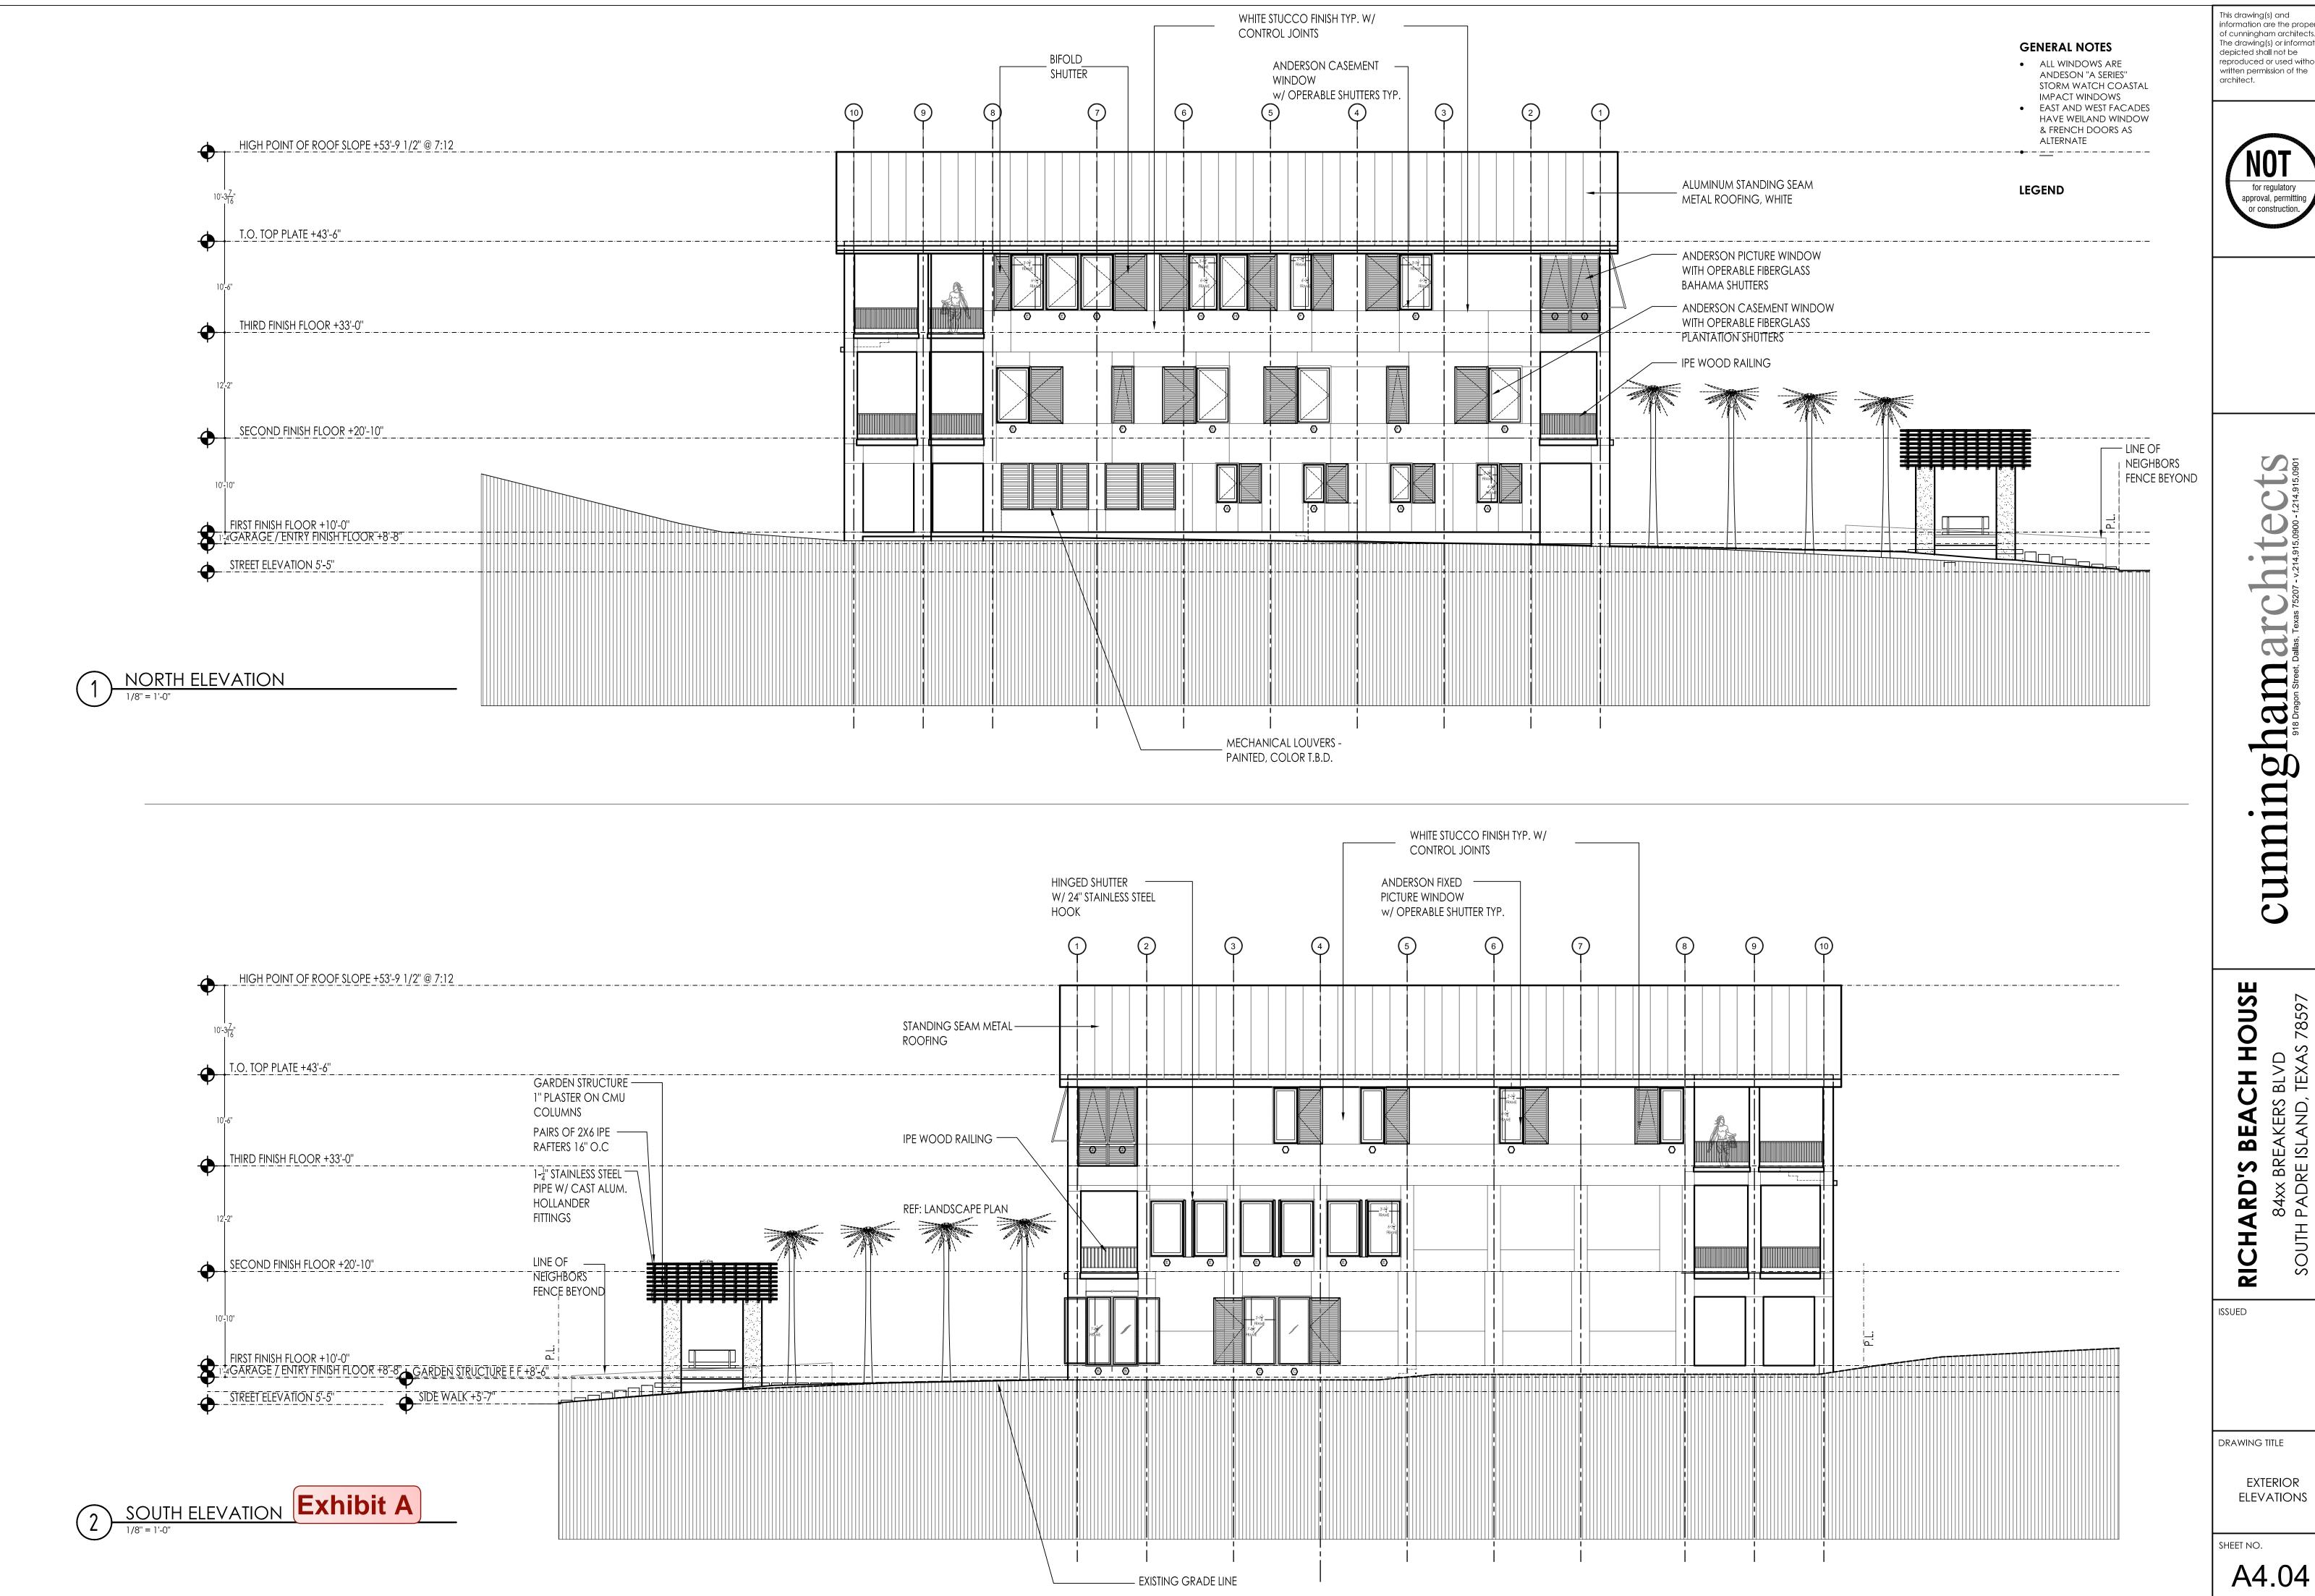


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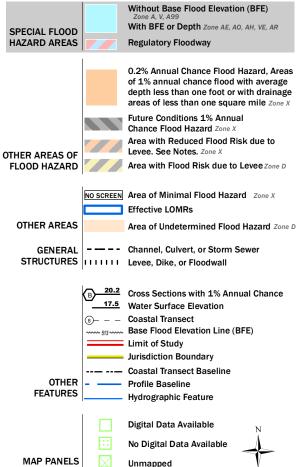
National Flood Hazard Layer FIRMette



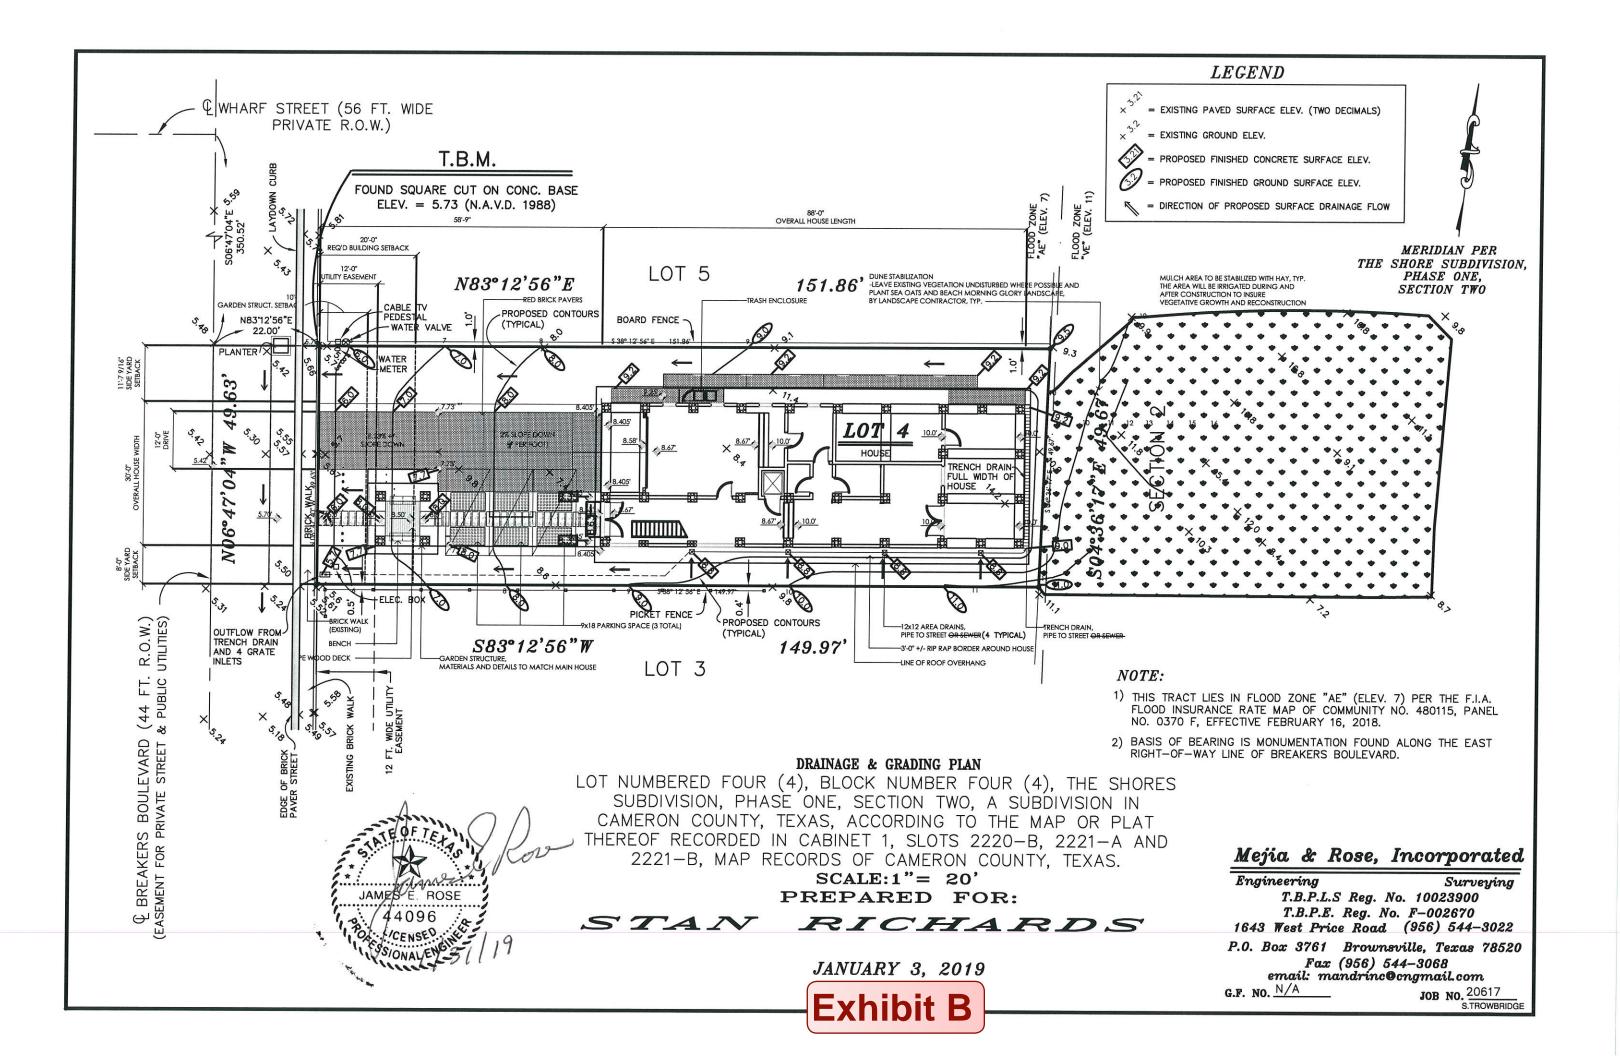

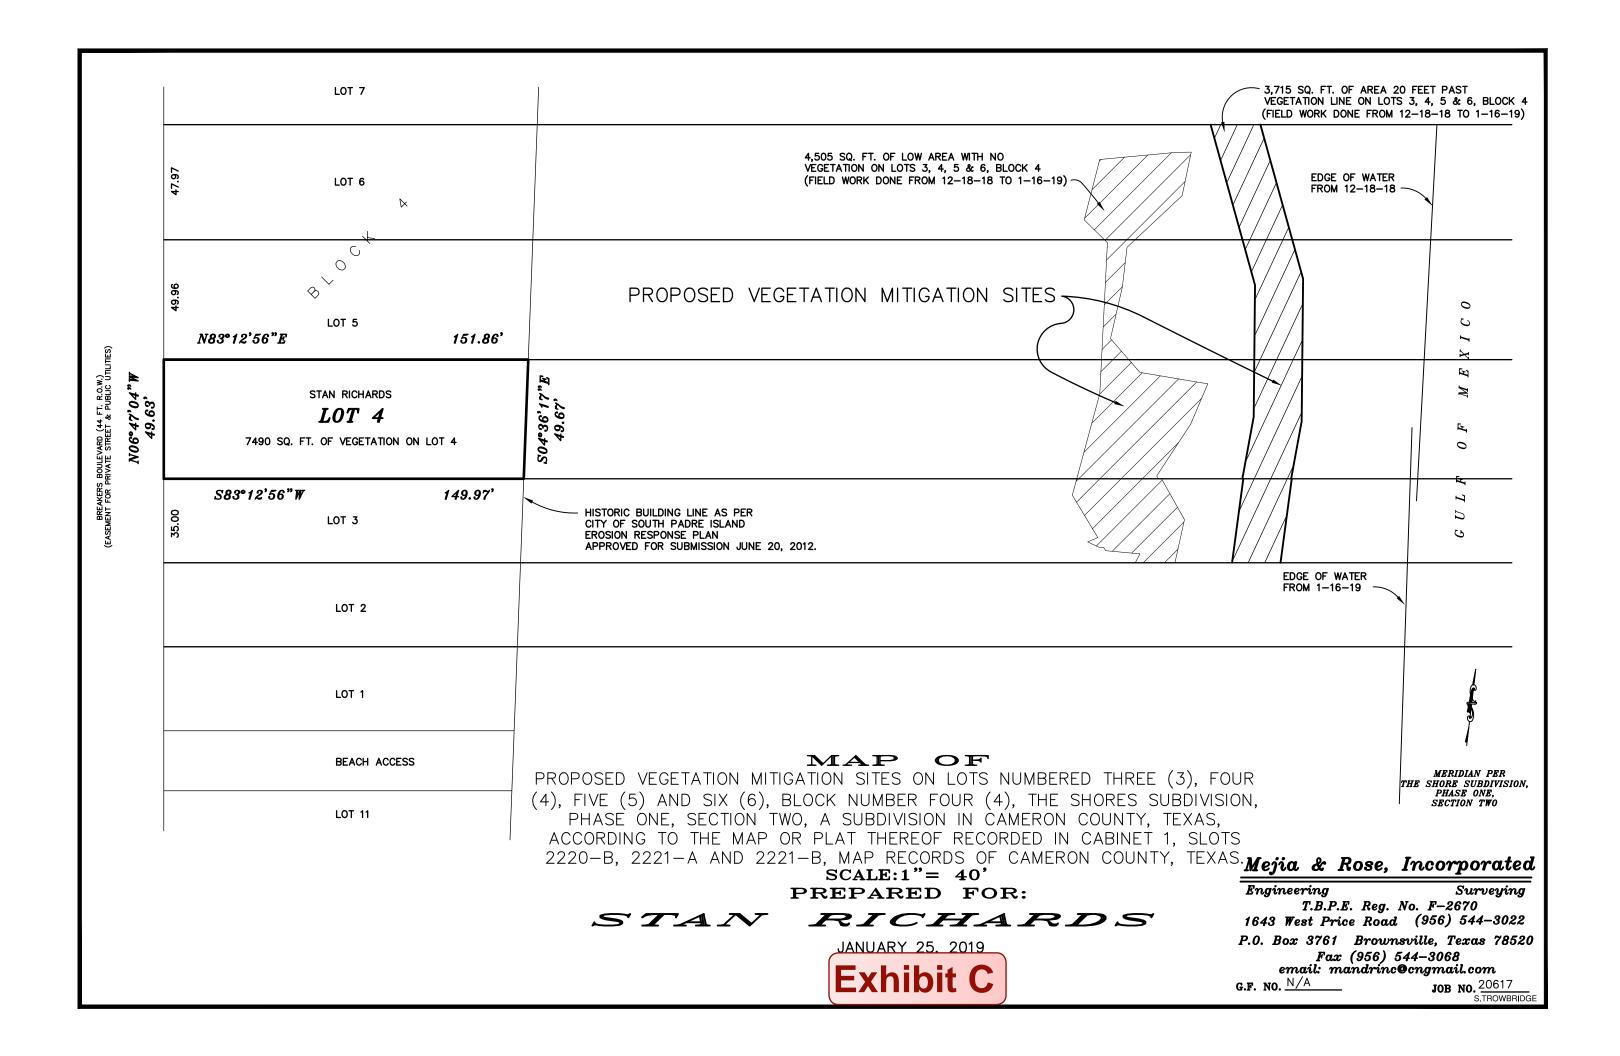Legend

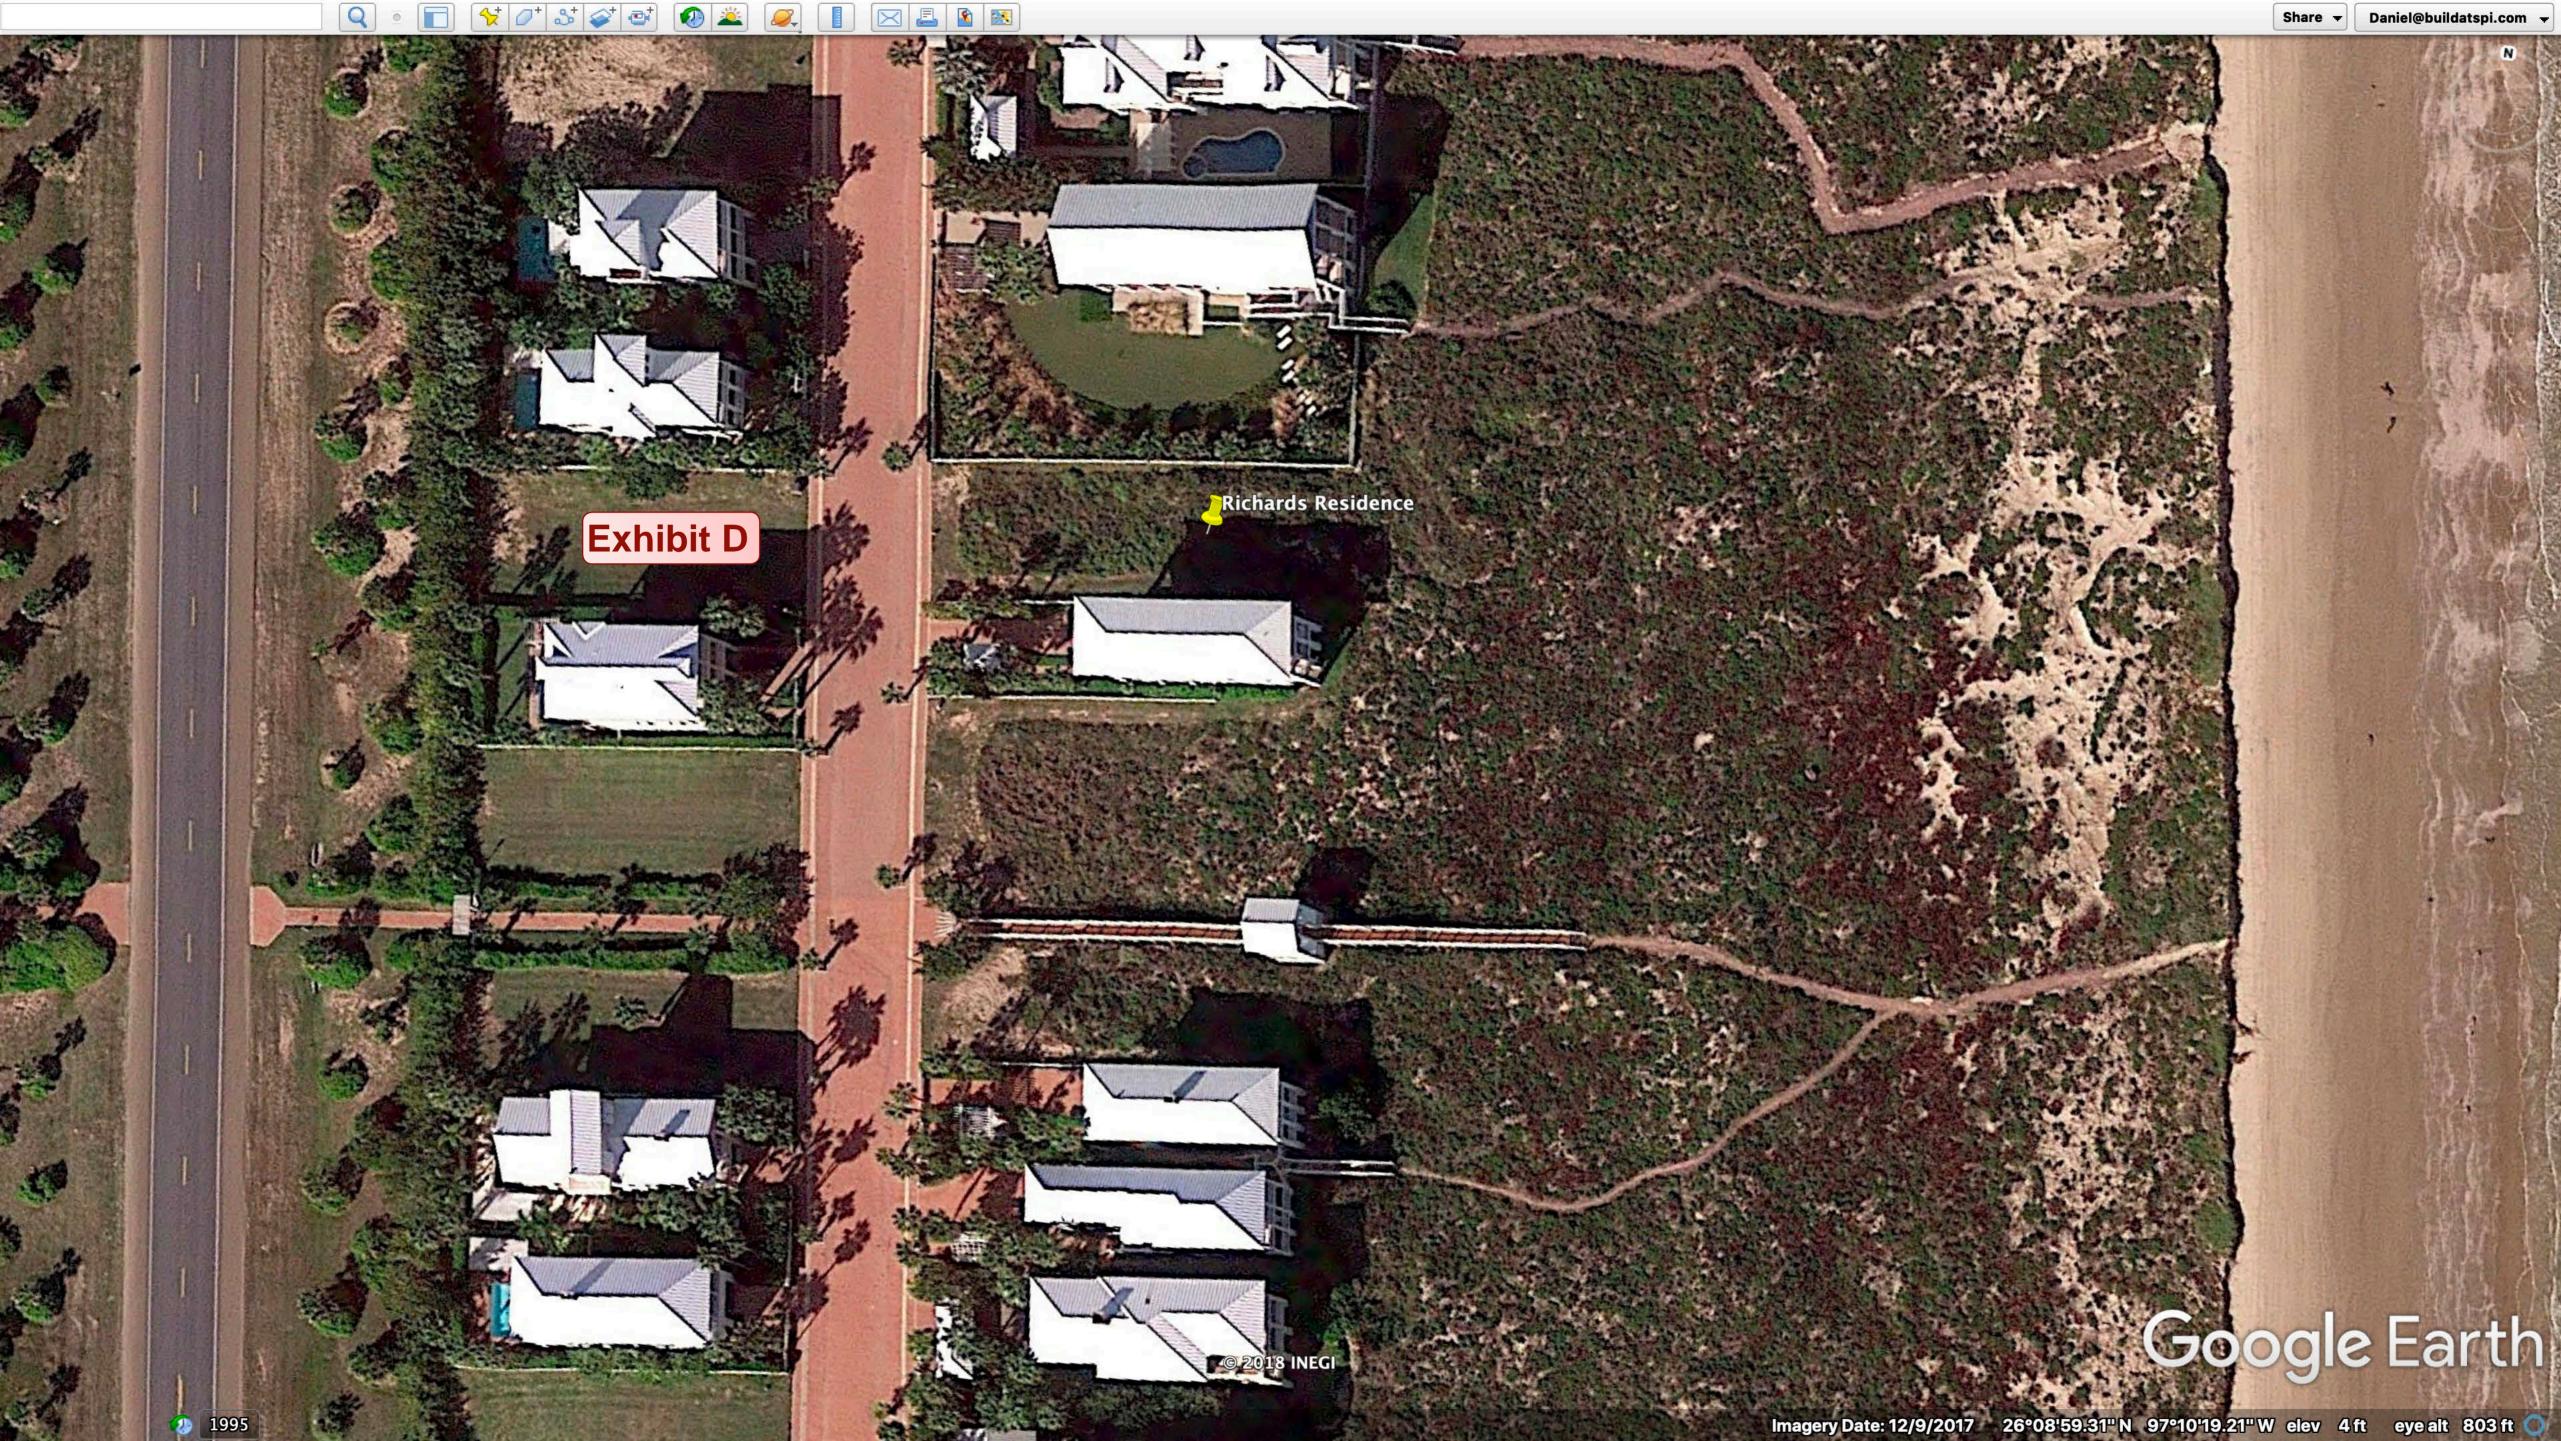SEE FIS REPORT FOR DETAILED LEGEND AND INDEX MAP FOR FIRM PANEL LAYOUT



This map complies with FEMA's standards for the use of digital flood maps if it is not void as described below. The basemap shown complies with FEMA's basemap

accuracy standards


The pin displayed on the map is an approximate point selected by the user and does not represent

an authoritative property location.

The flood hazard information is derived directly from the authoritative NFHL web services provided by FEMA. This map was exported on 2/8/2019 at 3:21:37 PM and does not reflect changes or amendments subsequent to this date and time. The NFHL and effective information may change or become superseded by new data over time.

This map image is void if the one or more of the following map elements do not appear: basemap imagery, flood zone labels, legend, scale bar, map creation date, community identifiers, FIRM panel number, and FIRM effective date. Map images for unmapped and unmodernized areas cannot be used for regulatory purposes.



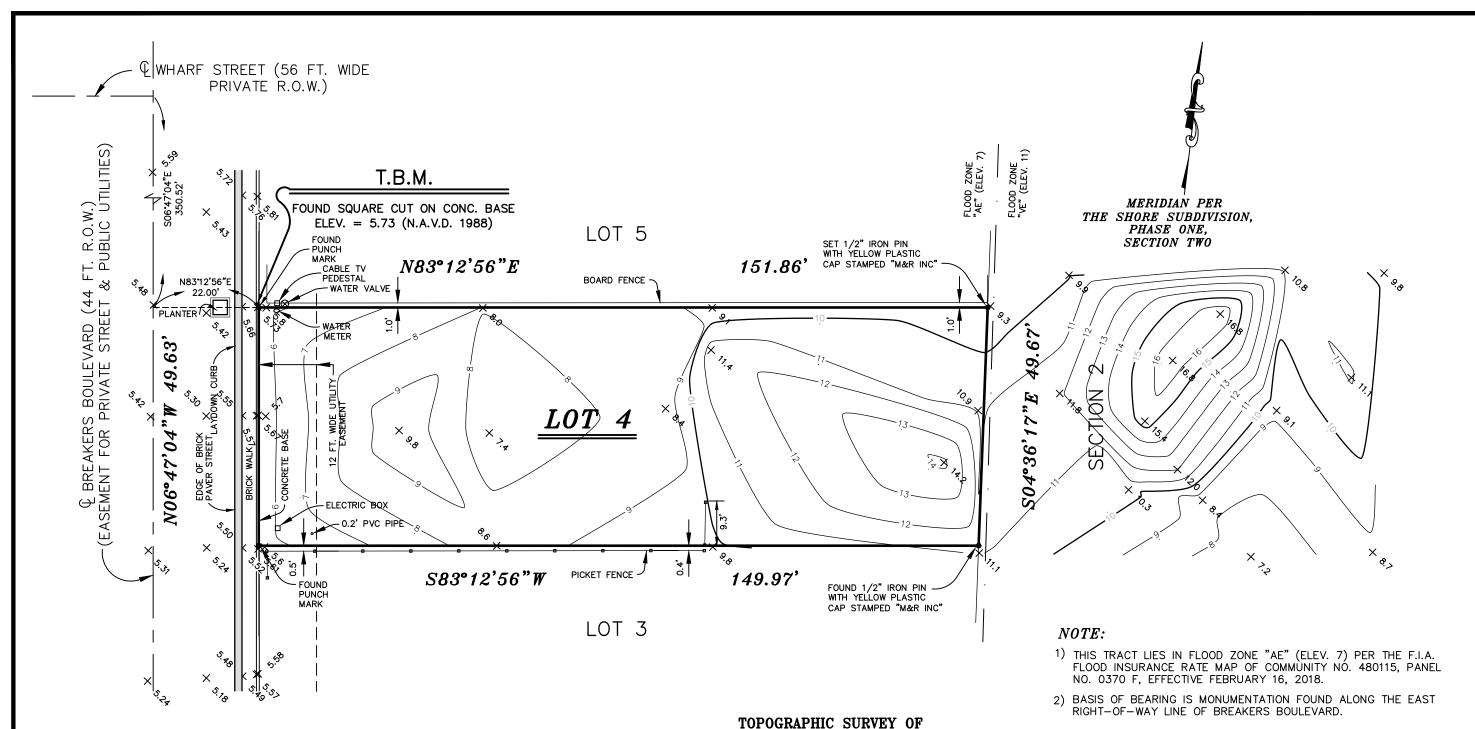

LOT NUMBERED FOUR (4), BLOCK NUMBER FOUR (4), THE SHORES SUBDIVISION, PHASE ONE, SECTION TWO, A SUBDIVISION IN CAMERON COUNTY, TEXAS, ACCORDING TO THE MAP OR PLAT THEREOF RECORDED IN CABINET 1, SLOTS 2220-B, 2221-A AND 2221-B, MAP RECORDS OF CAMERON COUNTY, TEXAS.

SCALE:1"= 20' SURVEYED FOR:

RICHARDS STAN

Exhibit G

Mejia & Rose, Incorporated

Engineering Surveying T.B.P.E. Reg. No. F-2670 1643 West Price Road (956) 544-3022 P.O. Box 3761 Brownsville, Texas 78520 Fax (956) 544-3068 email: mandrinc@cngmail.com G.F. NO. $\frac{N/A}{}$ JOB NO. 20536 S. TROWBRIDGI

REGISTERED PROFESSIONAL LAND SURVEYOR NO. 3900

CONTAINS NO ERASURES OR ADDITIONS.

The undersigned hereby certifies that the survey

on the ground are as shown; that there are no

visible encroachments, visible overlappings, apparent conflicts, or visible easements except as

shown hereon. THIS CERTIFICATION IS ONLY VALID

WITH AN ORIGINAL SIGNATURE AND IF THE DRAWING

_; that the only improvements

described hereon was made on the ground on

09-26-18

CITY OF SOUTH PADRE ISLAND CITY COUNCIL MEETING AGENDA REQUEST FORM

MEETING DATE:	April 9, 2019
NAME & TITLE:	Kristina Boburka, Interim Shoreline Director
DEPARTMENT:	Shoreline Department
ІТЕМ	
Discussion and action upon the Shoreline M	to select and move forward with potential projects and improvements based aster Plan.
ITEM BACKGROUND	
projects for each of th	xamined the Final Shoreline Master Plan and has compiled a list of potential e four goals outlined: Education, Tourism, Conservation, and Public Access. provides a way to select those projects that should proceed forward.
BUDGET/FINANCIAL	SUMMARY
None.	
dunes, wetlands, La sustainable use and er	
LEGAL REVIEW	
Sent to Legal: Approved by Legal: Comments:	YES: NO:X YES: NO:
RECOMMENDATIONS	S/COMMENTS

Authorize staff to proceed with selected projects.

Decision Matrix Averages			
Key Action/Amenity	Averaged Ranked Priority		
Education Liaison	6.8		
Activities Forum	8		
Classroom Space	6		
Dune Demonstration Garden	7		
Land Acquisition	8		
Beach Access	9		
Bayside Ramps (separate motorized and non- motorized)	8.6		
Beach Nourishment	9.4		
Dunes/Wetland Protection (Ch. 22/Morton study update), Regional Sediment Management	9.4		
Building Codes	7.2		
Access Walkovers	9		
Mobi-Mats	5.4		
Public Restrooms	9.2		
Portable Restroom Facilities	6.8		
Changing Rooms	2.8		
Showering Facilities	8.8		
Workout Stations	5.4		
Picnic Tables	4		
Bike Racks	5.8		
Paid Parking	5.6		

CITY OF SOUTH PADRE ISLAND CITY COUNCIL MEETING AGENDA REQUEST FORM

MEETING DATE:	April 9, 2019	
NAME & TITLE:	Kristina Boburka, Interim Shoreline D	Director
DEPARTMENT:	Shoreline Department	
ITEM		
Discussion and possib	ole action on dog water fountains at the	City's beach accesses.
ITEM BACKGROUND		
A community memb accesses.	per inquired about the possibility of	dog water fountains at some beach
BUDGET/FINANCIAL	SUMMARY	
None.		
COMPREHENSIVE PL Chapter III. Parks and		
GOAL 1: The City sh	all ensure protection and conservation	
	guna Madre waterfront and native faloryment by future generations.	lora and fauna, allowing for their
	and dunes shall be protected from both	natural and artificial erosion.
LEGAL REVIEW		
Sent to Legal: Approved by Legal: Comments:	YES:	NO:X NO:

RECOMMENDATIONS/COMMENTS

Authorize staff to proceed.

Elkay LK4420DB Tubular ADA Drinking Fountain with Dog Bowl



OUR PRICE: From \$3,602.72 to \$3,670.44


Product Options

Color: Select Color ▼

Quantity: 1 ADD TO CART

Recommend 0

FREE SHIPPING ■ □ □

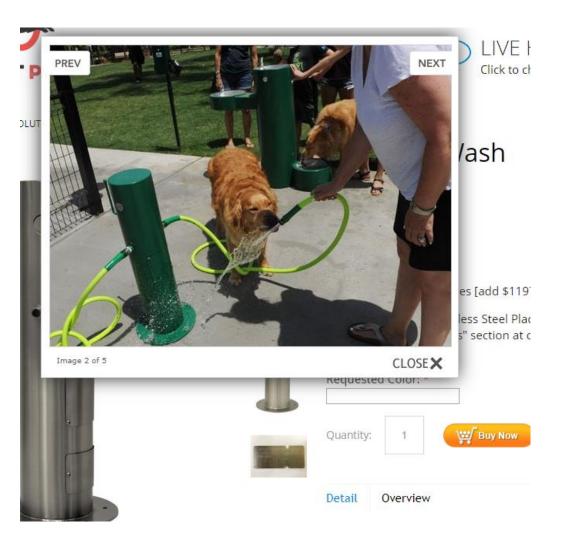





Pet Fountain - Free Standing



\$1,045.00



Freeze Resistant Valves [add \$786.00]

Requested Fountain Color: *

Quantity:



Detail

Overview



#3 Best Seller in Water Fountains

\$2,492.00 **\$2,165.00**

SKU: 648wf350

Request our Catalog - \$100 Coupo

You Save: \$327.00 (13.12%)

- Pedestals are fabricated from stainless ste
- Spout is locked to stainless steel receptors protected with vandal resistant steel guard
- Recessed self-closing push button valve(s) outside stream adjustment
- Slow draining pet fountain receptor with pe guard drain
- Stainless Steel
- Surface type with mounting plate welded to

CITY OF SOUTH PADRE ISLAND CITY COUNCIL MEETING AGENDA REQUEST FORM

MEETING DATE:	April 9, 2019	
NAME & TITLE:	Kristina Boburka, Interim Shoreline	Director
DEPARTMENT:	Shoreline Department	
ITEM		
Discussion and possib protected.	ole action on improvements to ensure	e our beach and dune ecosystem is well
ITEM BACKGROUND		
BUDGET/FINANCIAL None.	SUMMARY	
None.		
COMPREHENSIVE PL	AN GOAL	
Chapter III. Parks and	l Resources	
		n of natural resources, such as beaches,
		flora and fauna, allowing for their
	njoyment by future generations.	_
Objective 1.1 Beach a	and dunes shall be protected from bot	h natural and artificial erosion.
LEGAL REVIEW		
Sont to Logal:	VEC.	NO: V
Sent to Legal: Approved by Legal:	YES: YES:	NO:X NO:
Comments:	1 Ly	110.

RECOMMENDATIONS/COMMENTS

Authorize staff to proceed.

CITY OF SOUTH PADRE ISLAND CITY COUNCIL MEETING AGENDA REQUEST FORM

MEETING DATE:	April 9, 2019				
NAME & TITLE:	Kristina Boburka, Ir	nterim Shoreline	Director		
DEPARTMENT:	Shoreline Departme	nt			
ITEM					
Discussion on Mobi-l	Mat maintenance.				
ITEM BACKGROUND					
dunes, wetlands, La sustainable use and en	AN GOAL I Resources all ensure protection guna Madre waterfr njoyment by future ge	ont and native enerations.	flora ar	ral resources, such as beach nd fauna, allowing for th and artificial erosion.	
LEGAL REVIEW	VEC		NO.	V	
Sent to Legal: Approved by Legal: Comments:	YES: YES:		NO:	X	
RECOMMENDATION	S/COMMENTS				

Authorize staff to proceed.

Monthly Mobi-Mat Maintenance							
Beach Access	ach Access Week 1 Week 2 Week 3 Week						
1	Х						
3	X						
4	Х						
5	Χ						
8		X					
9		X					
10		X					
11		X					
12			X				
13			X				
14			X				
15			X				
16				Χ			
17				X			
23				X			
24				X			
25				Х			

^{*}This is in addition to the daily maintenance that takes place in the morning and afternoon