NOTICE OF DEVELOPMENT STANDARDS REVIEW TASK FORCE REGULAR MEETING CITY OF SOUTH PADRE ISLAND

TUESDAY, NOVEMBER 10, 2020

10:00 AM AT THE MUNICIPAL BUILDING, CITY COUNCIL CHAMBERS, 2ND FLOOR 4601 PADRE BOULEVARD, SOUTH PADRE ISLAND, TX

- 1. Call to Order
- 2. Pledge of Allegiance
- 3. Public Comments and Announcements

This is an opportunity for citizens to speak to the Task Force relating to agenda or non-agenda items. Speakers are required to address the Task Force at the podium and give their name before addressing their concerns. [Note: State law will not permit the Task Force to discuss, debate or consider items that are not on the agenda. Citizen comments may be referred to City Staff or may be placed on the agenda of a future Development Standards Review Task Force meeting [

- 4. Regular Agenda
 - 4.1 Approve minutes of August 11, 2020 Regular Meeting.
 - 4.2. Approve minutes of September 9, 2020 Workshop Meeting.
 - 4.3. Discussion and action on a request by AT&T Mobility to install a wood utility pole and antenna for cellular network on the City's right of way. (W. Pike St)
- 5. Adjourn

NOTE: One or more members of the City of South Padre Island City Council may attend this meeting; if so, this statement satisfies the requirements of the OPEN MEETINGS ACT.

DATED THIS THE 6TH DAY OF NOVEMBER 2020

I, THE UNDERSIGNED AUTHORITY, DO HEREBY CERTIFY THAT THE ABOVE NOTICE OF MEETING OF THE DEVELOPMENT STANDARDS REVIEW TASK FORCE OF THE CITY OF SOUTH PADRE ISLAND, TEXAS IS A TRUE AND CORRECT COPY OF SAID NOTICE AND THAT I POSTED A TRUE AND CORRECT COPY OF SAID NOTICE ON THE BULLETIN BOARD AT CITY HALL/MUNICIPAL BUILDING ON NOVEMBER 6, 2020, AT/OR BEFORE 5:00 PM

Angelia Soto, Ott

SAID MEETING.

Angeliant Soto City Secretary

THIS FACILITY IS WHEELCHAIR ACCESSIBLE, AND ACCESSIBLE PARKING SPACES ARE AVAILABLE. REQUESTS FOR ACCOMMODATIONS OR INTERPRETIVE SERVICES MUST BE MADE 48 HOURS PRIOR TO THIS MEETING. PLEASE CONTACT BUILDING OFFICIAL, BELINDA TARVER AT (956)761-8103.

AND REMAINED SO POSTED CONTINUOUSLY FOR AT LEAST 72 HOURS PRECEDING THE SCHEDULED TIME OF

Agenda: NOVEMBER 10, 2020

CITY OF SOUTH PADRE ISLAND DEVELOPMENT STANDARDS REVIEW TASK FORCE AGENDA REQUEST FORM

MEETING DATE: November 10, 2020

NAME & TITLE: Marta Martinez

DEPARTMENT: Planning/Parks & Rec. Department

ITEM

Approve minutes of August 11, 2020 Regular Meeting.

ITEM BACKGROUND

Approve August 11, 2020 Regular Meeting minutes.

BUDGET/FINANCIAL SUMMARY

N/A

COMPREHENSIVE PLAN GOAL

N/A

LEGAL REVIEW

Sent to Legal: No

Approved by Legal: No

RECOMMENDATIONS/COMMENTS:

MEETING MINUTES CITY OF SOUTH PADRE ISLAND DEVELOPMENT STANDARDS REVIEW TASK FORCE

TUESDAY, AUGUST 11, 2020

1. CALL TO ORDER

The Development Standards Review Task Force Members of the City of South Padre Island, Texas held a Regular Meeting on Tuesday, August 11, 2020 at the Municipal Complex Building, 2nd Floor, 4601 Padre Boulevard, South Padre Island, Texas. Chairman Gardner Treharne called the meeting to order at 10:00 a.m. A quorum was present: Task Force Member Charles Fox, and Gary Johnson. Member with an excused absence was Gabriel Vanounou.

City staff members present were: City Manager Randy Smith, Public Works Director Alex Sanchez, Building Official Belinda Tarver, and Administrative Assistant Marta Martinez. Also present was Council Member Ken Medders.

2. PLEDGE OF

Chairman Treharne led the Pledge of Allegiance.

3. PUBLIC COMMENTS AND ANNOUNCEMENTS.

None.

4. REGULAR AGENDA

4.1 APPROVE MINUTES OF JUNE 9, 2020 REGULAR MEETING.

Chairman Treharne made a motion, seconded by Task Force Member Fox to approve the minutes as submitted. Motion carried unanimously.

4.2 DISCUSSION AND ACTION REGARDING A BLANKET APPROVAL FOR THE CITY-SPONSORED ART SEA TURTLES TO BE PLACED ON PRIVATE PROPERTIES.

Event Development & Packaging Manager Marisa Amaya gave a brief presentation regarding the proposed city sponsored art sea Turtle Trail to be placed on private properties. After some discussion Chairman Treharne made a motion, seconded by Task Force Member Johnson to approve a blanket City sponsored Sea Turtle Art Trail to be placed on private properties. The motion carried unanimously.

4.3 DISCUSSION AND ACTION REGARDING PROPOSED LOCATION OF A PUBLIC ART AT 904 PADRE BLVD. (LOT 1 PAVILACK SUBDIVISION)

Property owner Zeev Tafel is requesting approval to add a whale at the entrance of his building located at 904 Padre Blvd. After some discussion Chairman Treharne made a motion, seconded by Task Force Member Johnson to deny the request until further guidance from the City. The motion carried unanimously.

4.4 DISCUSSION AND ACTION REGARDING PROPOSED LOCATION OF A PUBLIC ART AT 1601 PADRE BLVD. (LOT 1 BLOCK 7 SUNNY ISLE SUBDIVISION)

Property owner Menny Amoyal stated that he will wait for the Task Force to get further guidance form the City. Task Force Member Johnson made a motion, seconded by Task Force Member Fox to deny the request of public art. The motion carried unanimously.

4.5 DISCUSSION AND ACTION REGARDING PROPOSED LOCATION OF A PUBLIC ART AT 1414 PADRE BLVD. (LOT 12 BLOCK 4 HAAS SUBDIVISION)

Property owner Eyal Turgeman is requesting approval of public art to be located at 1414 Padre Blvd. After some discussion Task Force Member Johnson made a motion, seconded by Task Force Member Fox to deny the request of public art. The motion carried unanimously.

4.6 DISCUSSION AND ACTION REGARDING PROPOSED LOCATION OF A PUBLIC ART AT 3900 PADRE BLVD. (LOT 1 BLOCKS 104 & 107 SECTIONS VII & VIII PADRE BEACH SUBDIVISION)

Task Force Member Fox made a motion, seconded by Task Force Member Johnson to deny the request of public art. The motion carried unanimously.

4.7 DISCUSSION AND ACTION REGARDING PROPOSED GRAPHIC ON THE FRONT WALL OF THE JAWS BUILDING LOCATED AT 815 PADRE BLVD. (PADRE BEACH ACRES TRACT 4)

Task Force Member Johnson made a motion, seconded by Task Force Member Fox to deny the request of mural art. The motion carried unanimously.

4.8 DISCUSSION AND ACTION REGARDING PROPOSED GRAPHIC ON THE FRONT WALL OF THE ISLAND FUN PARK BUILDING LOCATED AT 1201 PADRE BLVD.

Property owner Doyle Wells is requesting approval to paint the front of his building with multiple colors to be located at 1201 Padre Blvd. After some discussion Chairman Treharne made a motion to deny. The motion died due to the lack of seconded. Task Force Member Fox made a motion, seconded by Task Force Member Johnson to approve the request of mural art as submitted. The motion passed on a 2:1 vote. Gardner Treharne voted against.

There being no further business, Chairman Tre	harne adjourned the meeting at 10:56
Marta Martinez Administrative Assistant	Gardner Treharne, Chairman

5.

ADJOURN.

CITY OF SOUTH PADRE ISLAND DEVELOPMENT STANDARDS REVIEW TASK FORCE AGENDA REQUEST FORM

MEETING DATE: November 10, 2020

NAME & TITLE: Marta Martinez

DEPARTMENT: Planning/Parks & Rec. Department

ITEM

Approve minutes of September 9, 2020 Workshop Meeting.

ITEM BACKGROUND

Approve Workshop minutes of September 9, 2020 Meeting.

BUDGET/FINANCIAL SUMMARY

N/A

COMPREHENSIVE PLAN GOAL

N/A

LEGAL REVIEW

Sent to Legal: No

Approved by Legal: No

RECOMMENDATIONS/COMMENTS:

WORKSHOP MEETING MINUTES CITY OF SOUTH PADRE ISLAND DEVELOPMENT STANDARDS REVIEW TASK FORCE

WEDNESDAY, SEPTEMBER 9, 2020

1. CALL TO ORDER

The Development Standards Review Task Force Members of the City of South Padre Island, Texas held a Workshop Meeting on Wednesday, September 9, 2020 at the Municipal Complex Building, 2nd Floor, 4601 Padre Boulevard, South Padre Island, Texas. Chairman Gardner Treharne called the meeting to order at 10:00 a.m. A quorum was present: Task Force Member Charles Fox, Gabriel Vanounou, and Gary Johnson.

City staff members present were: City Manager Randy Smith, Director of Operations in City Manager's Office Wendi Delgado, City Secretary Angelique Soto, City Attorney Ed Cyganiewicz, Public Works Director Alex Sanchez, Building Official Belinda Tarver, and Administrative Assistant Marta Martinez.

2. PLEDGE OF

Chairman Treharne led the Pledge of Allegiance.

3. PUBLIC COMMENTS AND ANNOUNCEMENTS.

Public comments were given at this time.

4. REGULAR AGENDA

4.2 DISCUSSION REGARDING CHAPTER 15 SIGNS, ART IN PUBLIC SPACES, COMMERCIAL ART, AND RELATED ISSUES.

Chairman Treharne opened up the item up for discussion by the Task Force. The Task Force Members expressed there concerns regarding art in public spaces regarding oversized sculptures. After much discussion regarding the size of a structure Chairman suggested the minimum of eight (8) feet in height, three (3) feet wide, and three (3) feet in depth. Task Force Member Vanounou also suggested to add and/or a total of twenty-four (24) square feet structure. Task Force Member Johnson suggested for the structures to be unattached to a building. Also, suggested if someone requests a structure to be attached to a building the Development Standards Review Task Force would need to review the request for approval on a case by case basis. City Attorney Cyganiewicz stated that he will draft up an ordinance for the Task Force to review. The Task Force scheduled a special meeting to be held in two weeks. No action was taken.

5. ADJOURN. There being no further business, Chairman Treharne adjourned the meeting at 11:05 a.m.

Gardner Treharne, Chairman

Marta Martinez, Administrative Assistant

CITY OF SOUTH PADRE ISLAND DEVELOPMENT STANDARDS REVIEW TASK FORCE AGENDA REQUEST FORM

MEETING DATE: November 10, 2020

NAME & TITLE: Alex Sanchez, Public Works Director

DEPARTMENT: Planning/Parks & Rec. Department

ITEM

Discussion and action on a request by AT&T Mobility to install a wood utility pole and antenna for cellular network on the City's right of way. (W. Pike St)

ITEM BACKGROUND

The applicant is requesting permission to install a new freestanding wood utility pole for AT&T Mobility with proposed backhaul transport equipment and antenna for network densification.

Padre Boulevard and Entertainment District Code Table 5.1 - Schedule of Uses (Land Use) Antennas including cell, accessory, and mounted on top of building is permitted as an accessory use with design criteria per Table 5.2 on Padre Boulevard South.

Padre Boulevard and Entertainment District code Table 5.2 - Use Criteria Antennas including cell, accessory and mounted (Excluded from this category are freestanding and commercial antennas and equipment buildings) 1. Antennas shall be permitted on rooftops, 2. Antennas shall be screened entirely with a screen of same color as the principal building; and 3. Antennas shall not be visible from adjacent Pedestrian Priority Street.

BUDGET/FINANCIAL SUMMARY

N/A

COMPREHENSIVE PLAN GOAL

N/A

LEGAL REVIEW

Sent to Legal: No Approved by Legal: No

RECOMMENDATIONS/COMMENTS:

PADRE BOULEVARD AND ENTERTAINMENT DISTRICT CODE

Table 5.1 – Schedule of Uses (Land Use)

Table 5.1 – Scriedule	01 0363 (1	and Osej						
Character	Bayfront	Entertainment District Core	Neighborhood Crossing	Town Center Crossing	Padre Boulevard North/Central	Padre Boulevard South	Neighborhood Transition	Northern Resort District
Commercial Uses (Office, Retail, Re	estaurant, Sal	es and Service	e Uses)	•				
Retail Sales with no drive through facility (includes alcohol sales; bicycle, vehicle, and water sport sales & rental; general merchandise; pharmacy; cigarette & cigar sales; hardware stores, etc.)	P	Р	P	Р	Р	Р	NP	Р
Excluded from this category are retail sales and service establishments geared towards the automobile. Head Shop (a retail outlet with the sale of paraphernalia related to the consumption of cannabis, other recreational drugs and/or new age herbs. Products typically include but are not limited to, water pipes, bongs, roach clips, pipes, rolling papers, rolling machines, and whipped cream chargers containing nitrous oxide.)	NP	NP	NP	NP	NP	SE	NP	NP
Auto-related Sales or Service establishments (includes gasoline sales)	NP	NP	P/C	P/C	P/C	P/C	NP	P/C
Marine repairs	NP	NP	NP	NP	NP	NP	NP	NP
Finance, Insurance, and Real Estate establishments (with no drive through facility)	P	P	P	P	P	P	NP	P
Offices for business, professional, administrative, and technical services	P	P	P	P	P	P	P	P
Research laboratory headquarters, laboratories and associated facilities	NP	NP	NP	NP	Р	Р	NP	Р
Food Service Uses such (includes seating on a sidewalk areas with no pedestrian obstruction; includes alcohol sales; with no drive through facility)	Р	Р	Р	Р	Р	Р	NP	Р
Bar or drinking place	Р	Р	Р	Р	Р	Р	NP	Р
Personal Services such as laundry, dry cleaners, hair care, etc.	Р	Р	Р	Р	Р	Р	NP	Р
Tattoo and body piercing (with a state license)		NP	NP	NP	NP	Р	NP	NP
Permanent Makeup Application (with a state license)		NP	NP	NP	NP	Р	NP	NP
Retail bait stands	Р	Р	NP	NP	Р	NP	NP	Р
Pet and animal sales or service		Р	Р	Р	Р	Р	NP	Р
Any permitted use with a drive through facility	NP	NP	P/C	NP	P/C	P/C	NP	P/C
Arts, Entertainment,	and Recreatio	n Uses		•			l.	
Indoor amusement or theme park establishment including bowling alleys, bingo parlor, games arcades, skating, etc.	Р	Р	Р	Р	Р	Р	NP	Р
Outdoor amusement or theme park establishment including miniature golf, go-cart tracks, etc.	P/SUP	P/SUP	NP	NP	P/SUP	P/SUP	NP	P/SUP
Art galleries	Р	Р	Р	Р	Р	Р	Р	Р
Art, antique, apparel, appliance, furniture or electronics studio (includes retail, repair or fabrication uses)	Р	Р	Р	Р	Р	Р	NP	Р
Fitness, recreational sports, gym, or athletic club		Р	Р	Р	Р	Р	NP	Р
Private clubs, fraternities, sororities and lodges that operate solely for the benefit of their members only		Р	Р	Р	Р	Р	NP	Р
Art, dance & music schools		Р	Р	Р	Р	Р	NP	Р
Marina or yachting club facility		NP	NP	NP	P/SUP	P/SUP	NP	P/SUP
Boat docks		NP	Р	NP	Р	Р	NP	Р
Museums and other special purpose recreational institutions		Р	NP	Р	Р	Р	NP	Р
Parks, greens, plazas, squares, and playgrounds		Р	Р	Р	Р	Р	P	Р
Performing arts, theater, cinema, dance or music establishment	Р	Р	Р	Р	Р	Р	NP	Р
Educational, Public Administration, He					T	1	ı	
Business associations and professional membership organizations	Р	Р	Р	Р	Р	Р	NP	Р
Child day care and preschools	Р	Р	Р	Р	Р	Р	Р	Р

PADRE BOULEVARD AND ENTERTAINMENT DISTRICT CODE

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Character	Bayfront	Entertainment District Core	Neighborhood Crossing	Town Center Crossing	Padre Boulevard North/Central	Padre Boulevard South	Neighborhood Transition	Northern Resort District
Schools, libraries, and community halls	Р	Р	Р	Р	Р	Р	NP	Р
Universities and Colleges	Р	Р	Р	Р	Р	Р	NP	Р
Technical, trade, and specialty schools	Р	Р	Р	Р	Р	Р	NP	Р
Hospitals (General and Special), primary care office, urgent care centers, and dental clinics	NP	NP	Р	Р	Р	Р	NP	Р
Nursing, supervision, and other rehabilitation services (including Substance Abuse Clinics)	NP	NP	P/SUP	P/SUP	P/SUP	P/SUP	NP	P/SUP
Civic uses	Р	Р	Р	Р	Р	Р	NP	Р
Social and fraternal organizations	Р	Р	Р	Р	Р	Р	NP	Р
Social services and philanthropic organizations	P	Р	Р	Р	Р	Р	NP	Р
Public administration uses (including government uses, public safety, health and human services)	P	P	P	Р	P	P P	NP	P
Religious Institutions	P	P	P	P	P	P	P	P
Funeral homes	P	P	Р	P	P	P	NP	P
Residenti	·	'	'	'		·	141	
Home Occupations such as a dressmaker, physician/surgeon/dentist offices, a musician/artist studio etc.	P/A	D/A	D/A	D/A	P/A	D/A	D/A	P/A
	SE	P/A SE	P/A SE	P/A SE	SE	P/A SE	P/A SE	P/A P
Single family Multi family residential (including apartment and condeminiums)	3E) SE	3E) SE) SE	3E	3E	Р
Multi-family residential (including apartment and condominiums) Ground floor	P/C	P/C	P/C	P/C	P/C	P/C	P	P
	P/C P	P/C P	P/C P	P/C P	P/C P	P/C P	P	P
Upper floors Residential Lofts	P	P	P	P	P	P	P	P
	NP	NP	NP	NP	NP	NP	NP	P
Weekend cottages			P P	P P	P P	P P	P P	P
Single-family residential attached dwelling unit (Townhomes)	SE SE	SE SE			·			
Accessory residential unit (accessory building not exceed 50% of the floor area of the principal structure)			P/A	P/A	P/A	P/A	P/A	P/A
Residential accessory uses in a vacant lot that is contiguous with a residential single family lot having a principal building under common ownership	NA	NA	NA	NA	NA	NA	NA	NA
Short-term (less than 30 days) rentals	Р	Р	Р	Р	Р	Р	Р	Р
Mixed use structure (with uses allowed in the district)	Р	Р	Р	Р	Р	Р	Р	Р
Trailer parks (travel trailers)	NP	NP	NP	NP	NP	NP	NP	NP
Live-work unit	Р	Р	Р	Р	Р	Р	Р	Р
Other		1	1	1	_	1		T
Accessory uses (the sum of all accessory uses shall not constitute a total area larger than twenty (20) percent of the total building area of the principal use	NP	NP	NP	NP	NP	NP	NP	Р
Publishing (newspaper, books, periodicals, software)	P/C	P/C	Р	Р	Р	Р	NP	Р
Motion picture and sound recording		P/C	Р	Р	Р	Р	NP	Р
Telecommunications and broadcasting		P/C	Р	Р	Р	Р	NP	Р
Information services and data processing		P/C	Р	Р	Р	Р	NP	Р
Model homes or field offices for sales and promotion (until all the homes are sold; building permit is required and shall be valid for a one (1) year period; renewable if sales are still active)		Р	Р	Р	Р	Р	Р	Р
Bed and Breakfast Establishments		NP	NP	NP	Р	Р	Р	Р
Hotels and motels		Р	Р	Р	Р	Р	NP	Р
Hotels, motels and condominiums with more than twelve (12) units may include within the premises such	P	Р	P	P	Р	P	NP	Р
businesses as bars, food establishments, barber shops, beauty parlors and other similar businesses	P/C	P/C	P/C	P/C	P/C	P/C	NP	P/C
Commercial parking Temporary commercial parking*	P/C P	P/C P	P/C P	P/C P	P/C P	P/C P	NP NP	P/C P
Temporary commercial parking*	۲ P	۲ ۲	٢	P	۲ ۲	۲	INP	۲

City of South Padre Island

PADRE BOULEVARD AND ENTERTAINMENT DISTRICT CODE

Character	Bayfront	Entertainment District Core	Neighborhood Crossing	Town Center Crossing	Padre Boulevard North/Central	Padre Boulevard South	Neighborhood Transition	Northern Resort District
Parking, surface (primary use of property)	P/C	P/C	P/C	P/C	P/C	P/C	P/C	P/C
Parking, surface (accessory use of property)	Р	Р	Р	Р	Р	Р	Р	Р
Parking, structured		Р	Р	Р	Р	Р	NP	Р
Private attached garage	P/A	P/A	NP	NP	NP	NP	P/A	P/A
Private detached garage		P/A	NP	NP	NP	NP	P/A	P/A
Impound lot		NP	NP	NP	NP	NP	NP	NP
Outdoor storage		NP	NP	NP	NP	NP	NP	NP
Heliport landing/take-off pads		NP	NP	NP	NP	NP	NP	NP
Community garden	P/C	P/C	P/C	P/C	P/C	P/C	P/C	P/C
Antennas including cell, accessory, and mounted on top of buildings.	P/A/C	P/A/C	P/A/C	P/A/C	P/A/C	P/A/C	P/A/C	P/A/C
Utility equipment (includes electrical transformers, gas meters, etc)	P/A/C	P/A/C	P/A/C	P/A/C	P/A/C	P/A/C	P/A/C	P/A/C
Wind energy equipment		P/A	P/A	P/A	P/A	P/A	P/A	P/A
Rain harvesting equipment	P/A/C	P/A/C	P/A/C	P/A/C	P/A/C	P/A/C	P/A/C	P/A/C
Solar energy equipment		P/A	P/A	P/A	P/A	P/A	P/A	P/A
Special Event		P/SUP	P/SUP	P/SUP	P/SUP	P/SUP	NP	P/SUP
Temporary buildings for construction (shall be removed upon completion or abandonment of construction work)		Р	Р	Р	Р	Р	Р	Р

P: Permitted by right

P/C: Permitted with design criteria per Table 5.2

P/A: Permitted accessory use

P/A/C: Permitted as an accessory use with design criteria per Table 5.2

P/SUP: Permitted with a Specific Use Permit

SUP shall meet standards in Chapter 20-24 of the City Code of Ordinances

A: Accessory use to not exceed 25% of the primary use building square footage

SE: Special Exception
NA: Not applicable
NP: Not permitted

*All parking and maneuvering areas on a non-residential lot shall have dustproof paving or vegetative coverage. (Usage of Caliche or similar materials that may cause clogs in drainage system or create dust in the area are not allowed.

PADRE BOULEVARD AND ENTERTAINMENT DISTRICT CODE

5.2 Use Criteria: All uses listed as P/C in Table 5.1 shall also meet the following standards in Table 5.2

	Table 5.2 – Use Criteria				
Use	Location & Design Criteria				
Non-Residential Uses					
Auto-related Sales and Service	 The building design shall conform to the requirements of the Padre Boulevard and Entertainment District Design Guidelines. Accessory structures, including canopies, kiosks, and car wash buildings, shall conform to or compliment the project architectural theme. This includes similar roof styles, column types, materials, textures, and colors. Service bays and car wash tunnel openings shall be oriented away from street view and screened from adjacent sites. If service bays and car wash openings toward street view are necessary, dense landscaping and/or architectural treatments shall be provided to screen and/or mitigate unattractive views and features from the street. Cross access connection shall be required for a mechanic shop to achieve a better screening. Building colors should emphasize earth tones. The use of highly reflective or glossy materials should be limited and will not be appropriate in all contexts. Such uses shall be designed so as to mitigate any negative impact on residential uses, including orientation and buffers. Where adjacent to residential zoning or residential uses, self-service or automatic car washes shall have sound attenuation devices, such as doors or screen walls, located at the entrances and/or exits of the car wash. All equipment within car wash tunnels shall be contained within the building. All vehicles under repair and equipment within repair bays shall be contained within the building and shall not be visible from outside. Canopy lighting shall be recessed and flush with its underside (ceiling). Full-service car washes shall provide shaded plazas and/or indoor waiting areas for customers. Gas pumps, canopies, and/or service bays shall not be located along any Pedestrian Priority Street frontage. Any buildings associated with the use shall also have a pedestrian entrance at a Pedestrian Priority Street and/or the Boulevard. 				
	No outdoor storage of vehicles or other products sold shall be permitted. All auto-related sales display shall be inside storefronts.				
Any permitted use with a drive through facility	 All drive through access (driveways) shall be from a street with a higher hierarchy. Drive through lanes and/or canopies shall not have frontage along any Pedestrian Priority Streets. 				
Residential Uses					
Multi-family residential Ground Floor	All ground floors along all Pedestrian Priority and Boulevard Frontages shall be built to Commercial Ready standards. Ground floors may be occupied by residential uses.				
Other Uses					
Publishing (newspaper, books, periodicals, software) Motion Picture and sound recording Telecommunications and broadcasting (radio, TV, cable, wireless communications, telephone, etc) Information services and data processing	Shall only be permitted on the upper floors of buildings				
Parking, surface (primary use of					
property)	New surface parking shall be set back a minimum of 30' from the edge of the right-of-way of Pedestrian Priority Streets.				
Sales from Kiosks	 New surface parking shall not be located at a street intersection for minimum of 30' along each street. Kiosks shall only be permitted on civic/open spaces. Kiosks shall be no larger than 150 sq.ft. in area and no taller than 18' in height. Kiosk locations shall not impede pedestrian pathways or entrances to buildings Kiosks from which merchandise or food is sold shall be attended when open for business. Kiosks shall be constructed of similar materials or given a similar finish as adjacent buildings. 				

PADRE BOULEVARD AND ENTERTAINMENT DISTRICT CODE

	Table 5.2 – Use Criteria					
Use	Location & Design Criteria					
	All sides of a kiosk shall have a finished look with no externally visible utility equipment.					
Community Garden	Shall be no larger than 0.5 acres					
	Gardens shall be enclosed by a fence on all open sides.					
	• Fences should be installed straight and plumb, with vertical supports at a minimum of 8' on center. Chicken wire, if used, should be continuously					
	supported along all edges.					
	Fencing Materials:					
	o Permitted: pressure treated wood (must be painted or stained medium to dark color), chicken wire, wrought iron, painted galvanized steel					
	 Not permitted: chain link, bobbed wire, vinyl, un-painted/stained pressure treated wood, plywood 					
Antennas including cell, accessory	Antennas shall be permitted on rooftops.					
and mounted	 Antennas shall be screened entirely with a screen of same color as the principal building. 					
(Excluded from this category are	 Antennas shall not be visible from adjacent Pedestrian Priority Street. 					
freestanding and commercial						
antennas and equipment buildings)						
Rain water harvesting equipment	Rain water harvesting equipment may not be installed along Pedestrian Priority Streets.					
	On all other frontages, they shall be screened with a Street Screen at least as high as the equipment being screened.					
Utility equipment (includes electrical	Utility equipment shall not be installed with frontage on Pedestrian Priority Streets.					
transformers, gas meters, etc)	On all other frontages, they shall be screened with a Street Screen at least as high as the equipment being screened.					
Commercial Parking	New surface parking shall be set back a minimum of 30' from the edge of the right-of-way of Pedestrian Priority Streets.					
	New surface parking shall not be located at a street intersection for minimum of 30' along each street.					
	Commercial parking shall not be allowed along any pedestrian priority street frontage.					



CITY OF SOUTH PADRE ISLAND

Development Standards Review Task Force Application Meeting date on the 2nd Tuesday of every month.

To be considered a complete application this form must be COMPLETELY filled out and ten (10) copies of the form and supporting documentation must be submitted two (2) weeks before the meeting date. \$250 application fee per variance request.

SITE LOCATION FOR REQUEST:							
Physical Address (Street Name & Number):	222 Pike Street						
Legal Description (Lot/Block/Subdivision):							
Is this property part of a shopping center (i.e. one tenant of many?) [] YES / [X] NO							
Linear footage of any walls facing a street:	n/a						
650	velopment Standards Review Task Force:						
Permission to install a new wo	ood utility pole for AT&T Mobility with proposed						
backhaul transport equipment a	and antenna for network densification.						
PROPERTY OWNER: ATET Mobility OWNER MAILING ADDRESS: 1801 V							
CITY, STATE, ZIP: Farmers Branch,	TX 75234						
PHONE NUMBER: (210) 213-0718	(B-mail address) rr2028@att.com						
Robert Moder Reur I	10/26/20						
Signature of Property Owner (required)	Dute						
APPLICANT: Jacobs							
APPLICANT MAILING ADDRESS: 119	O Airline Drive						
CITY, STATE, ZIP: Houston, TX 770							
PHONE NUMBER: (817) 681-4173	(E-mail address) kari.colley@jacobs.com						
Kari Colley or locate, or U.S.	10/26/20						
Signature of Applicant (if different from owns	Pote						



DO NOT SCALE DRAWINGS

CONTRACTORS SHALL VERIFY ALL PLANS, EXISTING DIMENSIONS & FIELD CONDITIONS ON THE JOB SITE & SHALL IMMEDIATELY NOTIFY THE ARCHITECT/ENGINEER IN WRITING OF ANY DISCREPANCIES BEFORE PROCEEDING WITH THE WORK OR BE RESPONSIBLE FOR SAME.

GENERAL NOTES

THE FACILITY IS UNMANNED AND NOT FOR HUMAN HABITATION. A TECHNICIAN WILL VISIT THE SITE AS REQUIRED FOR ROUTINE MAINTENANCE. THE PROJECT WILL NOT RESULT IN ANY SIGNIFICANT DISTURBANCE OF EFFECT ON DRAINAGE; NO SANITARY SEWER SERVICE, POTABLE WATER OR TRASH DISPOSAL IS REQUIRED AND NO COMMERCIAL SIGNAGE IS PROPOSED.

PRIOR TO ANY CONSTRUCTION WORK, CONTRACTOR SHALL LOCATE ALL UNDERGROUND UTILITIES. ALL UTILITIES SHALL BE MARKED.


THIS DESIGN IS SUBJECT TO ANY JURISDICTIONAL AND OWNER APPROVALS INCLUDING JURISDICTIONAL REQUIREMENTS, RF EQUIPMENT CONFIGURATION, AND FINAL UTILITY COORDINATION WITH PUBLIC POWER AND UTILITY PROVIDERS/ CONTRACTOR TO CONFIRM FINAL REQUIREMENTS WITH OWNER.

SITE INFORMATION				
APPLICANT:	AT&T MOBILITY			
APPLICANT ADDRESS:	1501 VALLEY VIEW LANE FARMERS BRANCH, TX 75234			
AT&T PROJECT MANAGER	ROBERT RENNER			
SITE ADDRESS:	222 PIKE STREET SOUTH PADRE ISLAND, TX 78597			
PROPERTY OWNER:	AT&T			
PROPERTY OWNER ADDRESS:	1801 VALLEY VIEW LANE FARMERS BRANCH, TX 75234			
STRUCTURE TYPE:	NEW POLE			
JURISDICTION:	CITY OF SOUTH PADRE ISLAND			
LATITUDE:	N 26.102562			
LONGITUDE:	W ~97.168108			
LAT/LONG DATUM:	NAD 83			
GROUND ELEVATION:	±3' AMSL			
POWER	AEP			
TELCO	AT&T			

IMPORTANT NOTICE

THE EXISTING CONDITIONS REPRESENTED HEREIN ARE BASED ON VISUAL OBSERVATIONS AND INFORMATION PROVIDED BY OTHERS, CONTRACTOR SHALL VISIT THE SITE AND VERIFY ALL EXISTING CONDITIONS PRIOR TO CONSTRUCTION. REPORT AND CONFLICTS OR DISCREPANCIES PRIOR TO CONSTRUCTION.

PACE JOB NUMBER: MRSTX049968
FA: 14861815 USID: 266071 SCIP ID: 18627-050
JURISDICTION: CITY OF SOUTH PADRE ISLAND
222 PIKE STREET
SOUTH PADRE ISLAND, TX 78597

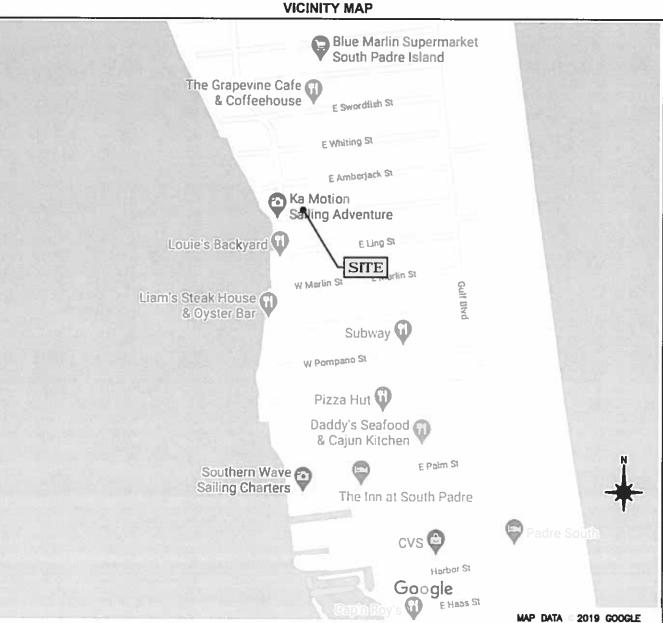



IF YOU DIG IN ANY STATE DIAL 811 FOR THE LOCAL "ONE CALL CENTER" —
IT'S THE LAW

THE UTILITIES SHOWN HEREIN ARE FOR THE CONTRACTORS CONVENIENCE ONLY. THERE MAY BE OTHER UTILITIES NOT SHOWN ON THESE PLANS. THE ENGINEER/SURVEYOR ASSUMES NO RESPONSIBILITY FOR THE LOCATIONS SHOWN AND IT SHALL BE THE CONTRACTOR'S RESPONSIBILITY TO VERIFY ALL THE UTILITIES WITHIN THE LIMITS OF THE WORK. ALL DAMAGE MADE TO THE EXISTING UTILITIES BY THE CONTRACTOR SHALL BE THE SOLE RESPONSIBILITY OF THE CONTRACTOR.

SCOPE OF WORK

Installation of a wireless communications antenna and associated support equipment on an new pole

CODES

INTERNATIONAL BUILDING CODE NATIONAL ELECTRICAL SAFETY CODE TIA/EIA-222-G-2 OR LATEST EDITION LOCAL BUILDING/PLANNING CODE

	DRAWING INDEX
SHEET NO:	SHEET TITLE
T-1	TITLE SHEET
C-1	SITE PLAN
C-2	POLE ELEVATIONS
C-3	EQUIPMENT DETAILS
TC-1	TRAFFIC CONTROL PLAN
GN-1	GENERAL NOTES
GN-2	GENERAL NOTES
GN-3	GENERAL NOTES
	
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ARCHITECT/ENGINEER

JACOBS TELECOMMUNICATIONS, INC. 5449 BELLS FERRY ROAD ACWORTH, GA 30102 CONTACT: KARL KRATINA PROJECT MANAGER TEL: (678) 460-1416



FARMERS BRANCH, TX 75234

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Jacobs Telecommunications. Inc. FIEM F 18110 5449 BELLS FERRY ROAD. ACWORTH. GA 30102 PHONE 47D 785-4050 FAX. 770-701-2501

1	PROJECT NO:	EUAT0204
	DRAWN BY:	C. RAMEY
	CHECKED BY:	W. WEST

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В	10.26.20 05.24.20	REVISION
. A	05.24.20	FOR REVIEW



IT IS A VOLATION OF THE LAW FOR ANY PERSON, UNLESS THEY ARE ACTION UNDER T DIRECTION OF A LICENSIS PROFESSIONAL ENGINEEZY, TO ALTER THIS DOCUMENT.

MRSTX049968 222 PIKE STREET SOUTH PADRE ISLAND, TX 78597 NEW POLE

SHEET TITLE

TITLE SHEET


SHEET NUMBER

T-1



SCALE: N.T.S.



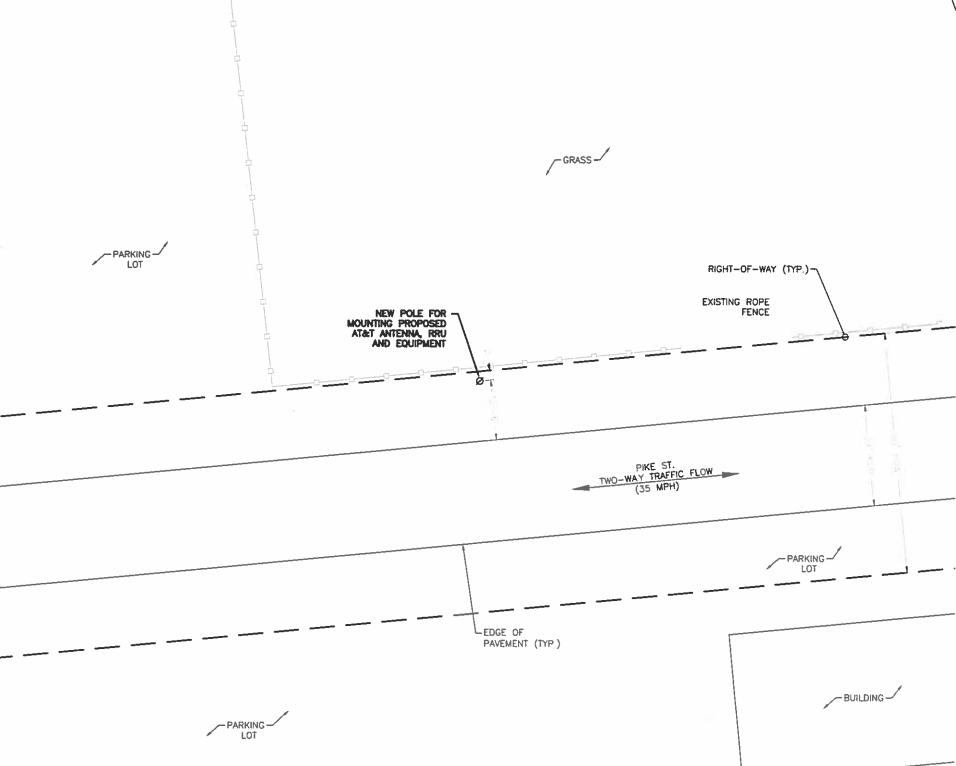

NOTES:

- 1. SITE LAYOUT AND NORTH ARROW OBTAINED ON 08/24/20.
- 2. SOME EXISTING AND PROPOSED INFORMATION NOT SHOWN FOR CLARITY
- 3. ALL POWER SOURCE TO BE PROVIDED BY THE POWER COMPANY AND FIBER SOURCE TO BE PROVIDED BY THE FIBER COMPANY.
- 4. ALL PROPOSED EQUIPMENT SHALL BE GROUNDED IN ACCORDANCE WITH ATT-TP 76416.

3 SITE PLAN

SCALE 11x17: 1"=20'-0" (1"=10'-0" ON 22"x34" SHEET)



1801 WILLEY WENT LANE FARMERS BRANCH, TX 70234


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PROJECT NO: EUAT0204
DRAWN BY: C. RAMEY
CHECKED BY: W. WEST

B 10.26.20 REVISION A 06.24.20 FOR REVISION



IT IS A VIGLATION OF THE LAW FOR MAY PERSON, LIMITES THEY ARE ACTION UNDER T INVESTIGN OF A LICENSED PROPERSONAL ENGINEER, TO ALTER THIS DOCUMENT

MRSTX049968 222 PIKE STREET SOUTH PADRE ISLAND, TX 78597 NEW POLE

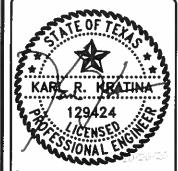SHEET TITLE


SITE PLAN

SHEET NUMBER

C-1

2

SCALE: N.T.S.

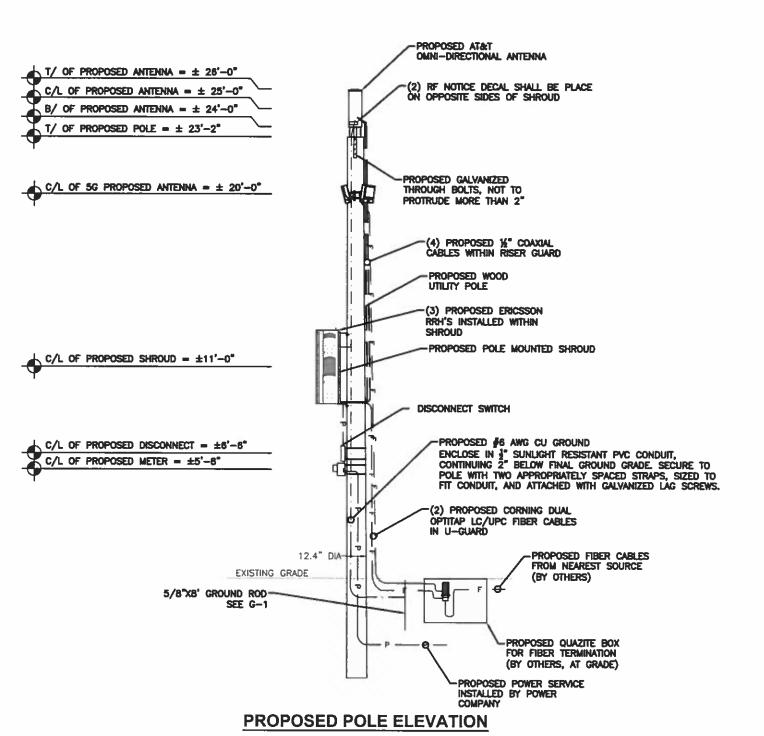

NOTE:
PROJECT SCOPE OF WORK DOES NOT INCLUDE A
STRUCTURAL EVALUATION OF THIS POLE OR
STRUCTURE. NEW EQUIPMENT SHOWN ON THIS
PLAN HAVE NOT BEEN EVALUATED TO VERIFY
THE POLE OR STRUCTURE HAS THE CAPACITY TO
ADEQUATELY SUPPORT THE EQUIPMENT. PRIOR TO
ANY INSTALLATION, A STRUCTURAL EVALUATION OF
THE POLE OR STRUCTURE SHOULD BE PERFORMED.

NOTES:

- CONTRACTOR SHALL REFER TO THE STRUCTURAL ANALYSIS REPORT. NO EQUIPMENT SHALL BE INSTALLED UNLESS IN ACCORDANCE WITH THIS REPORT.
- ALL PROPOSED EQUIPMENT SHALL BE GROUNDED IN ACCORDANCE WITH ATT—TP 76416.
- 3. ALL PROPOSED HARDWARE SHALL BE STAINLESS STEEL.
- INSTALLERS WORKING IN THE AREA OF THE POLE ABOVE THE NORMAL COMMUNICATION SPACE MUST MEET OSHA 1910.269 REQUIREMENTS.
- 5. THE POLE/POST OWNER SHOULD ADVISE ALL EMPLOYEES THAT AT&T ANTENNAS ARE LOCATED ON SOME POLES/POSTS AND THAT THE GUIDANCE PROVIDED BY THE SIGNS SHOULD BE FOLLOWED.
- 6. ANTENNA TO BE MOUNTED ON BACK SIDE OF POLE AWAY FROM TRAFFIC.




1801 WILLEY WEN LANE FAMILIES BRANCH, TX 78834

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PROJECT NO:	EUAT0204
DRAWN BY:	C. RAMEY
CHECKED BY:	W. WEST





MRSTX049968 222 PIKE STREET SOUTH PADRE ISLAND, TX 78597 NEW POLE
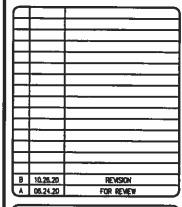
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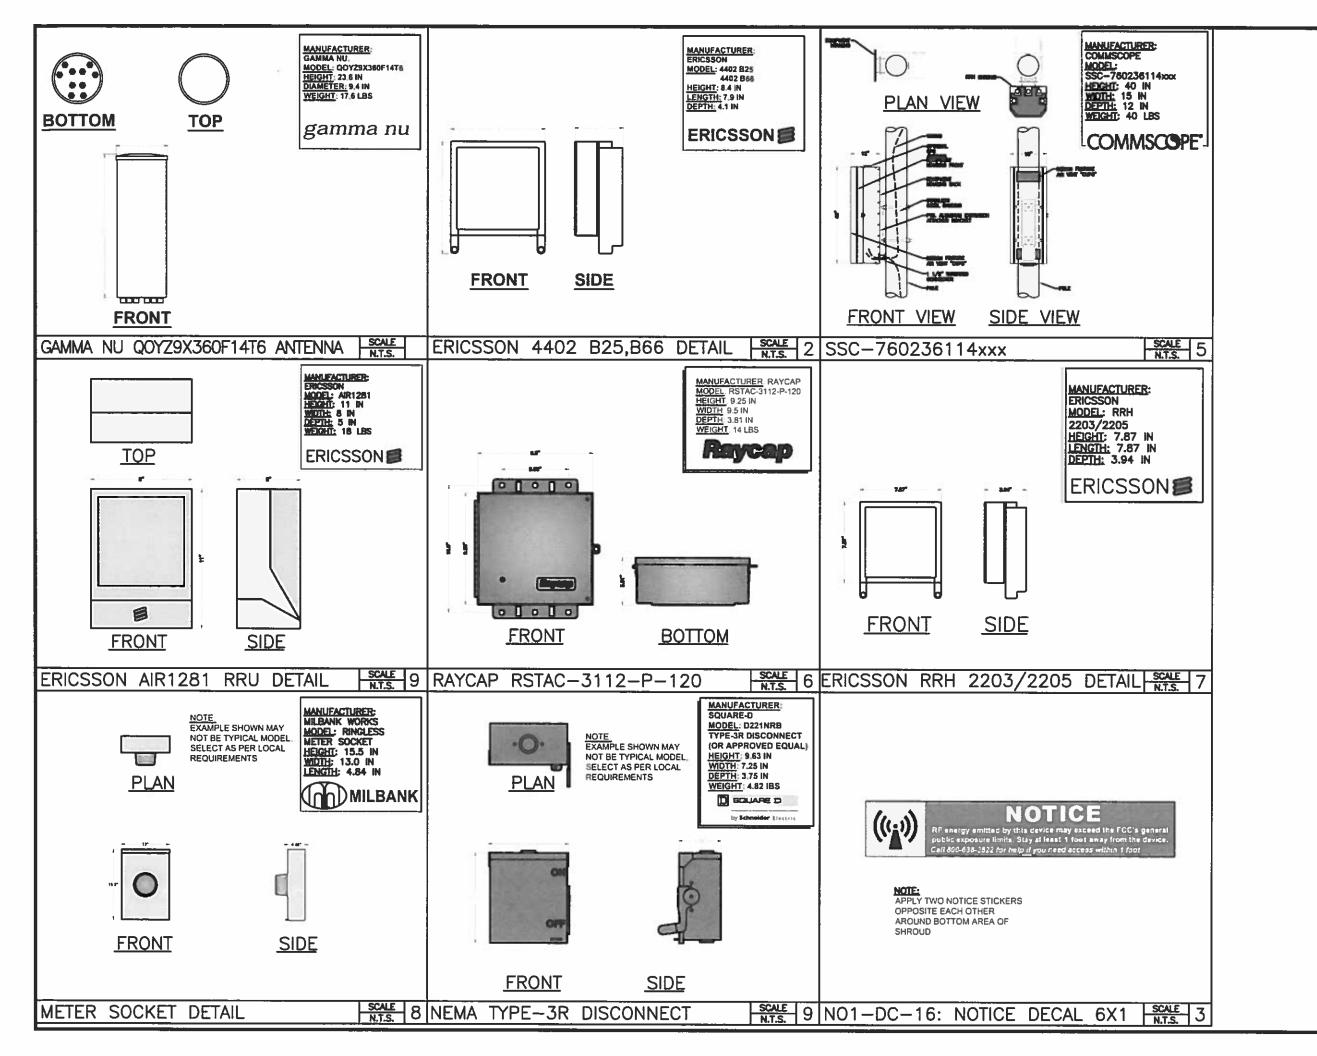
SHEET TITLE

POLE ELEVATIONS

SHEET NUMBER

C-2

1 POLE ELEVATIONS





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Jacobs Telecommunications, Inc. FIRM F 18110 5448 BELIS FERRY RY AD ACWORTH, GA 30102 PHONE 47D 785 4050 FAX: 0 700

PROJECT NO: EUAT0204

DRAWN BY C RAMEY

CHECKED BY W WEST

B 10.25.20 REVISION
A 06.24.20 FOR REVIEW



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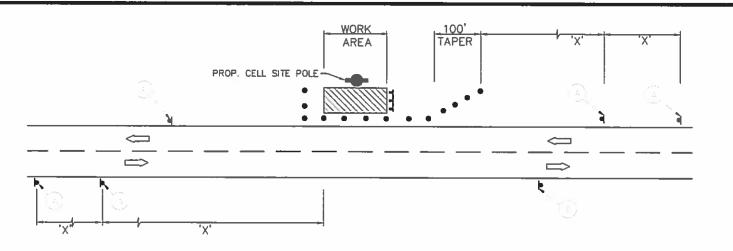
MRSTX049968 222 PIKE STREET SOUTH PADRE ISLAND TX 78597 NEW POLE

SHEET TITLE

EQUIPMENT DETAILS

SHEET NUMBER

C-3



WARK AN THE AUGUS BERA

(DAY TIME WORKING HOURS ONLY) (FOR STREET RUNNING IN NORTH-SOUTH OR EAST-WEST DIRECTION) SHOULDER WORK

30

35

40

50

55

80

65

70

CW21-5 48 X 48

END ROAD WORK

Offset Offset Offset

205' 225' 245'

600' 660' 720'

150' 165' 180' 30' 60'

480' 486' 540' 45' 90'

500' 550' 500' 50' 100'

560' 605' 660' 55' 110'

PLASTIC DRUM

WORK ZONE

T OFF-DUTY UNIFORMED

POLICE OFFICER OR FLAGGER --- TYPE III BARRICADE TLASHING ARROW PANEL

265' 295' 320' 40'

35'

680' 715' 780' 65' 130' 700'

700' 770' 840' 70' 140' 800'

750' 825' 900' 75' 150' 900'

70

80'

120

Sign Specing X Distance

120'

180'

240

320'

400'

500

600,



80,

120'

155"

195

240

295

350'

410'

475

540"

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Jacobs Telecommunications, Inc. FIRM F-181 10 5449 BELLS FERRY ROAD. ACWORTH, GA 30102 PHONE: 470-785-4050 FAX: 770-701-2501

	PROJECT NO:	EUAT0264
1	DRAWN BY:	C. RAMEY
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MRSTX049968 222 PIKE STREET SOUTH PADRE ISLAND, TX 78597 **NEW POLE**

TRAFFIC CONTROL PLAN **AND NOTES**

SHEET NUMBER

TC-1

<u>work</u>	ON	<u> </u>	SHOU	<u>LDERS</u>

NOTES:

- CONTRACTOR SHALL PROVIDE AND INSTALL TEMPORARY TRAFFIC AND WORKER/PEDESTRIAN SAFETY CONTROL DEVICES IN CONFORMANCE WITH PART 6 OF THE TEXAS MANUAL ON UNIFORM TRAFFIC CONTROL DEVICES (TEXAS MUTCD, REVISION 2
- OCTOBER 2014) DURING CONSTRUCTION.
 CONTRACTOR SHALL UTILIZE A RESPONSIBLE PERSON CERTIFIED FOR TEXAS MUTCO TEMPORARY TRAFFIC CONTROL OPERATIONS TO VERIFY AND MONITOR PLACEMENT OF ALL TCP DEVICES DURING CONSTRUCTION. SHOULD FIELD CONDITIONS REQUIRE, CONTRACTOR SHALL MODIFY THE LAYOUT SO ALL TCP OPERATIONS, SIGNAGE, AND PROCEDURES ARE IN ACCORDANCE WITH PART 6 TX MUTCO.

- ARE IN ACCORDANCE WITH PART 6 TX MUTCD.

 CONTRACTOR SHALL PROVIDE AND INSTALL SIGNAGE FOR WORKER AND PEDESTRIAN SAFETY PER TA-29, TXMUTCD.

 PRIOR TO ANY ROAD CONSTRUCTION, TRAFFIC CONTROL SIGNS AND DEVICES SHALL BE IN PLACE.

 ADVANCE WARNING SIGNS, DISTANCES, AND TAPER LENGTHS MAY BE EXTENDED TO ADJUST FOR REDUCED VISIBILITY DUE

 TO HORIZONTAL AND VERTICAL CURVATURE OF THE ROADWAY AND FOR ACTUAL TRAFFIC SPEEDS IF IN EXCESS OF

 POSTED SPEED LIMITS. TAPERS SHALL BE LOCATED TO MAXIMIZE THE VISIBILITY OF THEIR TOTAL LENGTH,

 CONFLICTING OR NON-OPERATING SIGNAL INDICATIONS ON THE EXISTING TRAFFIC SIGNAL SYSTEMS SHALL BE BAGGED OR
- COVERED ALL EXISTING ROAD SIGNS. PAVEMENT MARKINGS AND/OR PLOWABLE PAVEMENT REFLECTORS WHICH CONFLICT WITH THE PROPOSED TRAFFIC CONTROL PLAN SHALL BE COVERED, REMOVED, OR RELOCATED, ALL TRAFFIC CONTROL DEVICES SHALL BE RESTORED TO MATCH PRE—CONSTRUCTION CONDITION AFTER COMPLETION OF WORK.
- CONTRACTOR SHALL CONTACT LOCAL AUTHORITY HAVING JURISDICTION AND PROVIDE ADDITIONAL "FLAGMEN" OR POLICE SUPERVISION, IF REQUIRED.



TRAFFIC CONTROL PLAN

SCALE: NOT TO SCALE

GENERAL CONSTRUCTION NOTES:

- ALL WORK SHALL CONFORM TO THE REQUIREMENTS OF THE LOCAL BUILDING CODE, THE LATEST ADOPTED EDITION AND ALL OTHER APPLICABLE CODES AND ORDINANCES.
- 2. CONTRACTOR SHALL CONSTRUCT SITE IN ACCORDANCE WITH THESE DRAWINGS AND LATEST JACOBS CONSTRUCTION STANDARDS. THE SPECIFICATION IS THE RULING DOCUMENT AND ANY DISCREPANCIES BETWEEN THE SPECIFICATION AND THE CONSTRUCTION DRAWINGS SHALL BE BROUGHT TO THE ATTENTION OF THE ARCHITECT/ENGINEER OR JACOBS CM PRIOR TO THE COMMENCEMENT OF WORK.
- 3. CONTRACTOR SHALL MSIT THE JOB SITE AND SHALL FAMILIARIZE THEMSELVES WITH ALL CONDITIONS AFFECTING THE PROPOSED WORK AND SHALL MAKE PROVISIONS AS TO THE COST THEREOF. CONTRACTOR SHALL BE RESPONSIBLE FOR FAMILIARIZING THEMSELVES WITH ALL CONTRACT DOCUMENTS, FIELD CONDITIONS AND DIMENSIONS AND CONFIRMING THAT THE WORK MAY BE ACCOMPLISHED, AS SHOWN, PRIOR TO PROCEEDING WITH CONSTRUCTION. ANY DISCREPANCIES SHALL BE BROUGHT TO THE ATTENTION OF THE ARCHITECT/ENGINEER OR JACOBS CM PRIOR TO THE COMMENCEMENT OF WORK. NO COMPENSATION WILL BE AWARDED BASED ON CLAIM OF LACK OF KNOWLEDGE OF FIELD CONDITIONS.
- 4. IT IS NOT THE INTENT OF THESE PLANS TO SHOW EVERY MINOR DETAIL OF CONSTRUCTION. CONTRACTOR IS REQUIRED TO FURNISH AND INSTALL ANY/ALL ITEMS FOR A COMPLETE AND FULLY FUNCTIONAL SYSTEM SUBJECT ONLY TO OWNER-SUPPLIED ITEMS. CONTRACTOR SHALL PROVIDE ANY/ALL REQUIREMENTS FOR THE EQUIPMENT TO BE PLACED IN PROPER WORKING ORDER.
- 5. PLANS ARE NOT TO BE SCALED. THESE PLANS ARE INTENDED TO BE A DIAGRAMMATIC OUTLINE ONLY UNLESS OTHERWISE NOTED. THE WORK SHALL INCLUDE FURNISHING MATERIALS, EQUIPMENT AND APPURTENANCES, AND LABOR NECESSARY TO EFFECT ALL INSTALLATIONS AS INDICATED ON THE DRAWINGS. OWNER PROVIDED AND CONTRACTOR INSTALLED MATERIALS WILL INCLUDE THE FOLLOWING, UNLESS NOTED OTHERWISE:
 - A) TRANSMITTER
 - B) UHF ANTENNA AND MOUNTING BRACKETS, GPS ANTENNAS AND KU ANTENNAS
 - C) UHF COAX AND HANGERS
 - D) INTEGRATED LOAD CENTER
- 6. DIMENSIONS SHOWN ARE TO FINISH SURFACES UNLESS OTHERWISE NOTED. SPACING BETWEEN EQUIPMENT IS REQUIRED CLEARANCE. THEREFORE, IT IS CRITICAL TO FIELD VERIFY DIMENSIONS. SHOULD THERE BE ANY QUESTIONS REGARDING THE CONTRACT DOCUMENTS, EXISTING CONDITIONS AND/OR DESIGN INTENT, THE CONTRACTOR SHALL BE RESPONSIBLE FOR REPORTING ANY DISCREPANCIES TO THE ATTENTION OF THE JACOBS CM, IN WRITING, PRIOR TO THE COMMENCEMENT OF WORK.
- DETAILS PROVIDED ARE FOR THE PURPOSE OF SHOWING DESIGN INTENT.
 MODIFICATIONS MAY BE REQUIRED TO SUIT JOB DIMENSIONS OR SITE CONDITIONS,
 AND SUCH MODIFICATIONS SHALL BE INCLUDED AS PART OF THE WORK.
- 8. CONTRACTOR SHALL PAY FOR APPLICABLE PERMITS, FEES, INSPECTIONS AND TESTING. CONTRACTOR IS TO OBTAIN PERMITS AND APPROVED SUBMITTALS PRIOR TO ORDERING MATERIALS AND THE COMMENCEMENT OF WORK.
- THE TERM "PROVIDE" USED IN CONSTRUCTION DOCUMENTS AND SPECIFICATIONS, INDICATES THAT THE CONTRACTOR SHALL FURNISH AND INSTALL.
- 10. CONTRACTOR SHALL RECEIVE CLARIFICATION IN WRITING, AND SHALL RECEIVE IN WRITING AUTHORIZATION TO PROCEED BEFORE STARTING WORK ON ANY ITEMS NOT CLEARLY DEFINED OR IDENTIFIED BY THE CONTRACT DOCUMENTS.
- 11. CONTRACTOR SHALL SUPERVISE AND DIRECT THE WORK USING ACCEPTED INDUSTRY-STANDARD SKILLS AND ATTENTION. CONTRACTOR SHALL BE SOLELY RESPONSIBLE FOR CONSTRUCTION MEANS, METHODS, TECHNIQUES, SEQUENCES AND PROCEDURES AND FOR COORDINATING ALL PORTIONS OF THE WORK UNDER CONTRACT, UNLESS OTHERWISE NOTED.
- 12. CONTRACTOR SHALL BE RESPONSIBLE FOR THE SAFETY OF THE WORK AREA, ADJACENT AREAS AND BUILDING OCCUPANTS THAT ARE LIKELY TO BE AFFECTED BY THE WORK UNDER THIS CONTRACT. WORK SHALL CONFORM TO ALL OSHA REQUIREMENTS.
- 13. CONTRACTOR SHALL COORDINATE THEIR WORK WITH THE JACOBS CM AND SCHEDULE THEIR ACTIVITIES AND WORKING HOURS IN ACCORDANCE WITH THE REQUIREMENTS.
- 14. CONTRACTOR SHALL BE RESPONSIBLE FOR COORDINATING THEIR WORK WITH THE WORK OF OTHERS AS IT MAY RELATE TO RADIO EQUIPMENT, ANTENNAS AND ANY OTHER PORTIONS OF THE WORK.
- 15. CONTRACTOR SHALL INSTALL ALL EQUIPMENT AND MATERIALS IN ACCORDANCE WITH MANUFACTURERS RECOMMENDATIONS UNLESS SPECIFICALLY OTHERWISE INDICATED OR WHERE LOCAL CODES OR REGULATIONS TAKE PRECEDENCE.
- 16. CONTRACTOR SHALL MAKE NECESSARY PROVISIONS TO PROTECT EXISTING SURFACES, EQUIPMENT, IMPROVEMENTS, PIPING ETC. AND IMMEDIATE REPAIR, TO NEW CONDITION, ANY DAMAGE THAT OCCURS DURING CONSTRUCTION AT THE SOLE COST OF THE CONTRACTOR.

- 17. IN DRILLING HOLES, OR CORING, INTO CONCRETE WHETHER FOR FASTENING OR ANCHORING PURPOSES, OR PENETRATIONS THROUGH THE FLOOR FOR CONDUIT RUNS, PIPE RUNS ETC. MUST BE CLEARLY UNDERSTOOD THAT REINFORCING STEEL SHALL NOT BE DRILLED INTO, CUT OR DAMAGED UNDER ANY CIRCUMSTANCES (UNLESS NOTED OTHERWISE). LOCATIONS OF REINFORCING STEEL ARE NOT DEFINITELY KNOWN AND THEREFORE MUST BE LOCATED BY THE CONTRACTOR USING APPROPRIATE METHODS AND EQUIPMENT PRIOR TO ANY DRILLING OR CORING OPERATIONS IN EXITING CONCRETE.
- 18. CONTRACTOR SHALL REPAIR, TO NEW CONDITION, ALL EXISTING WALL SURFACES DAMAGED DURING CONSTRUCTION SUCH THAT THEY MATCH AND BLEND IN WITH ADJACENT SURFACES.
- 19. CONTRACTOR SHALL SEAL PENETRATIONS THROUGH FIRE RATED ASSEMBLIES OR MATERIALS WITH U.L. USTED AND FIRE CODE APPROVED MATERIALS AND SYSTEMS THAT MEET OR EXCEED THE RATING OF THE ASSEMBLY IN WHICH THE NEW PENETRATION IS PLACED.
- 20. CONTRACTOR SHALL KEEP CONTRACT AREA CLEAN, HAZARD FREE, AND DISPOSE OF ALL DIRT, DEBRIS AND RUBBISH. EQUIPMENT NOT SPECIFIED AS REMAINING ON THE 5. PROPERTY OF THE OWNER SHALL BE REMOVED. LEAVE PREMISES IN CLEAN CONDITION AND FREE FROM PAINT SPOTS, DUST OR SMUDGES OF ANY NATURE. CONTRACTOR SHALL BE RESPONSIBLE FOR MAINTAINING ALL ITEMS UNTIL 6. COMPLETION OF CONSTRUCTION.
- 21. MINIMUM BEND RADIUS OF ANTENNA CABLES SHALL BE IN ACCORDANCE WITH CABLE MANUFACTURERS RECOMMENDATIONS.
- 22. CONTRACTOR SHALL MINIMIZE DISTURBANCE TO EXISTING SITE DURING CONSTRUCTION. EROSION CONTROL MEASURES, IF REQUIRED DURING CONSTRUCTION SHALL BE IN CONFORMANCE WITH JURISDICTIONAL OR STATE AND LOCAL GUIDELINES FOR EROSION AND SEDIMENT CONTROL AND COORDINATED WITH LOCAL REGULATORY AUTHORITIES. CONTRACTOR SHALL BE RESPONSIBLE FOR MAINTENANCE OF ANY EROSION CONTROL MEASURES, RECORD—KEEPING, MONITORING, AND REPORTING TO THE OWNER AND REGULATORY AUTHORITIES.
- 23. ALL CONSTRUCTION WORK IS TO ADHERE TO APPLICANT'S INTEGRATED 9. IT IS NOT THE INTENT OF THESE PLANS TO SHOW EVERY MINOR DETAIL OF THE CONSTRUCTION STANDARDS UNLESS STATE OR LOCAL CODE IS MORE STRINGENT.
- 24. THE INTENT OF THE PLANS AND SPECIFICATIONS IS TO PERFORM THE CONSTRUCTION IN ACCORDANCE PER STATE BUILDING STANDARDS CODE AND STATE CODE OF REGULATIONS, SHOULD ANY CONDITIONS DEVELOP NOT COVERED BY THE APPROVED PLANS AND SPECIFICATIONS WHEREIN THE FINISHED WORK WILL NOT COMPLY PER STATE CODE OF REGULATIONS, A SCOPE OF WORK DETAILING AND SPECIFYING THE REQUIRED WORK SHALL BE SUBMITTED TO AND APPROVED BY THE JURISDICTION BEFORE PROCEEDING WITH THE WORK, A CHANGE ORDER FOR THAT SCOPE SHALL BE SUBMITTED TO THE JACOBS CM PRIOR TO PROCEEDING WITH THE WORK.
- 25. ADEQUATE AND REQUIRED LIABILITY INSURANCE SHALL BE PROVIDED BY THE CONTRACTOR FOR PROTECTION AGAINST PUBLIC LOSS AND ANY/ALL PROPERTY DAMAGE FOR THE DURATION OF WORK.
- 26. CONTRACTOR SHALL GUARANTEE ANY/ALL MATERIALS AND WORK FREE FROM DEFECTS FOR A PERIOD OF NOT LESS THAN ONE YEAR FROM DATE OF ACCEPTANCE, ANY CORRECTIVE WORK SHALL BE COMPLETED AT THE SOLE COST OF THE CONTRACTOR.

ELECTRICAL NOTES:

- 1. ELECTRICAL CONTRACTOR SHALL SUPPLY AND INSTALL ANY/ALL ELECTRICAL WORK INDICATED. ANY/ALL CONSTRUCTION SHALL BE IN ACCORDANCE WITH DRAWINGS AND ANY/ALL APPLICABLE SPECIFICATIONS. IF ANY PROBLEMS ARE ENCOUNTERED BY COMPLYING WITH THESE REQUIREMENTS, CONTRACTOR SHALL NOTIFY JACOBS CM AS SOON AS POSSIBLE, AFTER THE DISCOVERY OF THE PROBLEMS, AND SHALL NOT PROCEED WITH THAT PORTION OF WORK, UNTIL THE JACOBS CM HAS DIRECTED THE CORRECTIVE ACTIONS TO BE TAKEN.
- 2. ELECTRICAL CONTRACTOR SHALL VISIT THE JOB SITE AND FAMILIARIZE THEMSELVES WITH ANY/ALL CONDITIONS AFFECTING ELECTRICAL AND COMMUNICATION INSTALLATION AND MAKE PROVISIONS AS TO THE COST THEREOF. ALL EXISTING CONDITIONS OF ELECTRICAL EQUIPMENT, ETC. THAT ARE PART OF THE FINAL SYSTEM, SHALL BE VERIFIED BY THE CONTRACTOR, PRIOR TO THE SUBMITTING OF THEIR BID. FAILURE TO COMPLY WITH THIS PARAGRAPH WILL IN NO WAY RELIEVE CONTRACTOR OF PERFORMING ALL WORK NECESSARY FOR A COMPLETE AND WORKING SYSTEM.

- 3. ALL WORK SHALL BE PERFORMED IN ACCORDANCE WITH THE LATEST EDITION OF THE NEC, ALL CODES AND ORDINANCES OF THE LOCAL JURISDICTION, AND POWER AND TELEPHONE COMPANIES HAVING JURISDICTION AND SHALL INCLUDE BUT ARE NOT LIMITED TO:
 - A) UL UNDERWRITERS LABORATORIES
 - B) NEC NATIONAL ELECTRICAL CODE
 - C) NEMA NATIONAL ELECTRICAL MANUFACTURERS ASSOCIATION
 - D) OSHA OCCUPATIONAL SAFETY AND HEALTH ACT
 - E) SBC STANDARD BUILDING CODE
 - F) NFPA NATIONAL FIRE PROTECTION AGENCY
 G) ANSI AMERICAN NATIONAL STANDARDS INSTITUTE
 - H) IEEE INSTITUTE OF ELECTRICAL AND ELECTRONICS ENGINEERS
 - I) ASTM AMERICAN SOCIETY FOR TESTING MATERIALS
- REFER TO SITE PLANS AND ELEVATIONS FOR EXACT LOCATIONS OF ALL EQUIPMENT, AND CONFIRM WITH JACOBS CM ANY SIZES AND LOCATIONS WHEN NEEDED.
- 5. EXISTING SERVICES: CONTRACTOR SHALL NOT INTERRUPT EXISTING SERVICES WITHOUT WRITTEN PERMISSION OF THE OWNER.
- 6. CONTRACTOR SHALL CONFIRM WITH LOCAL UTILITY COMPANY ANY/ALL REQUIREMENTS SUCH AS THE: LUG SIZE RESTRICTIONS, CONDUIT ENTRY, SIZE OF TRANSFORMERS, SCHEDULED DOWNTIME FOR THE OWNERS' CONFIRMATION, ETC... ANY/ALL CONFLICTS SHALL BE BROUGHT TO THE ATTENTION OF THE JACOBS CM, PRIOR TO BEGINNING ANY WORK.
- MINIMUM WIRE SIZE SHALL BE #12 AWG, NOT INCLUDING CONTROL WIRING, UNLESS NOTED OTHERWISE. ALL CONDUCTORS SHALL BE COPPER WITH THWN INSULATION, UNLESS OTHERWISE NOTED.
- 8. OUTLET BOXES SHALL BE PRESSED STEEL IN DRY LOCATIONS, CAST ALLOY WITH THREADED HUBS IN WET/DAMP LOCATIONS AND SPECIAL ENCLOSURES FOR OTHER CLASSIFIED AREAS.
- 9. IT IS NOT THE INTENT OF THESE PLANS TO SHOW EVERY MINOR DETAIL OF THE CONSTRUCTION. CONTRACTOR IS EXPECTED TO FURNISH AND INSTALL ALL ITEMS FOR A COMPLETE ELECTRICAL SYSTEM AND PROVIDE ALL REQUIREMENTS FOR THE EQUIPMENT TO BE PLACED IN PROPER WORKING ORDER.
- ELECTRICAL SYSTEM SHALL BE AS COMPLETELY AND EFFECTIVELY GROUNDED, AS REQUIRED BY SPECIFICATIONS, SET FORTH BY APPLICANT.
- 11. ALL WORK SHALL BE PERFORMED BY A LICENSED ELECTRICAL CONTRACTOR IN A FIRST CLASS, WORKMANLIKE MANNER. THE COMPLETED SYSTEM SHALL BE FULLY FUNCTIONAL AND SHALL BE APPROVED BY THE JACOBS CM AND LOCAL JURISDICTION. ANY DEFICIENCIES SHALL BE CORRECTED BY AN ELECTRICAL CONTRACTOR AT THE SOLE COST OF THE CONTRACTOR.
- 12. ALL WORK SHALL BE COORDINATED WITH OWNER TRADES TO AVOID INTERFERENCE WITH THE PROGRESS OF CONSTRUCTION.
- 13. THE CORRECTION OF ANY DEFECTS SHALL BE COMPLETED BY THE CONTRACTOR WITHOUT ANY ADDITIONAL CHARGE AND SHALL INCLUDE THE REPLACEMENT OR THE REPAIR OF ANY OTHER PHASE OF THE INSTALLATION, WHICH MAY HAVE BEEN DAMAGED THEREIN.
- 14. CONTRACTOR SHALL PROVIDE AND INSTALL CONDUIT, CONDUCTORS, PULL WIRES, BOXES, COVER PLATES AND DEVICES FOR ALL OUTLETS AS INDICATED.
- 15. DITCHING AND BACK FILL: CONTRACTOR SHALL PROVIDE FOR ALL UNDERGROUND INSTALLED CONDUIT AND/OR CABLES INCLUDING EXCAVATION AND BACKFILLING AND COMPACTION. REFER TO NOTES AND REQUIREMENTS "EXCAVATION, AND BACKFILLING".
- 16. MATERIALS, PRODUCTS AND EQUIPMENT, INCLUDING ALL COMPONENTS THEREOF, SHALL BE NEW AND SHALL APPEAR ON THE LIST OF U.L. APPROVED ITEMS AND SHALL MEET OR EXCEED THE REQUIREMENTS OF THE NEC, NEMA AND IECE.
- 17. CONTRACTOR SHALL SUBMIT SHOP DRAWINGS OR MANUFACTURER'S CATALOG INFORMATION OF ANY/ALL EQUIPMENT AND ALL OTHER ELECTRICAL ITEMS FOR APPROVAL BY THE JACOBS CM PRIOR TO INSTALLATION.
- 18. ANY CUTTING OR PATCHING DEEMED NECESSARY FOR ELECTRICAL WORK IS THE ELECTRICAL CONTRACTORS RESPONSIBILITY AND SHALL BE INCLUDED IN THE COST FOR WORK AND PERFORMED TO THE SATISFACTION OF THE JACOBS CM UPON FINAL ACCEPTANCE.
- 19. THE ELECTRICAL CONTRACTOR SHALL LABEL ALL PANELS WITH ONLY TYPEWRITTEN DIRECTORIES. ALL ELECTRICAL WIRING SHALL BE THE RESPONSIBILITY OF THE ELECTRICAL CONTRACTOR.
- 20. DISCONNECT SWITCHES SHALL BE UL-RATED, H.P. RATED HEAVY-DUTY, QUICK-MAKE AND QUICK-BREAK ENCLOSURES, AS REQUIRED BY EXPOSURE TYPE.
- 21. ALL CONNECTIONS SHALL BE MADE WITH A PROTECTIVE COATING OF AN ANTI-OXIDE COMPOUND KNOWN AS "NO-OXIDE A" BY DEARBORNE CHEMICAL COMPANY. COAT ALL WIRE SURFACES BEFORE CONNECTING, EXPOSED COPPER SURFACES, INCLUDING GROUND BARS, SHALL BE TREATED -- NO SUBSTITUTIONS.



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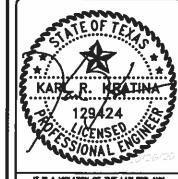
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MRSTX049968 222 PIKE STREET SOUTH PADRE ISLAND, TX 78597 NEW POLE

SHEET TITLE

GENERAL NOTES

SHEET NUMBER

ELECTRICAL NOTES CONT'D:

- 22. RACEWAYS: CONDUIT SHALL BE SCHEDULE 80 PVC MEETING OR EXCEEDING NEMA TC2 1990. CONTRACTOR SHALL PLUG AND CAP EACH END OF SPARE AND EMPTY CONDUITS AND PROVIDE TWO SEPARATE PULL STRINGS 200 LBS TEST POLYETHYLENE CORD. ALL CONDUIT BENDS SHALL BE A MINIMUM OF 2 FT. RADIUS. RGS CONDUITS WHEN SPECIFIED, SHALL MEET UL—8 FOR GALVANIZED STEEL. ALL FITTINGS SHALL BE SUITABLE FOR USE WITH THREADED RIDGED CONDUIT. COAT ALL THREADS WITH "BRITE ZINC" OR "COLD GALV.".
- 23. SUPPORT OF ALL ELECTRICAL WORK SHALL BE AS REQUIRED BY NEC.
- 24. CONDUCTORS: CONTRACTOR SHALL USE 98% CONDUCTIVITY COPPER WITH TYPE THWN INSULATION, UNLESS OTHERWISE NOTED, 800 VOLT, COLOR CODED. USE SOLID CONDUCTORS FOR WIRE UP TO AND INCLUDING NO. 8 AWG. USE STRANDED CONDUCTORS FOR WIRE ABOVE NO. 8 AWG.
- 25. CONNECTORS FOR POWER CONDUCTORS: CONTRACTOR SHALL USE PRESSURE TYPE INSULATED TWIST-ON CONNECTORS FOR NO. 10 AWG AND SMALLER. USE SOLDERLESS MECHANICAL TERMINAL LUGS FOR NO. 8 AWG AND LARGER.
- 28. SERVICE: AS SPECIFIED ON THE DRAWINGS, OWNER OR OWNER'S AGENT WILL 3. APPLY FOR POWER. ALL PROVISIONS FOR TEMPORARY POWER WILL BE OBTAINED BY THE CONTRACTOR.
- 27. TELEPHONE OR FIBER SERVICE: CONTRACTOR SHALL PROVIDE EMPTY CONDUITS WITH PULL STRINGS AS INDICATED ON DRAWINGS.
- 28. ELECTRICAL AND TELCO/FIBER RACEWAYS TO BE BURIED A MINIMUM DEPTH OF 30". UNLESS OTHERWISE NOTED.
- 29. CONTRACTOR SHALL PLACE 6" WIDE DETECTABLE WARNING TAPE AT A DEPTH OF 6" BELOW GROUND AND DIRECTLY ABOVE ELECTRICAL AND TELCO SERVICE CONDUITS. CAUTIONS TAPE TO READ "CAUTION BURIED ELECTRIC" OR BURIED TELECOMM".
- 30. ALL BOLTS SHALL BE 3-16 STAINLESS STEEL.

GROUNDING NOTES:

- ALL HARDWARE SHALL BE 3-16 STAINLESS STEEL, INCLUDING LOCK WASHERS. COAT ALL SURFACES WITH AN ANTI-OXIDANT COMPOUND, AS SPECIFIED, BEFORE MATING. ALL HARDWARE SHALL BE STAINLESS STEEL 3/8 INCH DIAMETER OR LARGER.
- 2. FOR GROUND BOND TO STEEL ONLY: INSERT A CADMIUM FLAT WASHER BETWEEN LUG AND STEEL, COAT ALL SURFACES WITH AN ANTI-OXIDANT COMPOUND BEFORE MATING.
- 3. ALL STEEL CONDUIT SHALL BE BONDED AT BOTH ENDS WITH GROUNDING BUSHING.
- 4. ALL ELECTRICAL AND GROUNDING AT THE POLE SITE SHALL COMPLY WITH THE NATIONAL ELECTRICAL CODE (NEC), NATIONAL FIRE PROTECTION ASSOCIATION (NFPA) 780 (LATEST EDITION), AND MANUFACTURER.
- 5. ALL DETAILS ARE SHOWN IN GENERAL TERMS. ACTUAL GROUNDING INSTALLATION AND CONSTRUCTION MAY VARY DUE TO SITE SPECIFIC CONDITIONS.
- 6. GROUND ALL ANTENNA BASES, FRAMES, CABLE RUNS, AND OTHER METALLIC COMPONENTS USING \$6 GROUND WIRES. FOLLOW ANTENNA AND BTS MANUFACTURER'S PRACTICES FOR GROUNDING REQUIREMENTS.
- 7. ALL GROUND CONNECTIONS SHALL BE #6 AWG, UNLESS OTHERWISE NOTED. ALL WIRES SHALL BE COPPER WITH THINN, UNLESS OTHERWISE NOTED. ALL GROUND WIRE SHALL BE SOUD TIM COATED OR STRANDED GREEN INSULATED WIRE.
- 8. CONTRACTOR TO VERIFY AND TEST GROUND TO SOURCE, 10 OHMS MAXIMUM. PROVIDE SUPPLEMENT GROUNDING RODS AS REQUIRED TO ACHIEVE SPECIFIED OHMS READING. GROUNDING AND OTHER OPTIONAL TESTING WILL BE WITNESSED BY THE JACOBS CM.
- 9. NOTIFY ARCHITECT/ENGINEER IF THERE ARE ANY DIFFICULTIES INSTALLING 5. GROUNDING SYSTEM DUE TO SITE SOIL CONDITIONS.
- 10. ALL HORIZONTALLY RUN GROUNDING CONDUCTORS SHALL BE INSTALLED A MINIMUM OF 30" BELOW GRADE/ 6" BELOW FROST-LINE IN TRENCH, UNLESS OTHERWISE NOTED. BACK FILL SHALL BE COMPACTED AS REQUIRED BY ARCHITECT/ENGINEER.
- 11. ALL GROUND CONDUCTORS SHALL BE RUN AS STRAIGHT AND SHORT AS POSSIBLE, WITH A MINIMUM OF 12" BENDING RADIUS NOT LESS THAN 90 DEGREES.
- 12. ACCEPTABLE CONNECTIONS FOR GROUNDING SYSTEM SHALL BE:
 - A) BURNDY, HY-GRADE U.L. LISTED CONNECTORS FOR OUTDOOR USE OR AS APPROVED BY APPLICANT PROJECT MANAGER.
 - B) CADWELD, EXOTHERMIC WELDS (WELDED CONNECTIONS).
 - C) ONE (1) HOLE TINNED COPPER COMPRESSION (LONG BARREL) FITTINGS.
- 13. ALL CRIMPED CONNECTIONS SHALL HAVE EMBOSSED MANUFACTURER'S DIEMARK VISIBLE AT THE CRIMP (RESULTING FROM USE OF PROPER CRIMPING DEVICES) AND WEATHER-PROOFED WITH HEAT SHRINK.

- 14. ALL CONNECTION HARDWARE SHALL BE TYPE 3-16 STAINLESS STEEL (NOT ATTRACTED TO MAGNETS).
- 15. ELECTRICAL SERVICE EQUIPMENT GROUNDING SHALL COMPLY WITH NEC, ARTICLE 250-82 AND SHALL BOND ALL EXISTING AND NEW GROUNDING ELECTRODES. NEW GROUNDING ELECTRODE SHALL INCLUDE BUT NOT LIMITED TO GROUND RODS.

TESTING AND EQUIPMENT TURN UP REQUIREMENTS:

- 1. RF CABLE, DATA CABLE, RADIO EQUIPMENT AND BACK HAUL EQUIPMENT TESTING WILL COMPLY WITH CURRENT INDUSTRY STANDARDS AND/OR THOSE STANDARDS OF THE EQUIPMENT MANUFACTURER OR PROVIDED TO THE CONTRACTOR PRIOR TO TESTING.
- CONTRACTOR WILL USE THE APPROPRIATE CALIBRATED TESTING EQUIPMENT IN THE
 TESTING OF RF CABLE, DATA CABLE, RADIO EQUIPMENT AND BACK HAUL
 EQUIPMENT THAT MEET INDUSTRY STANDARDS OF THE MANUFACTURER OR THOSE
 STANDARDS PROVIDED TO THE CONTRACTOR PRIOR TO TESTING.
- 3. CONTRACTOR TO VERIFY AND RECORD ALL TEST RESULTS AND PROVIDE THESE RESULTS WITHIN THE FINAL CLOSE OUT PACKAGE.
- 4. ALL PERSONNEL INVOLVED IN THE TESTING OF RF CABLE, DATA CABLE, RADIO EQUIPMENT AND BACK HAUL EQUIPMENT WILL BE REQUIRED TO HAVE BEEN TRAINED AND/OR CERTIFIED IN THE PROPER TESTING OF RF CABLE, DATA CABLE, RADIO EQUIPMENT AND BACK HAUL EQUIPMENT.
- ALL TEST RESULTS SHALL BE TIME STAMPED, RECORDED AND PRESENTED PRIOR TO ENERGIZING AND TURN UP OF ANY EQUIPMENT.
- 6. GPS EQUIPMENT IS NOT TO BE TESTED OR ATTACHED TO ANY CABLING DURING TESTING, DOING SO WILL DAMAGE THE GPS UNIT.
- PRIOR TO TESTING IF THE CONTRACTOR HAS ANY QUESTIONS ABOUT THE TESTING PROCEDURES THEY ARE TO CALL AND OBTAIN ASSISTANCE FROM A QUALIFIED DESIGNATED TESTING REPRESENTATIVE.
- 8. EQUIPMENT IS NOT TO BE ENERGIZED UNTIL ALL TESTING HAS BEEN COMPLETED, APPROVED AND THE APPROPRIATE AUTHORITY HAS BEEN NOTIFIED AND GIVES APPROVAL TO ENERGIZE THE EQUIPMENT.

SITE WORK NOTES:

- DO NOT EXCAVATE OR DISTURB BEYOND THE PROPERTY LINES OR LEASE LINES, UNLESS OTHERWISE NOTED.
- 2. SIZE, LOCATION AND TYPE OF ANY UNDERGROUND UTILITIES OR IMPROVEMENTS SHALL BE ACCURATELY NOTED AND PLACED ON AS-BUILD DRAWINGS BY GENERAL CONTRACTOR AND ISSUED TO ARCHITECT/ENGINEER AT COMPLETION OF PROJECT.
- 3. ALL EXISTING UTILITIES, FACILITIES, CONDITIONS AND THEIR DIMENSIONS SHOWN ON PLANS HAVE BEEN PLOTTED FROM AVAILABLE RECORDS. THE ENGINEER AND OWNER ASSUME NO RESPONSIBILITY WHATSOEVER AS TO THE SUFFICIENCY OR ACCURACY OF THE INFORMATION SHOWN ON THE PLANS OR THE MANNER OF THEIR REMOVAL OR ADJUSTMENT. CONTRACTOR SHALL BE RESPONSIBLE FOR DETERMINING EXACT LOCATION OF ALL EXISTING UTILITIES AND FACILITIES PRIOR TO START OF CONSTRUCTION. CONTRACTOR SHALL ALSO OBTAIN FROM EACH UTILITY COMPANY DETAILED INFORMATION RELATIVE TO WORKING SCHEDULES AND METHODS OF REMOVING OR ADJUSTING EXISTING UTILITIES.
- 4. CONTRACTOR SHALL VERIFY ALL EXISTING UTILITIES BOTH HORIZONTALLY AND VERTICALLY PRIOR TO START OF CONSTRUCTION. ANY DISCREPANCIES OR DOUBTS AS TO THE INTERPRETATION OF PLANS SHALL BE IMMEDIATELY REPORTED TO THE ARCHITECT/ENGINEER OR JACOBS CM FOR RESOLUTION AND INSTRUCTION, AND NO FURTHER WORK SHALL BE PERFORMED UNTIL THE DISCREPANCY IS CHECKED AND CORRECTED BY THE ARCHITECT/ENGINEER. FAILURE TO SECURE SUCH INSTRUCTION MEANS CONTRACTOR WILL HAVE WORKED AT THEIR OWN RISK AND EXPENSE. CONTRACTOR SHALL CALL LOCAL UTILITY LOCATE HOT LINE, SUCH AS 811, FOR UTILITY LOCATIONS A MINIMUM OF 4B HOURS PRIOR TO START OF CONSTRUCTION.
- 5. ALL NEW AND EXISTING STRUCTURES ON SITE AND IN AREAS TO BE DISTURBED BY CONSTRUCTION SHALL BE ADJUSTED TO FINISH ELEVATIONS PRIOR TO FINAL INSPECTION OF WORK. ANY COST RELATED TO ADJUSTING EXISTING STRUCTURES SHALL BE BORNE SOLELY BY THE CONTRACTOR.
- GRADING OF THE SITE WORK AREA IS TO BE SMOOTH AND CONTINUOUS IN SLOPE AND IS TO FEATHER INTO EXISTING GRADES AT THE GRADING LIMITS.
- 7. ALL TEMPORARY EXCAVATIONS FOR THE INSTALLATION OF FOUNDATIONS, UTILITIES, ETC., SHALL BE PROPERLY LAID BACK OR BRACED IN ACCORDANCE WITH CORRECT OCCUPATIONAL SAFETY AND HEALTH ADMINISTRATION (OSHA) REQUIREMENTS.
- 8. STRUCTURAL FILLS SUPPORTING PAVEMENTS SHALL BE COMPACTED TO 95% OF MAXIMUM STANDARD PROCTOR DRY DENSITY, UNLESS OTHERWISE NOTED.
- 9. NEW GRADES NOT IN BUILDING AND DRIVEWAY IMPROVEMENT AREA TO BE ACHIEVED BY FILLING WITH APPROVED CLEAN FILL AND COMPACTED TO 95% OF STANDARD PROCTOR DENSITY.

- 10. ALL FILL SHALL BE PLACED IN UNIFORM LIFTS. THE LIFTS THICKNESS SHOULD NOT EXCEED THAT WHICH CAN BE PROPERLY COMPACTED THROUGHOUT ITS ENTIRE DEPTH WITH THE EQUIPMENT AVAILABLE.
- 11. ANY FILLS PLACED ON EXISTING SLOPES THAT ARE STEEPER THAN 10 HORIZONTAL TO 1 VERTICAL SHALL BE PROPERLY BENCHED INTO THE EXISTING SLOPE AS DIRECTED BY GEOTECHNICAL ENGINEER.
- 12. CONTRACTOR SHALL CLEAN ENTIRE SITE AFTER CONSTRUCTION SUCH THAT NO DEBRIS, PAPER, TRASH, WEEDS, BRUSH, EXCESS FILL, OR ANY OTHER DEPOSITS WILL REMAIN. ALL MATERIALS COLLECTED DURING CLEANING OPERATIONS SHALL BE DISPOSED OF OFF-SITE BY THE GENERAL CONTRACTOR.
- 13. ALL TREES AND SHRUBS WHICH ARE NOT IN DIRECT CONFLICT WITH THE IMPROVEMENTS SHALL BE PROTECTED BY THE GENERAL CONTRACTOR.
- 14. ALL SITE WORK SHALL BE CAREFULLY COORDINATED BY GENERAL CONTRACTOR WITH LOCAL UTILITY COMPANY, TELEPHONE COMPANY, AND ANY OTHER UTILITY COMPANIES HAVING JURISDICTION OVER THIS LOCATION.

ENVIRONMENTAL NOTES:

- ALL WORK PERFORMED SHALL BE DONE IN ACCORDANCE WITH ISSUED PERMITS.
 THE CONTRACTOR SHALL BE RESPONSIBLE FOR PAYMENT OF FINES AND PROPER
 CLEAN UP FOR AREAS IN VIOLATION.
- CONTRACTOR SHALL BE RESPONSIBLE FOR CONSTRUCTION AND MAINTENANCE OF EROSION AND SEDIMENTATION CONTROLS DURING CONSTRUCTION FOR PROTECTION OF ADJACENT PROPERTIES, ROADWAYS AND WATERWAYS, ALL EROSION AND SEDIMENTATION CONTROLS SHALL BE MAINTAINED IN PLACE THROUGH FINAL JURISDICTIONAL INSPECTION AND RELEASE OF SITE.
- CONTRACTOR SHALL INSTALL/CONSTRUCT ALL NECESSARY SEDIMENT/SILT CONTROL FENCING AND PROTECTIVE MEASURES AS REQUIRED BY THE LOCAL JURISDICTION WITHIN THE LIMITS OF SITE DISTURBANCE PRIOR TO CONSTRUCTION.
- 4. NO SEDIMENT SHALL BE ALLOWED TO EXIT THE PROPERTY. THE CONTRACTOR IS RESPONSIBLE FOR TAKING ADEQUATE MEASURES FOR CONTROLLING EROSION. ADDITIONAL SEDIMENT CONTROL FENCING MAY BE REQUIRED IN ANY AREAS SUBJECT TO EROSION.
- 5. THE CONTRACTOR IS RESPONSIBLE FOR MAINTAINING POSITIVE DRAINAGE ON THE SITE AT ALL TIMES WITH SILT AND EROSION CONTROL MEASURES MAINTAINED ON THE DOWNSTREAM SIDE OF SITE DRAINAGE. ANY DAMAGE TO ADJACENT PROPERTY AS A RESULT OF EROSION WILL BE CORRECTED AT THE CONTRACTORS EXPENSE.
- CONTRACTOR SHALL BE RESPONSIBLE FOR DAILY INSPECTIONS AND ANY REPAIRS OF ALL SEDIMENT CONTROL MEASURES INCLUDING SEDIMENT REMOVAL AS NECESSARY.
- CLEARING OF VEGETATION AND TREE REMOVAL SHALL BE ONLY AS PERMITTED AND BE HELD TO A MINIMUM. ONLY TREES NECESSARY FOR CONSTRUCTION OF THE FACILITIES SHALL BE REMOVED.
- 8. SEEDING AND MULCHING AND/OR SODDING OF THE SITE WILL BE ACCOMPLISHED AS SOON AS POSSIBLE AFTER COMPLETION OF THE PROJECT FACILITIES AFFECTING LAND DISTURBANCE.
- 9. CONTRACTOR SHALL PROVIDE ALL EROSION AND SEDIMENTATION CONTROL MEASURES AS REQUIRED BY LOCAL, COUNTY AND STATE CODES AND ORDINANCES TO PROTECT EMBANKMENTS FROM SOIL LOSS AND TO PREVENT ACCUMULATION OF SOIL AND SILT IN STREAMS AND DRAINAGE PATHS LEAVING THE CONSTRUCTION AREA. THIS MAY INCLUDE, BUT IS NOT LIMITED TO SUCH MEASURES AS SILT FENCES, STRAW BALE SEDIMENT BARRIERS, AND CHECK DAMS.
- 10. RIP RAP OF SIZES INDICATED SHALL CONSIST OF CLEAN, HARD, SOUND, DURABLE, UNIFORM IN QUALITY STONE FREE OF ANY DETRIMENTAL QUANTITY OF SOFT, FRIABLE, THIN, ELONGATED OR LAMINATED PIECES, DISINTEGRATED MATERIAL, ORGANIC MATTER, OIL, ALKALI, OR OTHER DELETERIOUS SUBSTANCES.
- 11. GENERAL CONTRACTOR TO PLACE MATERIAL AT ALL CATCH BASINS ADJACENT TO CONSTRUCTION SITE TO PREVENT SOLID WASTE CONTAMINATION FROM ENTERING SEWER SYSTEM.



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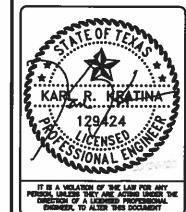
Jacoba Telecommunications, Inc. FIRM F-181 I 0 544B BELLS FERRY ROAD, ACWORTH, GA 30102 PHONE 470-785-4050 FAX: 770-701-2501

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FOR REVIEW

MRSTX049968 222 PIKE STREET SOUTH PADRE ISLAND, TX 78597 NEW POLE

SHEET TITLE

GENERAL NOTES

SHEET NUMBER

FOUNDATION, EXCAVATION AND BACKFILL NOTES:

- ALL FINAL GRADED SLOPES SHALL BE A MAXIMUM OF 3 HORIZONTAL TO 1 VERTICAL, UNLESS OTHERWISE NOTED.
- 2. BACKFILL OF POLE SHALL BE PERFORMED IN ONE (1) OF THREE (3) OPTIONS:
 - A) PREFERRED: RAINBOW INDUSTRIES POLE SETTING FOAM SHALL BE INSTALLED PER MANUFACTURER SPECS. FOAM SHALL ALWAYS BE USED FRO POOR SOILS. B) SECONDARY: CONCRETE (REQUIRES JACOBS CM WRITTEN APPROVAL) ALLOWABLE SOIL PRESSURE = 2000 PSF (ASSUMED). NON-NATIVE SOILS SHALL BE REMOVED FROM BORE AREA AND SHALL NOT BE REUSED FOR BACKFILL.
- 3. ALL EXCAVATIONS PREPARED FOR PLACEMENT OF CONCRETE SHALL BE OF UNDISTURBED SOILS, SUBSTANTIALLY HORIZONTAL AND FREE FROM ANY LOOSE, UNSUITABLE MATERIAL OR FROZEN SOILS, AND WITHOUT THE PRESENCE OF POUNDING WATER. DEWATERING FOR EXCESS GROUND WATER SHALL BE PROVIDED WHEN REQUIRED. COMPACTION OF SOILS UNDER CONCRETE PAD FOUNDATIONS SHALL NOT BE LESS THAN 95% OF THE MODIFIED PROCTOR MAXIMUM DRY DENSITY FOR THE SOIL IN ACCORDANCE WITH ASTM D1557.
- 4. CONCRETE FOUNDATIONS SHALL NOT BE PLACED ON ORGANIC OR UNSUITABLE MATERIAL. IF ADEQUATE BEARING CAPACITY IS NOT ACHIEVED AT THE DESIGNED EXCAVATION DEPTH, THE UNSATISFACTORY SOIL SHALL BE EXCAVATED TO ITS FULL DEPTH AND EITHER BE REPLACED WITH MECHANICALLY COMPACTED GRANULAR MATERIAL OR THE EXCAVATION SHALL BE FILLED WITH CONCRETE OF THE SAME TYPE SPECIFIED FOR THE FOUNDATION. CRUSHED STONE MAY BE USED TO STABILIZE THE BOTTOM OF THE EXCAVATION. ANY STONE SUB BASE MATERIAL, IF USED, SHALL NOT SUBSTITUTE FOR REQUIRED THICKNESS OF CONCRETE.
- 5. ALL EXCAVATIONS SHALL BE CLEAN OF UNSUITABLE MATERIAL SUCH AS VEGETATION, TRASH, DEBRIS, AND SO FORTH PRIOR TO BACK FILLING. BACK FILL SHALL CONSIST OF APPROVED MATERIALS SUCH AS EARTH, LOAM, SANDY CLAY, SAND AND GRAVEL, OR SOFT SHALE, FREE FROM CLODS OR LARGE STONES OVER 2 1/2" MAX DIMENSIONS. ALL BACK FILL SHALL BE PLACED IN COMPACTED LAYERS.
- 6. ALL FILL MATERIALS AND FOUNDATION BACK FILL SHALL BE PLACED IN MAXIMUM 6" THICK LIFTS BEFORE COMPACTION. EACH LIFT SHALL BE WETTED IF REQUIRED AND COMPACTED TO NOT LESS THAN 95% OF THE MODIFIED PROCTOR MAXIMUM DRY DENSITY FOR SOIL IN ACCORDANCE WITH ASTM D1557.
- NEWLY PLACED CONCRETE FOUNDATIONS SHALL CURE A MINIMUM OF 72 HOURS PRIOR TO BACK FILLING.
- 8. FINISHED GRADING SHALL BE SLOPED TO PROVIDE POSITIVE DRAINAGE AND PREVENT STANDING WATER. THE FINAL (FINISH) ELEVATION OF SLAB FOUNDATIONS SHALL SLOPE AWAY IN ALL DIRECTIONS FROM THE CENTER. FINISH GRADE OF CONCRETE PADS SHALL BE A MAXIMUM OF 4 INCHES ABOVE FINAL FINISH GRADE ELEVATIONS WHERE REQUIRED.
- 9. NEWLY GRADED GRAVEL SURFACE AREAS TO RECEIVE GRAVEL SHALL BE COVERED WITH GEOTEXTILE FABRIC TYPE: TYPAR—3401 AS MANUFACTURED BY TYPAR GEOSYNTHETICS OR AN APPROVED EQUIVALENT, SHOWN ON PLANS. THE GEOTEXTILE FABRIC SHALL BE BLACK IN COLOR TO CONTROL THE RECURRENCE OF VEGETATIVE GROWTH AND EXTEND TO WITHIN 1 FOOT OUTSIDE THE SITE FENCING OR ELECTRICAL GROUNDING SYSTEM PERIMETER WHICH EVER IS GREATER. ALL FABRIC SHALL BE COVERED WITH A MINIMUM OF 4" DEEP COMPACTED STONE OR GRAVEL AS SPECIFIED. I.E. DOT TYPE NO. 57 FOR FENCED COMPOUND: DOT TYPE NO. 67 FOR ACCESS DRIVE AREA, UNLESS OTHERWISE NOTED.
- 10. IN ALL AREAS TO RECEIVE FILL: REMOVE ALL VEGETATION, TOPSOIL, DEBRIS, WET AND UNSATISFACTORY SOIL MATERIALS, OBSTRUCTIONS, AND DELETERIOUS MATERIALS FROM GROUND SURFACE. PLOW STRIP OR BREAK UP SLOPED SURFACES STEEPER THAN 1 VERTICAL TO 4 HORIZONTAL SUCH THAT FILL MATERIAL WILL BIND WITH EXISTING/PREPARED SOIL SURFACE.
- 11. WHEN SUB GRADE OR PREPARED GROUND SURFACE HAS A DENSITY LESS THAN THAT REQUIRED FOR THE FILL MATERIAL, SCARIFY THE GROUND SURFACE TO DEPTH REQUIRED. PULVERIZE, MOISTURE—CONDITION AND/OR AERATE THE SOILS AND RECOMPACT TO THE REQUIRED DENSITY PRIOR TO PLACEMENT OF FILLS.
- 12. IN AREAS WHICH EXISTING GRAVEL SURFACING IS REMOVED OR DISTURBED DURING CONSTRUCTION OPERATIONS, REPLACE GRAVEL SURFACING TO MATCH ADJACENT GRAVEL SURFACING AND RESTORED TO THE SAME THICKNESS AND COMPACTION AS SPECIFIED. ALL RESTORED GRAVEL SURFACING SHALL BE FREE FROM CORRUGATIONS AND WAVES.

- 13. EXISTING GRAVEL SURFACING MAY NOT BE REUSED.
- 14. GRAVEL SUB SURFACE SHALL BE PREPARED TO REQUIRED COMPACTION AND SUB GRADE ELEVATIONS BEFORE GRAVEL SURFACING IS PLACED AND/OR RESTORED. ANY LOOSE OR DISTURBED MATERIALS SHALL BE THOROUGHLY COMPACTED AND ANY DEPRESSIONS IN THE SUB GRADE SHALL BE FILLED AND COMPACTED WITH APPROVED SELECTED MATERIAL. GRAVEL SURFACING MATERIAL SHALL NOT BE USED FOR FILLING DEPRESSIONS IN THE SUB GRADE.
- 15. PROTECT EXISTING GRAVEL SURFACING AND SUB GRADE IN AREAS WHERE EQUIPMENT LOADS WILL OPERATE. USE PLANKING "MATTS" OR OTHER SUITABLE PROTECTION DESIGNED TO SPREAD EQUIPMENT LOADS AS MAY BE NECESSARY. REPAIR ANY DAMAGE TO EXISTING GRAVEL SURFACING OR SUB GRADE WHERE SUCH DAMAGE IS DUE TO THE CONTRACTORS OPERATIONS.
- 16. DAMAGE TO EXISTING STRUCTURES AND/OR UTILITIES RESULTING FROM CONTRACTORS NEGLIGENCE SHALL BE REPAIRED AND/OR REPLACED TO THE OWNERS SATISFACTION AT NO ADDITIONAL COST TO THE CONTRACT.
- 17. ALL SUITABLE BURROW MATERIAL FOR BACK FILL OF THE SITE SHALL BE INCLUDED IN THE BID. EXCESS TOPSOIL AND UNSUITABLE MATERIAL SHALL BE DISPOSED OF OFF-SITE AT LOCATIONS APPROVED BY GOVERNING AGENCIES AT NO ADDITIONAL COST TO THE CONTRACT.

PEDESTAL GENERAL CONDITION NOTES:

THE POWER COMPANY WILL BE RESPONSIBLE FOR:

- A. SPECIFYING THE METER PEDESTAL LOCATION.
- B. INSTALLING AND REMOVING THE METER.
- C. PROVIDING AND INSTALLING THE UNDERGROUND SERVICE LATERAL CONDUCTORS.

THE CUSTOMER WILL BE RESPONSIBLE FOR:

- A. PROVIDING AND INSTALLING THE METER PEDESTAL
- B. PROVIDING AND INSTALLING THE METER BASE.
- C. PROVIDING AN ADEQUATE GROUND TO THE SERVICE EQUIPMENT DISCONNECT DEVICE. GROUND IN ACCORDANCE WITH ARTICLE 250 OF THE NATIONAL ELECTRICAL CODE (NEC).
- D. SECURELY INSTALLING THE METER PEDESTAL AS SHOWN.
- E. SECURELY MOUNTING THE METER BASE IN A LEVEL AND PLUMB POSITION. METER MUST FACE THE STREET OR ACCESS WALKWAY.
- F. PROVIDING AND INSTALLING THE SERVICE EQUIPMENT DISCONNECT DEVICE.
- G. PROVIDING SERVICE ENTRANCE CONDUCTORS OF SUFFICIENT AMPACITY TO SERVE THE CONNECTED LOAD ACCORDING TO THE CURRENT NEC.

PEDESTAL GENERAL CONSTRUCTION NOTES:

- 1. CUSTOMER IS TO SIZE GROUND WIRE ACCORDING TO NEC REQUIREMENTS.
- 2. BURIAL DEPTH IS THE DISTANCE BETWEEN FINAL GRADE AND THE TOP OF THE BURIED CABLE OR CONDUIT. THE POWER COMPANY SHALL SPECIFY THE REQUIRED BURIAL DEPTH TO CONFORM TO LOCAL REQUIREMENTS. THE BURIAL DEPTH SHALL NOT BE LOESS THAN 2'-6". ARKANSAS, OKLAHOMA, LOUISIANA, AND TEXAS SHALL NOT BE LESS THAN 3'-0". IF ADDITIONAL CONDUIT IS REQUIRED TO CLEAR OBSTRUCTIONS. REFER TO POWER COMPANY FOR APPROVED USAGE.
- 3. BURIAL DEPTH TO COMPLY WITH LOCAL CODES. 2'-0" MIN. IS CONSIDERED ADEQUATE BY ARTICLE 330-5 OF THE NEC. A GROUNDING AS WELL AS A GROUNDED CONDUCTOR MUST EXTEND BETWEEN POLE AND ITS ADJACENT SERVICE EQUIPMENT. THE GROUNDING AND GROUNDED CONDUCTORS ARE BONDED TOGETHER ONLY ON THE SUPPLY SIDE OF THE SERVICE DISCONNECT DEVICE. REFER TO ARTICLE 550 OF THE NEC GROUNDING.



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MRSTX049968 222 PIKE STREET SOUTH PADRE ISLAND, TX 78597 NEW POLE

SHEET TITLE

GENERAL NOTES

SHEET NUMBER

City of South Padre Island Easement or Right of Way Application



	Physical Address:222 Pike Street 78597
Property Owner Information:	Contractor Information:
Name:	Name: Kari Colley
Mailing Address	Mailing Address 1704 Highview
City, State, Zip Phone Number:	City, State, Zip Arlington, TX 76013 Phone Number: (817) 681-4173
Fax Number	Fax Number N/A
E:mail Address:	E:mail Address: kari.colley@jacobs.com
110000	
Owner Signature:	Contractor Signature:
Date:	Date: 6/29/20
Name and phone number of responsible party availal	ble 94 been a devilence of account
Name and phone number of responsible party available	Die 24 nrs. a day incase of emergency:
Name:Juan Carrillo	
Phone Number:_(956) 535-1098	
License and Permit Bond (X) Yes () No (one is require	ad)
PLEASE NOTE: If a TXDOT Permit is required, a ROW	Permit cannot be issued unit TXDOT Permit has been approved first.
1	Permit Type
☐ Easement ☐ TXDOT ROW	X☐ City Right of Way
	☐ Open Cut ☐ Bore
	•
TYPE O	F CONSTRUCTION
□ Utility □ Driveway □ Sidewalk □ Repair	
·	
NOTICE: Please attach a dimensional site plan indicating	the existing and proposed improvements
Description Install new wood pole with nety	work node in city ROW with backhaul equipment
Minimal Sita Plan Information (Chapter 46)	
Minimal Site Plan Information (Chapter 16)	
X	
	atro at and aldered le
X	street and sidewalk
because and description of existing	
El coodion and description of existing	
X Depth of proposed utility line (standa	
Exact date the work shall take place	and length of time
X	-
X	vs and sidewalk (see
Conditions:	
 Call 811 and LMWD to locate and coordination 	on
	by any work shall be restored to as good or better
3. Condition than existed immediate prior to any	y work or excavation
	der to have repaired any damages to street of the
	upplies to construction site, or by the operation
of equipment, and said permit holder shall m	
provided by the City.	ave rehairs in the mainter and fittle hetiods
	Francis to the state of the sta
5. Non-rubber wheeled vehicles are prohibited	
or operated upon any paved street within the	City.
ADDDOVED.	
APPROVED:	APPROVED AS NOTED:
RESUBMIT:	

IF YOU DIG IN ANY STATE
DIAL 811 FOR THE LOCAL
"ONE CALL CENTER" —
IT'S THE LAW

THE UTILITIES SHOWN HEREIN ARE FOR THE CONTRACTORS CONVENIENCE ONLY. THERE MAY BE OTHER UTILITIES NOT SHOWN ON THESE PLANS. THE ENCHMERT/SURVEYOR ASSUMES NO RESPONSIBILITY FOR THE LOCATIONS SHOWN AND IT SHALL BE THE CONTRACTOR'S RESPONSIBILITY TO VEHILY ALL THE LITLISES WITHIN THE LIMITS OF THE WORK, ALL DAMACE MADE TO THE (5) UTILITIES BY THE CONTRACTOR SHALL BE THE SOLE RESPONSIBILITY OF THE CONTRACTOR SHALL BE THE



PACE JOB NUMBER:
MRSTX049968
SCIP ID:
18627-050
LATITUDE/LONGITUDE:
26.102579/-97.168108

ADDRESS:

222 PIKE STREET SOUTH PADRE ISLAND, TX 78597

DO NOT SCALE DRAWINGS

CONTRACTORS SHALL VERIFY ALL PLANS, (E) DIMENSIONS & FIELD CONDITIONS ON THE JOB SITE & SHALL IMMEDIATELY NOTIFY THE ARCHITECT/ENGINEER IN WRITING OF ANY DISCREPANCIES BEFORE PROCEEDING WITH THE WORK OR BE RESPONSIBLE FOR SAME.

GENERAL NOTES

THE FACILITY IS UNMANNED AND NOT FOR HUMAN HABITATION, A TECHNICIAN WILL VISIT THE SITE AS REQUIRED FOR ROUTINE MAINTENANCE. THE PROJECT WILL NOT RESULT IN ANY SIGNIFICANT DISTURBANCE OF EFFECT ON DRAINAGE; NO SANITARY SEWER SERVICE, POTABLE WATER OR TRASH DISPOSAL IS REQUIRED AND NO COMMERCIAL SIGNAGE IS PROPOSED.

PRIOR TO ANY CONSTRUCTION WORK, CONTRACTOR SHALL LOCATE ALL UNDERGROUND UTILITIES. ALL UTILITIES SHALL BE MARKED.

THIS DESIGN IS SUBJECT TO ANY JURISDICTIONAL AND OWNER APPROVALS INCLUDING JURISDICTIONAL REQUIREMENTS, RF EQUIPMENT CONFIGURATION, AND FINAL UTILITY COORDINATION WITH PUBLIC POWER AND UTILITY PROVIDERS/ CONTRACTOR TO CONFIRM FINAL REQUIREMENTS WITH OWNER.

SITE INFORMATION		
PACE JOB NUMBER	MRSTX049968	
LATITUDE:	26.102579	
LONGITUDE:	-97.168108	
CROSS STREET:	PIKE ST. & LAGUNA BLVD.	
CITY, STATE, ZIP:	SOUTH PADRE ISLAND, TX 78597	
COUNTY:	CAMERON	
JURISDICTION:	CITY OF SOUTH PADRE ISLAND	
PROPERTY OWNER:	PUBLIC RIGHT-OF-WAY	
APPLICANT:	JACOBS 5995 ROGERDALE ROAD 77072 HOUSTON, TEXAS 77052-3495 CONTACT: PHONE: (832)351-6000	

ENGINEER

MC2 ENGINEERING AND CONSTRUCTION, P.C. 2204 TIMBERLOCH PL. STE 150 SPRING, TEXAS 77380 CONTACT: MEGAN L. CROW PE SERIAL NUMBER 107989 TEL: (307) 673-7350 TEYAS FIRM F-18535



PROJECT DESCRIPTION

END USER PROPOSES TO INSTALL EQUIPMENT ON A NEW WOOD POLE WITHIN AN EXISTING RIGHT-OF-WAY. THE SCOPE WILL CONSIST OF THE FOLLOWING:

- INSTALL A NEW WOOD UTILITY POLE WITH PROPOSED BACKHAUL TRANSPORT EQUIPMENT

CODES

INTERNATIONAL BUILDING CODE NATIONAL ELECTRICAL SAFETY CODE TIA/EIA-222-G-2 OR LATEST EDITION LOCAL BUILDING/PLANNING CODE

	DRAWING INDEX
SHEET NO:	SHEET TITLE
T-1	TITLE SHEET
SP-1	SITE PLAN W/IMAGERY
EV-1	POLE ELEVATIONS
PL-1	PLUMBING DIAGRAM
EQ-1	EQUIPMENT DETAILS
TC-1	VEHICULAR TRAFFIC CONTROL PLAN
TC-2	PEDESTRIAN SAFETY PLAN
GN-1	GENERAL NOTES
GN-2	GENERAL NOTES
GN-3	GENERAL NOTES



JACOBS

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1	PACE JOB NO:	MRSTXD49968
	DRAWN BY:	KAH
ı	CHECKED BY:	MC

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	MEGAN L. CROW 107989 CENSE SIONAL ENGLES
Γ	MC2 ENGINEERING AND CONSTRUCTION, P.C.

MRSTX049968


18627-050 222 PIKE STREET SOUTH PADRE ISLAND, TX 78597 UTILITY POLE

SHEET TITLE

TITLE SHEET

SHEET NUMBER

T-1

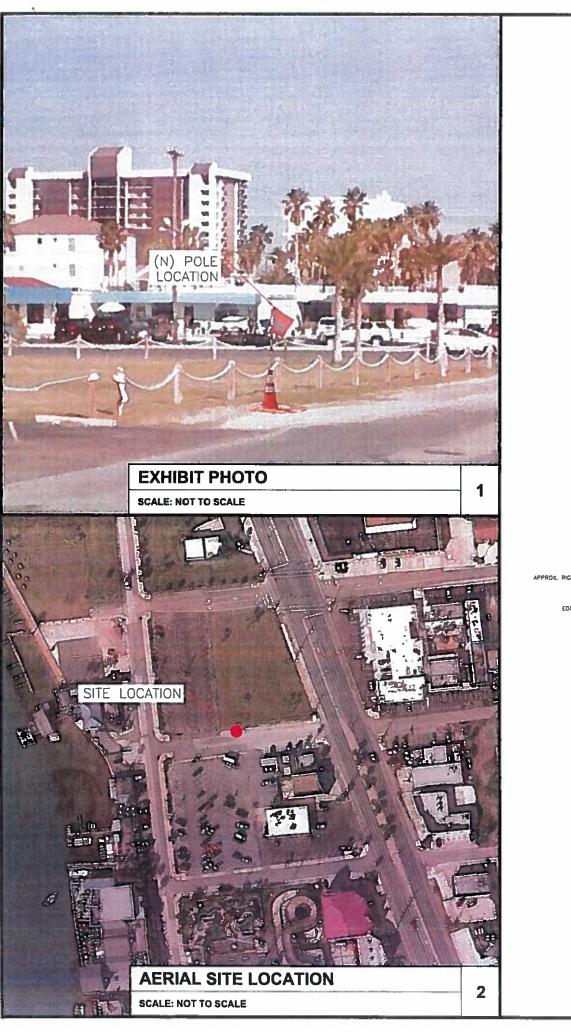





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CHECKED BY: MC

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PERSON, UNICES THEY ARE ACTING UNDER THE DIRECTION OF A LEGENSED PROFESSIONAL ENGINEER, TO ALTER THIS DOCUMENT

MEGAN L. CROW
107989
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HAS NOT PERFORMED A STRUCTURAL
EVALUATION OR FOUNDATION DESIGN OF THIS
PROJECT.

MRSTX049968 18627-050 222 PIKE STREET SOUTH PADRE ISLAND, TX 78597 UTILITY POLE

SHEET TITLE

CONDITIONS.

ENLARGED SITE PLAN

SCALE:

THIS INCLUDES USING SOD TO REPLACE

EXISTING LANDSCAPE.


IF ADJACENT SIDEWALK MUST BE REMOVED AND REPLACED.


SITE PLAN W/ IMAGERY

SHEET NUMBER

3

SP-1

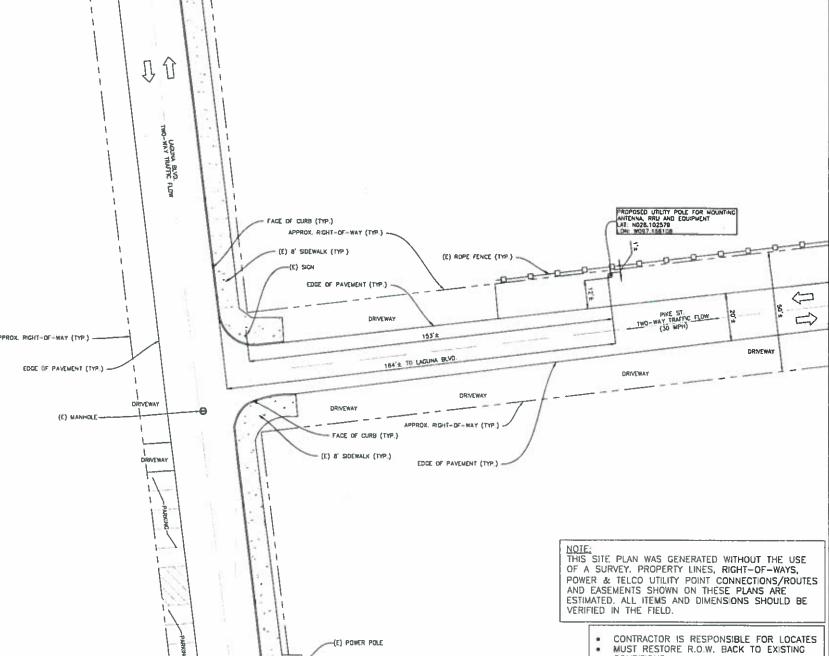

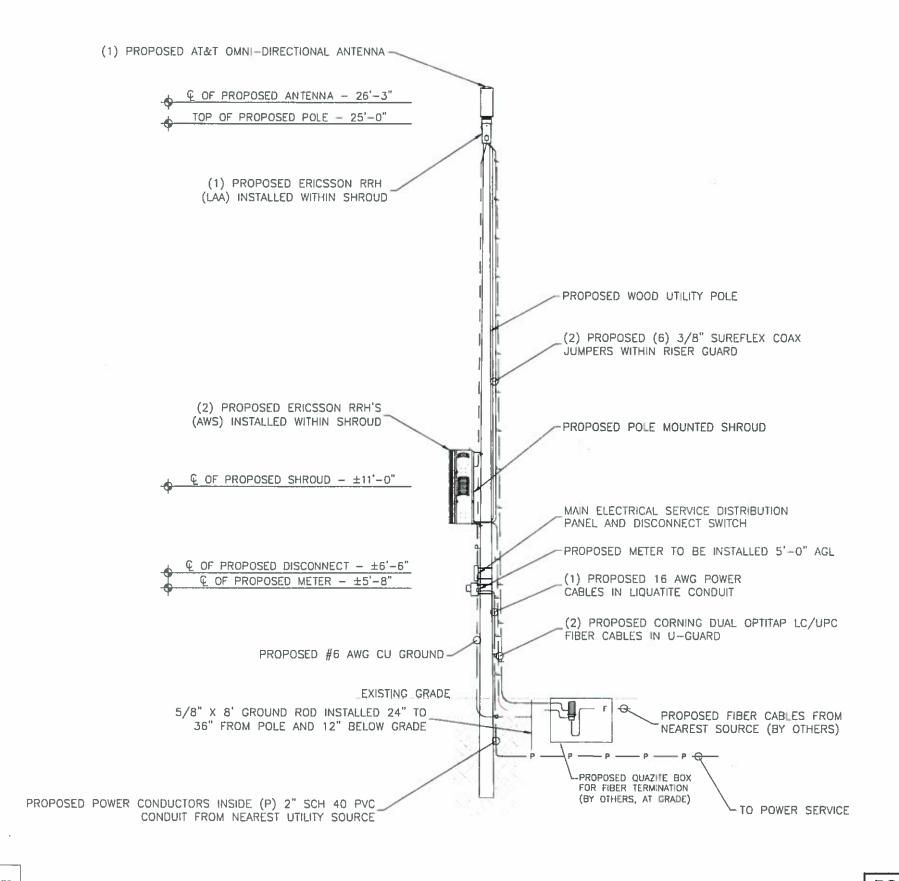



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PACÉ JOB NO:

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FOR REVIEW

MRSTX049968 18627-050 222 PIKE STREET SOUTH PADRE ISLAND, TX 78597 UTILITY POLE

SHEET TITLE

POLE ELEVATIONS

EV-1

NOIE: REFER TO STRUCTURAL ANALYSIS REPORT (SEPARATE DOCUMENT) FOR ADDITIONAL STRUCTURAL INFORMATION.

POLE ELEVATIONS

SCALE: NOT TO SCALE

(1) PROPOSED AT&T OMNI-DIRECTIONAL ANTENNA

PROPOSED WOOD

PROPOSED POLE

MOUNTED SHROUD

MAIN ELECTRICAL

PANEL AND

SERVICE DISTRIBUTION

PROPOSED METER-

EXISTING GRADE

DISCONNECT SWITCH

UTILITY POLE

NOTE: CABLING DIAGRAM IS FOR CLARITY OF CABLE ROUTE AND TERMINATION ONLY. CONTRACTOR SHALL INSTALL CABLES WITH MINIMAL VISUAL IMPACT ON (N) WOOD POLE. SEE ELEVATION DRAWING FOR EQUIPMENT AND ANTENNA LOCATIONS.

CABLING NOTES:

- A) WOOD, CONCRETE AND EXISTING METALLIC POLES I) FROM GRADE LINE TO 11'-0" ABOVE GRADE, ALL CABLES/CONDUCTORS EXCEPT GROUNDING CONDUCTOR MUST RUN IN RIGID GALVANIZED STEEL CONDUIT (RGS)
- II) GROUNDING CONDUCTORS IN EXPOSED LOCATIONS MUST BE INSTALLED IN PVC.
- III) IN EARTH INSTALL PVC CONDUIT FOR BACKHAUL AND ELECTRICAL SERVICE. TRANSITION TO RGS AT GRADE LINE.
- IV) ABOVE 11'-0" ALL CABLES (POWER, ETHERNET, COAXIAL) MUST RUN IN PVC UTILITY POLE RISER.
- (1) AT MAJOR EQUIPMENT, EXTEND UTILITY DUCT IMMEDIATELY ADJACENT TO THE EQUIPMENT. INSTALL CABLES IN THE UTILITY POLE RISER CREATING CABLE DRIP LOOPS NOT LESS THAN THE CABLE BENDING RADIUS.
- (2) INSIDE THE UTILITY POLE RISER, UTILIZE 1/2" COAX BLOCKS WITH LAG SCREWS TO SUPPORT COAX, RADIO AND MW POWER, RF COAX, AND ETHERNET CABLES TO WITHIN 12" OF THE EQUIPMENT BEING SERVED AND ON INTERVALS NOT TO EXCEED 6'.
- V) FOR UNDERGROUND HFC/PUBLIC BACKHAUL, ROUTE ETHERNET CABLE IN CONDUIT UP THE POLE AND ENTER THE UTILITY POLE RISER. SEAL EXPOSED END OF CONDUIT WITH A CABLE TERMINATION FITTING.
- VI) BY APPROVAL IN SELECT CASES LIQUID-TIGHT FLEXIBLE METALLIC CONDUIT (LFMC) MAY BE USED IN LENGTHS NOT TO EXCEED 36" TO EXTEND THE ELECTRICAL SERVICE CONDUIT TO THE AC DISTRIBUTION BOX. EXAMPLE: UTILITY-REQUIRED DISCONNECT ON POLE W/ AC DISTRIBUTION BOX ON OPPOSITE SIDE OF POLE.
- B) NEW METALLIC POLES
- i) PROCURE NEW POLES WITH SUITABLE HAND HOLES SUCH THAT HAND HOLES EXIST AT ALL EQUIPMENT
- (1) WITH CLIENT APPROVAL IN SELECT CASES TO FACILITATE IMPROVED APPEARANCE, 1/2" COAXIAL CABLES MAY BE "SUPERFLEX" IN LIEU OF LDF-4.
- II) WHERE POSSIBLE, INSTALL POLE BASE SUCH THAT THE ELECTRICAL FEED AND BACKHAUL (IF UNDERGROUND) CIRCUIT ENTER THE POLE THROUGH THE POLE BASE. IF A DISCONNECTING MEANS SEPARATE FROM THE AC DISTRIBUTION BOX IS REQUIRED BY JURISDICTION OR UTILITY, WITH APPROVAL IN SELECT CASES LIQUID-TIGHT FLEXIBLE METALLIC CONDUIT (LFMC) MAY BE USED IN LENGTHS NOT TO EXCEED 36" TO EXTEND THE ELECTRICAL SERVICE CONDUIT TO THE AC DISTRIBUTION BOX.

CABLING DIAGRAM W/ NOTES


SCALE: NOT TO SCALE

			BILL OF MATERIALS				
QTY.	DESCRIPTION	MANUFACTURER	MODEL NUMBER	AZIMUTH	CABLE	DIMENSIONS (HxWxD)	WEIGHT
1	ANTENNA	GAMMA NU	CANNISTER 12 PORT W/ BRACKET	0,	25'±	29.8" X 7.9" DIAMETER	-
2	CAUTION SIGN	-	NO1-DC-16: NOTICE DECAL 6X1	-	-	6" X 1"	-
1	TOP MOUNT	CHARLES IND. LTD.	97-002356G-A	-	+	_	-
1	SHROUD	CHARLES IND. LTD.	SHRDI-3818AVCXX	-	-	36" X 18.75" X 12"	
3	RADIO	ERICSSON	2203	-	3'±	7.87" X 7.87" X 3.94"	9.92 LBS
1	SHROUD	CHARLES IND. LTD.	SHRD60-051D6GN1	-	-	46.1" X 13.5" X 14.3"	55 LBS
1	AC DISTRIBUTION PANEL	RAYCAP	RCAB-9589-P-120	_	1'±	36" X 26" X 10"	124 LBS
1	NEMA TYPE-3R DISCONNECT	SIEMENS	GF222NR (EXAMPLE)	-	1'±	15.45" X 8.7" X 5.95"	14 LBS
1	METER SOCKET	MILBANK .	RINGLESS METER	-	_	15.5" X 13" X 4.84"	21 LBS
	_	_		- 1	-	_	-

RFDS REVISION TYPE: NOT FINAL RFDS REVISION NUMBER: RFDS REVISION TIMESTAMP: N/A

BILL OF MATERIALS

SCALE: NOT TO SCALE

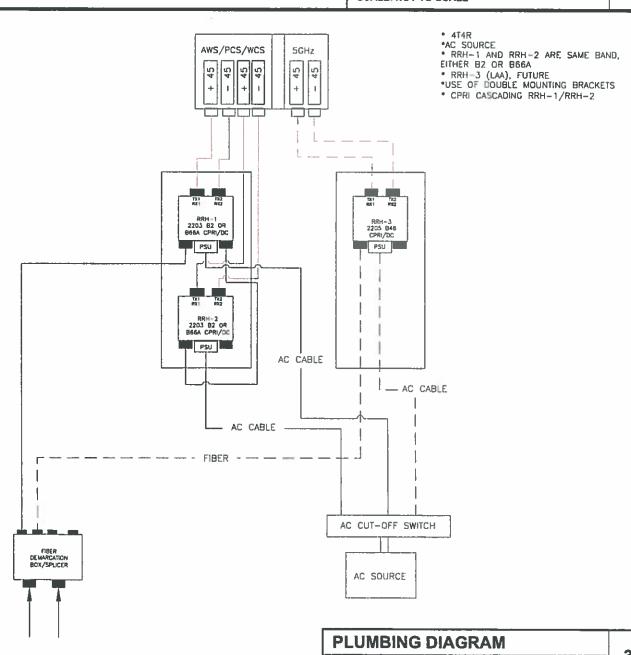

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JACOBS

PACE JOB NO:

P.O. BOX 53495 HOUSTON, TEXAS 77052-3495 UNITED STATES PHONE: (832)351-6000

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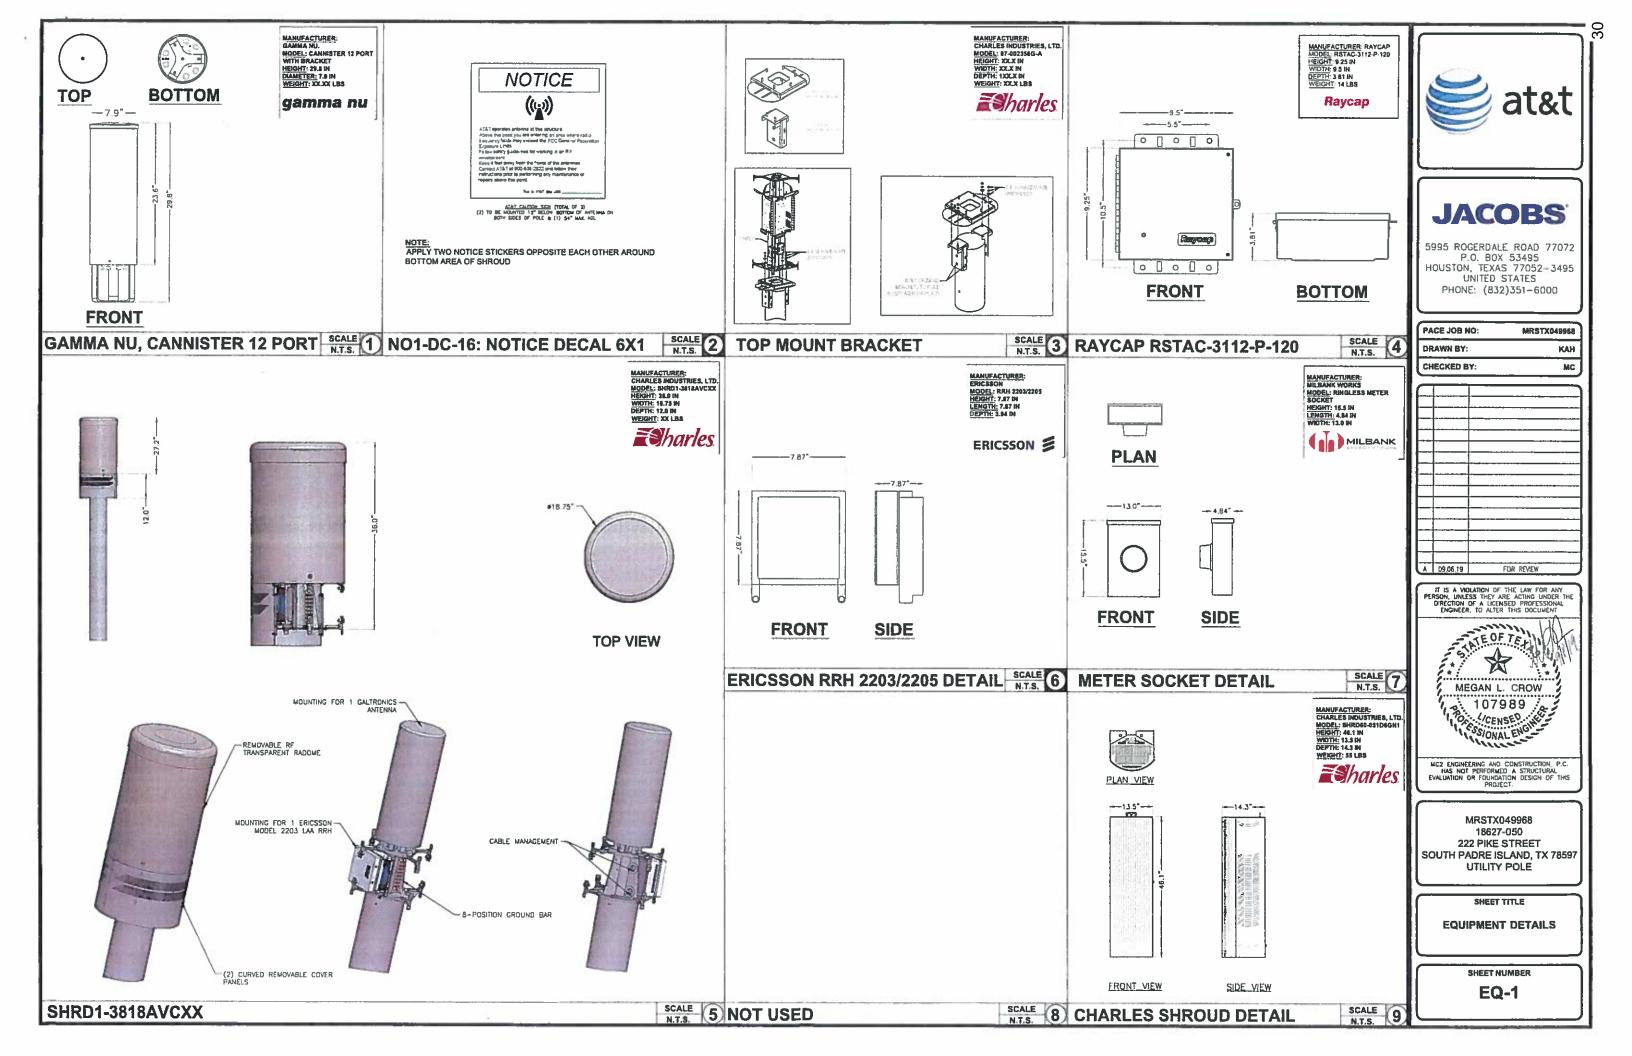
IT IS A VIOLATION OF THE LAW FOR ANY PERSON, UNLESS THEY ARE ACTING UNDER THE DIRECTION OF A LICENSED PROFESSIONAL ENGINEER, TO ALTER THIS DOCUMENT TEOFTE MEGAN L. CROW 107989 CENSED STORAGE MC2 ENGINEERING AND CONSTRUCTION, P.C. HAS NOT PERFORMED A STRUCTURAL EVALUATION OR FOUNDATION DESIGN OF THIS PROJECT.

MRSTX049968 18627-050 222 PIKE STREET SOUTH PADRE ISLAND, TX 78597 UTILITY POLE

PLUMBING DIAGRAM


SHEET NUMBER

PL-1



PLAN_NOTES:

- PLANS DEPICTED ARE GENERAL GUIDELINES FOR TEMPORARY VEHICULAR TRAFFIC CONTROL PLANS (TCP) TO INCLUDE PEDESTRIAN AND WORKER SAFETY, CONTRACTOR IS REQUIRED TO HAVE PREPARED A SITE—SPECIFIC TCP FOR REVIEW AND APPROVAL BY THE HIGHWAY AUTHORITY HAVING JURISDICTION. IF REQUIRED, THE FIRM PREPARING THE TCP SHALL BE AUTHORIZED OR CERTIFIED BY THE AUTHORITY HAVING JURISDICTION.
- 2. EXTEND CHANNELIZATION DEVICES INTO SHOULDER WHERE APPLICABLE.
- 3. DISTANCES AS INDICATED IN TABLE 1 SHOULD BE INCREASED FOR CONDITIONS THAT WOULD AFFECT STOPPING, DISTANCE SUCH AS DOWNGRADES OR LIMITED SIGHT DISTANCES. DISTANCES CAN BE DECREASED FOR LOW-SPEED (RESIDENTIAL) AREAS WITH APPROVAL BY THE AUTHORITY HAVING JURISDICTION, NIGHT-TIME WORK IS PROHIBITED UNLESS IT IS REQUIRED AS A CONDITION OF APPROVAL BY THE HIGHWAY AND LOCAL AUTHORITY HAVING JURISDICTION.
- 4. SHOULDER TAPERS SHOULD BE 1/3 OF THE ON-STREET TAPER LENGTH.
- 5. MAINTAIN A MINIMUM LANE WIDTH OF 10'.
- 6. THIS LAYOUT APPLIES TO SPEEDS 30 MPH OR LESS.
- 7. THIS LAYOUT DOES NOT APPLY TO ANY STREET WITH A DOUBLE YELLOW OR WHITE CENTERLINE, OR LIMITED SITE DISTANCES

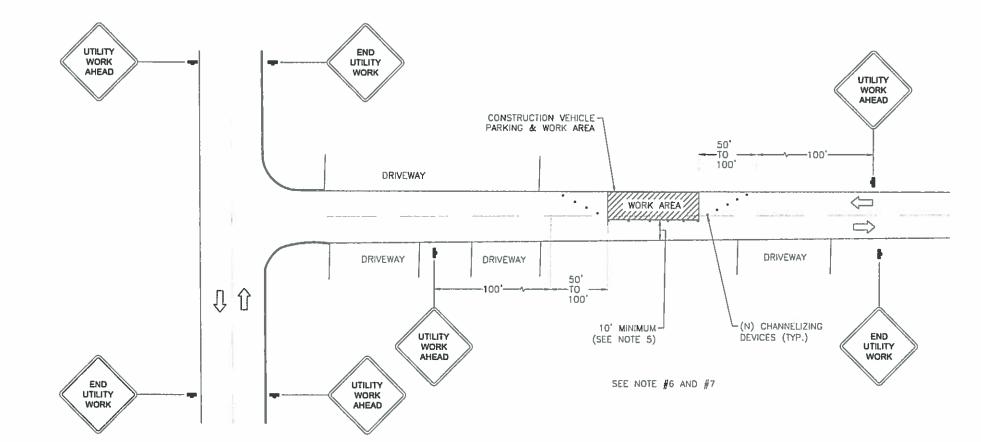

CONSTRUCTIO	IN AC	TIVIT	SCI	HEDL	ILE					
ACTIVITY DESCRIPTION	0	APPI		ATE 3				ON (I 7	DAYS) 8	9
MOBILIZATION, INSTALLATION OF EROSION, SEDIMENTATION CONTROL MEASURES		9)							Yer	
TOWER FOUNDATION EXCAVATION, CONSTRUCTION & CURING									ı	
TOWER ERECTION, INSTALLATION & GROUNDING RELATED WORK							П			
MAIN SERVICE UTILITY WORK				•						
EQUIPMENT AND ANTENNA INSTALLATION, UTILITY & GROUNDING CONNECTIONS		i								
FINAL GRADING, AREA RESTORATION & MISCELLANEOUS DETAILS									-	
TEMPORARY EROSION, SEDIMENTATION CONTROL REMOVAL & FINAL CLEANUP									No.	-

- SIGN

VEHICULAR TRAFFIC CONTROL PLAN -	
LOW-SPEED AREA	

SCALE: NOT TO SCALE





JACOBS

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MEGAN L. CROW

107989

JCENSE

FOR REVIEW

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MRSTX049968 18627-050 222 PIKE STREET SOUTH PADRE ISLAND, TX 78597 UTILITY POLE

SHEET TITLE
VEHICULAR TRAFFIC
CONTROL PLAN


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TC-1

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TRAFFIC_CONTROL_GENERAL NOTES

- ALL TEMPORARY TRAFFIC CONTROL SIGNAGE, LAYOUTS
 AND PROCEDURES SHALL COMPLY WITH LOCAL
 JURISDICTIONAL REQUIREMENTS AND MANUAL OF UNIFORM TRAFFIC
 CONTROL DEVICES (MUTCD), LATEST EDITION, WHICHEVER IS MORE STRINGENT.
- 2. PRIOR TO ANY ROAD CONSTRUCTION, TRAFFIC CONTROL SIGNS AND DEVICES SHALL BE IN PLACE.
- TRAFFIC CONTROL DEVICES FOR LANE CLOSURES INCLUDING SIGNS, CONES, BARRICADES, ETC. SHALL BE PLACED AS SHOWN ON PLANS. SIGNS SHALL NOT BE PLACED WITHOUT ACTUAL LANE CLOSURES AND SHALL BE IMMEDIATELY REMOVED UPON REMOVAL OF THE CLOSURES.
- 4. SELECTION, PLACEMENT, MAINTENANCE, AND PROTECTION OF TRAFFIC, PEDESTRIANS, AND WORKERS SHALL BE IN ACCORDANCE WITH THE MANUAL OF UNIFORM TRAFFIC CONTROL DEVICES (MUTCD) PART VI "TEMPORARY TRAFFIC CONTROL", AND LOCAL JURISDICTIONAL REQUIREMENTS UNLESS OTHERWISE NOTED IN THE PLANS AND SPECIFICATIONS, AND SHALL BE APPROVED BY THE APPROPRIATE HIGHWAY AUTHORITY HAVING JURISDICTION.
- ADVANCE WARNING SIGNS, DISTANCES, AND TAPER LENGTHS MAY BE EXTENDED TO ADJUST FOR REDUCED VISIBILITY DUE TO HORIZONTAL AND VERTICAL CURVATURE OF THE ROADWAY AND FOR ACTUAL TRAFFIC SPEEDS IF IN EXCESS OF POSTED SPEED LIMITS.
- 6. TAPERS SHALL BE LOCATED TO MAXIMIZE THE VISIBILITY OF THEIR TOTAL LENGTH
- CONFLICTING OR NON-OPERATING SIGNAL INDICATIONS ON THE (E) TRAFFIC SIGNAL SYSTEMS SHALL BE BAGGED OR COVERED.
- B. ALL (E) ROAD SIGNS, PAVEMENT MARKINGS AND/OR PLOWABLE PAVEMENT REFLECTORS WHICH CONFLICT WITH THE (N) TRAFFIC CONTROL PLAN SHALL BE COVERED, REMOVED, OR RELOCATED. ALL TRAFFIC CONTROL DEVICES SHALL BE RESTORED TO MATCH PRE—CONSTRUCTION CONDITION AFTER COMPLETION OF WORK.
- CONTRACTOR SHALL CONTACT LOCAL AUTHORITY HAVING HIGHWAY JURISDICTION AND PROVIDE ADDITIONAL "FLAGMEN" OR POLICE SUPERVISION, IF REQUIRED.
- 10. ALL EXCAVATED AREAS WITHIN OR ADJACENT TO THE ROADWAY SHALL BE BACKFILLED AND PLACED ON A MINIMUM 6H: 1V SLOPE PRIOR TO END OF EACH WORK DAY. OTHER EXCAVATED AREAS WITHIN THE CLEAR ZONE ARE TO BE EITHER BACKFILLED OR PRECAST CONCRETE CURB BARRIER CONSTRUCTION BARRIER SET TEMPORARILY IN PLACE TO SHIELD VEHICULAR AND PEDESTRIAN TRAFFIC.
- 11. WHERE DICTATED BY LOCAL CONDITIONS, THE CONTRACTOR SHALL MAKE PROVISIONS FOR MAINTAINING PEDESTRIAN AND WORKER CROSSING LOCATIONS IN ACCORDANCE WITH ALL APPLICABLE CODES AND OSHA REQUIREMENTS.
- 12. CONSTRUCTION ZONE SPEED LIMIT IF REDUCED FROM POSTED LIMITS SHALL BE IN ACCORDANCE WITH MUTCH AND WILL BE DETERMINED BY THE AUTHORITY HAVING JURISDICTION.
- THERE SHALL BE NO WORKERS, EQUIPMENT, OR OTHER VEHICLES IN THE BUFFER SPACE OR THE ROLL AHEAD SPACE.
- 14. DRIVEWAYS AND/OR SIDE STREETS ENTERING THE ROADWAY AFTER THE FIRST ADVANCE WARNING SIGN SHALL BE PROVIDED WITH AT LEAST ONE W20-1 SIGN (ROAD WORK AHEAD) AS A MINIMUM.
- CONES MAY BE SUBSTITUTED FOR DRUMS AND INSTALLED UPON THE APPROVAL OF THE AUTHORITY HAVING JURISDICTION PROVIDED THEY COMPLY WITH MUTCD.
- 16. THE SPACING BETWEEN CONES, TUBULAR MARKERS, VERTICAL PANELS, DRUMS, AND BARRICADES SHOULD NOT EXCEED A DISTANCE IN FEET EQUAL. TO 1.0 TIMES THE SPEED LIMIT IN MPH WHEN USED FOR TAPER CHANNELIZATION, AND A DISTANCE IN FEET EQUAL TO 2.0 TIMES THE SPEED LIMIT IN MPH WHEN USED FOR TANGENT CHANNELIZATION.
- 17. WHEN CHANNELIZATION DEVICES HAVE THE POTENTIAL OF LEADING VEHICULAR TRAFFIC OUT OF THE INTENDED VEHICULAR TRAFFIC SPACE, THE CHANNELIZATION DEVICES SHOULD BE EXTENDED A DISTANCE IN FEET OF 2.0 TIMES THE SPEED LIMIT IN MPH BEYOND THE DOWNSTREAM END OF THE TRANSITION AREA.
- 18. TAPER LENGTHS ARE CALCULATED AS FOLLOWS: L= WS²/60 (40 MPH AND HIGHER) OR L2= WS (OVER 40 MPH), WHERE W= OFFSET WIDTH (FT), S= TRAFFIC SPEED (MPH).



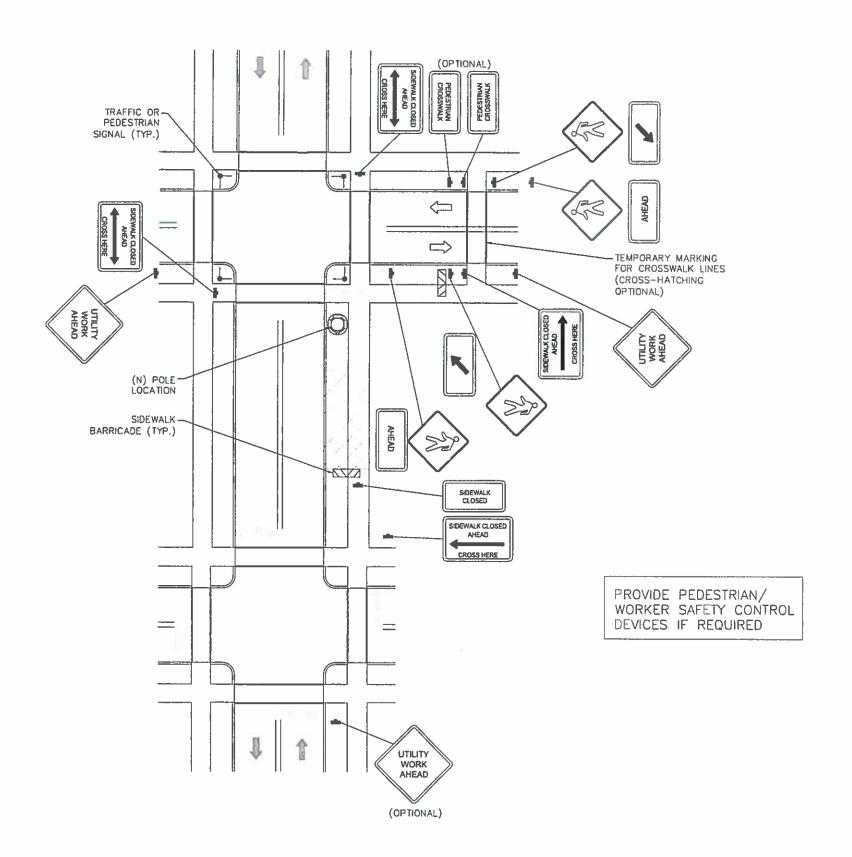

JACOBS

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MRSTX049968 18627-050 222 PIKE STREET SOUTH PADRE ISLAND, TX 78597 UTILITY POLE

SHEET TITLE

PEDESTRIAN SAFETY PLAN

SHEET NUMBER

TC-2

TYPICAL PEDESTRIAN / WORKER SAFETY PLAN

GENERAL CONSTRUCTION NOTES:

- ALL WORK SHALL CONFORM TO THE REQUIREMENTS OF THE LOCAL BUILDING CODE, THE LATEST ADOPTED EDITION AND ALL OTHER APPLICABLE CODES AND ORDINANCES.
- CONTRACTOR SHALL CONSTRUCT SITE IN ACCORDANCE WITH THESE DRAWINGS AND LATEST JACOBS CONSTRUCTION STANDARDS. THE SPECIFICATION IS THE RULING DOCUMENT AND ANY DISCREPANCIES BETWEEN THE SPECIFICATION AND THE CONSTRUCTION DRAWINGS SHALL BE BROUGHT TO THE ATTENTION OF THE ARCHITECT/ENGINEER OR JACOBS CM PRIOR TO THE COMMENCEMENT OF WORK.
- 3. CONTRACTOR SHALL VISIT THE JOB SITE AND SHALL FAMILIARIZE THEMSELVES WITH ALL CONDITIONS AFFECTING THE (N) WORK AND SHALL MAKE PROVISIONS AS TO THE COST THEREOF. CONTRACTOR SHALL BE RESPONSIBLE FOR FAMILIARIZING THEMSELVES WITH ALL CONTRACT DOCUMENTS, FIELD CONDITIONS AND DIMENSIONS AND CONFIRMING THAT THE WORK MAY BE ACCOMPLISHED, AS SHOWN, PRIOR TO PROCEEDING WITH CONSTRUCTION. ANY DISCREPANCIES SHALL BE BROUGHT TO THE ATTENTION OF THE ARCHITECT/ENGINEER OR JACOBS CM PRIOR TO THE COMMENCEMENT OF WORK. NO COMPENSATION WILL BE AWARDED BASED ON CLAIM OF LACK OF KNOWLEDGE OF FIELD CONDITIONS.
- 4. IT IS NOT THE INTENT OF THESE PLANS TO SHOW EVERY MINOR DETAIL OF CONSTRUCTION. CONTRACTOR IS REQUIRED TO FURNISH AND INSTALL ANY/ALL ITEMS FOR A COMPLETE AND FULLY FUNCTIONAL SYSTEM SUBJECT ONLY TO OWNER-SUPPLIED ITEMS. CONTRACTOR SHALL PROVIDE ANY/ALL REQUIREMENTS FOR THE EQUIPMENT TO BE PLACED IN PROPER WORKING ORDER.
- 5. PLANS ARE NOT TO BE SCALED. THESE PLANS ARE INTENDED TO BE A DIAGRAMMATIC OUTLINE ONLY UNLESS OTHERWISE NOTED. THE WORK SHALL INCLUDE FURNISHING MATERIALS, EQUIPMENT AND APPURIENANCES, AND LABOR NECESSARY TO EFFECT ALL INSTALLATIONS AS INDICATED ON THE DRAWINGS.
- 6. DIMENSIONS SHOWN ARE TO FINISH SURFACES UNLESS OTHERWISE NOTED. SPACING BETWEEN EQUIPMENT IS REQUIRED CLEARANCE. THEREFORE, IT IS CRITICAL TO FIELD VERIFY DIMENSIONS. SHOULD THERE BE ANY QUESTIONS RECARDING THE CONTRACT DOCUMENTS, (E) CONDITIONS AND/OR DESIGN INTENT, THE CONTRACTOR SHALL BE RESPONSIBLE FOR REPORTING ANY DISCREPANCIES TO THE ATTENTION OF THE JACOBS CM, IN WRITING, PRIOR TO THE COMMENCEMENT OF WORK.
- DETAILS PROVIDED ARE FOR THE PURPOSE OF SHOWING DESIGN INTENT.
 MODIFICATIONS MAY BE REQUIRED TO SUIT JOB DIMENSIONS OR SITE CONDITIONS,
 AND SUCH MODIFICATIONS SHALL BE INCLUDED AS PART OF THE WORK.
- 8. CONTRACTOR SHALL PAY FOR APPLICABLE PERMITS, FEES, INSPECTIONS AND TESTING. CONTRACTOR IS TO OBTAIN PERMITS AND APPROVED SUBMITTALS PRIOR TO ORDERING MATERIALS AND THE COMMENCEMENT OF WORK.
- 9. THE TERM "PROVIDE" USED IN CONSTRUCTION DOCUMENTS AND SPECIFICATIONS, INDICATES THAT THE CONTRACTOR SHALL FURNISH AND INSTALL.
- 10. CONTRACTOR SHALL RECEIVE CLARIFICATION IN WRITING, AND SHALL RECEIVE IN WRITING AUTHORIZATION TO PROCEED BEFORE STARTING WORK ON ANY ITEMS NOT CLEARLY DEFINED OR IDENTIFIED BY THE CONTRACT DOCUMENTS.
- 11. CONTRACTOR SHALL SUPERVISE AND DIRECT THE WORK USING ACCEPTED INDUSTRY-STANDARD SKILLS AND ATTENTION. CONTRACTOR SHALL BE SOLELY RESPONSIBLE FOR CONSTRUCTION MEANS, METHODS, TECHNIQUES, SEQUENCES AND PROCEDURES AND FOR COORDINATING ALL PORTIONS OF THE WORK UNDER CONTRACT, UNLESS OTHERWISE NOTED.
- 12. CONTRACTOR SHALL BE RESPONSIBLE FOR THE SAFETY OF THE WORK AREA, ADJACENT AREAS AND BUILDING OCCUPANTS THAT ARE LIKELY TO BE AFFECTED BY THE WORK UNDER THIS CONTRACT. WORK SHALL CONFORM TO ALL OSHA REQUIREMENTS.
- CONTRACTOR SHALL COORDINATE THEIR WORK WITH JACOBS CM AND SCHEDULE THEIR ACTIVITIES AND WORKING HOURS IN ACCORDANCE WITH THE REQUIREMENTS.
- 14. CONTRACTOR SHALL BE RESPONSIBLE FOR COORDINATING THEIR WORK WITH THE WORK OF OTHERS AS IT MAY RELATE TO RADIO EQUIPMENT, ANTENNAS AND ANY OTHER PORTIONS OF THE WORK.
- 15. CONTRACTOR SHALL INSTALL ALL EQUIPMENT AND MATERIALS IN ACCORDANCE WITH MANUFACTURERS RECOMMENDATIONS UNLESS SPECIFICALLY OTHERWISE INDICATED OR WHERE LOCAL CODES OR REGULATIONS TAKE PRECEDENCE.
- 16. CONTRACTOR SHALL MAKE NECESSARY PROVISIONS TO PROTECT (E) SURFACES,

- EQUIPMENT, IMPROVEMENTS, PIPING ETC. AND IMMEDIATE REPAIR, TO NEW CONDITION, ANY DAMAGE THAT OCCURS DURING CONSTRUCTION AT THE SOLE COST OF THE CONTRACTOR.
- 17. IN DRILLING HOLES, OR CORING, INTO CONCRETE WHETHER FOR FASTENING OR ANCHORING PURPOSES, OR PENETRATIONS THROUGH THE FLOOR FOR CONDUIT RUNS, PIPE RUNS, ETC., MUST BE CLEARLY UNDERSTOOD THAT REINFORCING STEEL SHALL NOT BE DRILLED INTO, CUT OR DAMAGED UNDER ANY CIRCUMSTANCES (UNLESS NOTED OTHERWISE). LOCATIONS OF REINFORCING STEEL ARE NOT DEFINITELY KNOWN AND THEREFORE MUST BE LOCATED BY THE CONTRACTOR USING APPROPRIATE METHODS AND EQUIPMENT PRIOR TO ANY DRILLING OR CORING OPERATIONS IN (E) CONCRETE.
- 18. CONTRACTOR SHALL REPAIR, TO NEW CONDITION, ALL (E) WALL SURFACES DAMAGED DURING CONSTRUCTION SUCH THAT THEY MATCH AND BLEND IN WITH ADJACENT SURFACES.
- 19. CONTRACTOR SHALL SEAL PENETRATIONS THROUGH FIRE RATED ASSEMBLIES OR MATERIALS WITH U.L. LISTED AND FIRE CODE APPROVED MATERIALS AND SYSTEMS THAT MEET OR EXCEED THE RATING OF THE ASSEMBLY IN WHICH THE NEW PENETRATION IS PLACED.
- 20. CONTRACTOR SHALL KEEP CONTRACT AREA CLEAN, HAZARD FREE, AND DISPOSE OF ALL DIRT, DEBRIS, AND RUBBISH. EQUIPMENT NOT SPECIFIED AS REMAINING ON THE PROPERTY OF THE OWNER SHALL BE REMOVED. LEAVE PREMISES IN CLEAN CONDITION AND FREE FROM PAINT SPOTS, DUST, OR SMUDGES OF ANY NATURE. CONTRACTOR SHALL BE RESPONSIBLE FOR MAINTAINING ALL ITEMS UNTIL COMPLETION OF CONSTRUCTION.
- 21. MINIMUM BEND RADIUS OF ANTENNA CABLES SHALL BE IN ACCORDANCE WITH CABLE MANUFACTURERS RECOMMENDATIONS.
- 22. CONTRACTOR SHALL MINIMIZE DISTURBANCE TO (E) SITE DURING CONSTRUCTION. EROSION CONTROL MEASURES, IF REQUIRED DURING CONSTRUCTION SHALL BE IN CONFORMANCE WITH JURISDICTIONAL OR STATE AND LOCAL GUIDELINES FOR EROSION AND SEDIMENT CONTROL AND COORDINATED WITH LOCAL REGULATORY AUTHORITIES. CONTRACTOR SHALL BE RESPONSIBLE FOR MAINTENANCE OF ANY EROSION CONTROL MEASURES, RECORD—KEEPING, MONITORING, AND REPORTING TO THE OWNER AND REGULATORY AUTHORITIES.
- ALL CONSTRUCTION WORK IS TO ADHERE TO APPLICANT'S INTEGRATED CONSTRUCTION STANDARDS UNLESS STATE OR LOCAL CODE IS MORE STRINGENT.
- 24. THE INTENT OF THE PLANS AND SPECIFICATIONS IS TO PERFORM THE CONSTRUCTION IN ACCORDANCE PER STATE BUILDING STANDARDS CODE AND STATE CODE OF REGULATIONS. SHOULD ANY CONDITIONS DEVELOP NOT COVERED BY THE APPROVED PLANS AND SPECIFICATIONS WHEREIN THE FINISHED WORK WILL NOT COMPLY PER STATE CODE OF REGULATIONS, A SCOPE OF WORK DETAILING AND SPECIFYING THE REQUIRED WORK SHALL BE SUBMITTED TO AND APPROVED BY THE JURISDICTION BEFORE PROCEEDING WITH THE WORK. A CHANGE ORDER FOR THAT SCOPE SHALL BE SUBMITTED TO JACOBS CM PRIOR TO PROCEEDING WITH THE WORK.
- 25. ADEQUATE AND REQUIRED LIABILITY INSURANCE SHALL BE PROVIDED BY THE CONTRACTOR FOR PROTECTION AGAINST PUBLIC LOSS AND ANY/ALL PROPERTY DAMAGE FOR THE DURATION OF WORK.
- 26. CONTRACTOR SHALL GUARANTEE ANY/ALL MATERIALS AND WORK FREE FROM DEFECTS FOR A PERIOD OF NOT LESS THAN ONE YEAR FROM DATE OF ACCEPTANCE. ANY CORRECTIVE WORK SHALL BE COMPLETED AT THE SOLE COST OF THE CONTRACTOR.

ELECTRICAL NOTES:

- 1. ELECTRICAL CONTRACTOR SHALL SUPPLY AND INSTALL ANY/ALL ELECTRICAL WORK INDICATED. ANY/ALL CONSTRUCTION SHALL BE IN ACCORDANCE W/DRAWINGS AND ANY/ALL APPLICABLE SPECIFICATIONS. IF ANY PROBLEMS ARE ENCOUNTERED BY COMPLYING WITH THESE REQUIREMENTS, CONTRACTOR SHALL NOTIFY JACOBS CM AS SOON AS POSSIBLE, AFTER THE DISCOVERY OF THE PROBLEMS, AND SHALL NOT PROCEED WITH THAT PORTION OF WORK, UNTIL THE JACOBS CM HAS DIRECTED THE CORRECTIVE ACTIONS TO BE TAKEN.
- 2. ELECTRICAL CONTRACTOR SHALL VISIT THE JOB SITE AND FAMILIARIZE THEMSELVES WITH ANY/ALL CONDITIONS AFFECTING ELECTRICAL AND COMMUNICATION INSTALLATION AND MAKE PROVISIONS AS TO THE COST THEREOF. ALL (E) CONDITIONS OF ELECTRICAL EQUIP, ETC., THAT ARE PART OF THE FINAL SYSTEM, SHALL BE VERIFIED BY THE CONTRACTOR, PRIOR TO THE SUBMITTING OF THEIR BID. FAILURE TO COMPLY WITH THIS PARAGRAPH WILL IN NO WAY RELIEVE CONTRACTOR OF PERFORMING ALL WORK NECESSARY FOR A COMPLETE AND WORKING SYSTEM

- 3. ALL WORK SHALL BE PERFORMED IN ACCORDANCE WITH THE LATEST EDITION OF THE NEC, ALL CODES AND ORDINANCES OF THE LOCAL JURISDICTION, AND POWER & TELEPHONE COMPANIES HAVING JURISDICTION AND SHALL INCLUDE BUT ARE NOT BE LIMITED TO:
 - A) UL UNDERWRITERS LABORATORIES
 - B) NEC = NATIONAL ELECTRICAL CODE
 - C) NEMA NATIONAL ELECTRICAL MANUFACTURERS ASSOC.
 - D) OSHA OCCUPATIONAL SAFETY AND HEALTH ACT
 - E) SBC STANDARD BUILDING CODE
 - F) NFPA NATIONAL FIRE PROTECTION AGENCY
 - G) ANSI AMERICAN NATIONAL STANDARDS INSTITUTE
 - H) IEEE INSTITUTE OF ELECTRICAL AND ELECTRONICS ENGINEERS
 - 1) ASTM AMERICAN SOCIETY FOR TESTING MATERIALS
- REFER TO SITE PLANS AND ELEVATIONS FOR EXACT LOCATIONS OF ALL EQUIPMENT, AND CONFIRM WITH JACOBS CM ANY SIZES AND LOCATIONS WHEN NEEDED.
- (E) SERVICES: CONTRACTOR SHALL NOT INTERRUPT (E) SERVICES WITHOUT WRITTEN PERMISSION OF THE OWNER.
- 6. CONTRACTOR SHALL CONFIRM WITH LOCAL UTILITY COMPANY ANY/ALL REQUIREMENTS SUCH AS THE: LUG SIZE RESTRICTIONS, CONDUIT ENTRY, SIZE OF TRANSFORMERS, SCHEDULED DOWNTIME FOR THE OWNERS' CONFIRMATION, ETC... ANY/ALL CONFLICTS SHALL BE BROUGHT TO THE ATTENTION OF JACOBS CM, PRIOR TO BEGINNING ANY WORK.
- MINIMUM WIRE SIZE SHALL BE #12 AWG, NOT INCLUDING CONTROL WIRING, UNLESS NOTED OTHERWISE. ALL CONDUCTORS SHALL BE COPPER WITH THWN INSULATION, UNLESS OTHERWISE NOTED.
- 8. OUTLET BOXES SHALL BE PRESSED STEEL IN DRY LOCATIONS, CAST ALLOY WITH THREADED HUBS IN WET/DAMP LOCATIONS AND SPECIAL ENCLOSURES FOR OTHER CLASSIFIED AREAS.
- 9. IT IS NOT THE INTENT OF THESE PLANS TO SHOW EVERY MINOR DETAIL OF THE CONSTRUCTION. CONTRACTOR IS EXPECTED TO FURNISH AND INSTALL ALL ITEMS FOR A COMPLETE ELECTRICAL SYSTEM AND PROVIDE ALL REQUIREMENTS FOR THE EQUIPMENT TO BE PLACED IN PROPER WORKING ORDER.
- 10. ELECTRICAL SYSTEM SHALL BE AS COMPLETELY AND EFFECTIVELY GROUNDED, AS REQUIRED BY SPECIFICATIONS, SET FORTH BY APPLICANT.
- 11. ALL WORK SHALL BE PERFORMED BY A LICENSED ELECTRICAL CONTRACTOR IN A FIRST CLASS, WORKMANLIKE MANNER. THE COMPLETED SYSTEM SHALL BE FULLY FUNCTIONAL AND SHALL BE APPROVED BY JACOBS CM AND LOCAL JURISDICTION. ANY DEFICIENCIES SHALL BE CORRECTED BY AN ELECTRICAL CONTRACTOR AT THE SOLE COST OF THE CONTRACTOR.
- 12. ALL WORK SHALL BE COORDINATED WITH OTHER TRADES TO AVOID INTERFERENCE WITH THE PROGRESS OF CONSTRUCTION.



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ELECTRICAL NOTES CONT'D

- 13. THE CORRECTION OF ANY DEFECTS SHALL BE COMPLETED BY THE CONTRACTOR WITHOUT ANY ADDITIONAL CHARGE AND SHALL INCLUDE THE REPLACEMENT OR THE REPAIR OF ANY OTHER PHASE OF THE INSTALLATION, WHICH MAY HAVE BEEN DAMAGED THEREIN.
- 14 CONTRACTOR SHALL PROVIDE AND INSTALL CONDUIT, CONDUCTORS, PULL WIRES, BOXES, COVER PLATES AND DEVICES FOR ALL OUTLETS AS INDICATED.
- 15. DITCHING AND BACK FILL: CONTRACTOR SHALL PROVIDE FOR ALL UNDERGROUND INSTALLED CONDUIT AND/OR CABLES INCLUDING EXCAVATION AND BACKFILLING AND COMPACTION, REFER TO NOTES AND REQUIREMENTS 'EXCAVATION, AND BACKFILLING.
- 16. MATERIALS, PRODUCTS AND EQUIPMENT, INCLUDING ALL COMPONENTS THEREOF, SHALL BE NEW AND SHALL APPEAR ON THE LIST OF U.L. APPROVED ITEMS AND SHALL MEET OR EXCEED THE REQUIREMENTS OF THE NEC, NEMA AND IECE.
- CONTRACTOR SHALL SUBMIT SHOP DRAWINGS OR MANUFACTURER'S CATALOG INFORMATION OF ANY/ALL EQUIPMENT AND ALL OTHER ELECTRICAL ITEMS FOR APPROVAL BY JACOBS CM PRIOR TO INSTALLATION.
- 18. ANY CUTTING OR PATCHING DEEMED NECESSARY FOR ELECTRICAL WORK IS THE ELECTRICAL CONTRACTORS RESPONSIBILITY AND SHALL BE INCLUDED IN THE COST FOR WORK AND PERFORMED TO THE SATISFACTION OF JACOBS CM UPON FINAL ACCEPTANCE.
- 19. THE ELECTRICAL CONTRACTOR SHALL LABEL ALL PANELS WITH ONLY TYPEWRITTEN DIRECTORIES. ALL ELECTRICAL WRING SHALL BE THE RESPONSIBILITY OF THE ELECTRICAL CONTRACTOR.
- DISCONNECT SWITCHES SHALL BE UL-RATED, H.P. RATED HEAVY-DUTY, QUICK-MAKE AND QUICK-BREAK ENCLOSURES, AS REQUIRED BY EXPOSURE TYPE.
- 21. ALL CONNECTIONS SHALL BE MADE WITH A PROTECTIVE COATING OF AN ANTI-DXIDE COMPOUND KNOWN AS "NO-DXIDE A" BY DEARBORNE CHEMICAL CO. COAT ALL WIRE SURFACES BEFORE CONNECTING. EXPOSED COPPER SURFACES, INCLUDING GROUND BARS, SHALL BE TREATED NO SUBSTITUTIONS.
- 22. RACEWAYS: CONDUIT SHALL BE SCHEDULE 80 PVC MEETING OR EXCEEDING NEMA TC2 + 1990. CONTRACTOR SHALL PLUG AND CAP EACH END OF SPARE AND EMPTY CONDUITS AND PROVIDE TWO SEPARATE PULL STRINGS 200 LBS TEST POLYETHYLENE CORD. ALL CONDUIT BENDS SHALL BE A MINIMUM OF 2 FT. RADIUS. RGS CONDUITS WHEN SPECIFIED, SHALL MEET UL-6 FOR GALVANIZED STEEL. ALL FITTINGS SHALL BE SUITABLE FOR USE WITH THREADED RIGID CONDUIT. COAT ALL THREADS WITH 'BRITE ZINC' OR 'COLD GALV'.
- 23. SUPPORT OF ALL ELECTRICAL WORK SHALL BE AS REQUIRED BY NEC.
- 24. CONDUCTORS: CONTRACTOR SHALL USE 98% CONDUCTIVITY COPPER WITH TYPE THWN INSULATION, UNLESS OTHERWISE NOTED, 500 VOLT, COLOR CODED. USE SOLID CONDUCTORS FOR WRE UP TO AND INCLUDING NO. 8 AWG. USE STRANDED CONDUCTORS FOR WRE ABOVE NO. 8 AWG.
- 25. CONNECTORS FOR POWER CONDUCTORS: CONTRACTOR SHALL USE PRESSURE TYPE INSULATED TWIST—ON CONNECTORS FOR NO. 10 AWG AND SMALLER. USE SOLDERLESS MECHANICAL TERMINAL LUGS FOR NO. 8 AWG AND LARGER.
- 26. SERVICE: AS SPECIFIED ON THE DRAWINGS, OWNER OR OWNER'S AGENT WILL APPLY FOR POWER, ALL PROVISIONS FOR TEMPORARY POWER WILL BE OBTAINED BY THE CONTRACTOR.
- 27. TELEPHONE OR FIBER SERVICE: CONTRACTOR SHALL PROVIDE EMPTY CONDUITS WITH PULL STRINGS AS INDICATED ON DRAWINGS.
- 28. ELECTRICAL AND TELCO/FIBER RACEWAYS TO BE BURIED A MINIMUM DEPTH OF 30", UNLESS OTHERWISE NOTED."
- 29. CONTRACTOR SHALL PLACE 6" WIDE DETECTABLE WARNING TAPE AT A DEPTH OF 6" BELOW GROUND AND DIRECTLY ABOVE ELECTRICAL AND TELCO SERVICE CONDUITS. CAUTIONS TAPE TO READ "CAUTION BURIED ELECTRIC" OR "BURIED TELECOM"
- 30 ALL BOLTS SHALL BE 3-16 STAINLESS STEEL

GROUNDING NOTES:

- ALL HARDWARE SHALL BE 3-16 STAINLESS STEEL, INCLUDING LOCK WASHERS. COAT ALL SURFACES WITH AN ANTI-OXIDANT COMPOUND, AS SPECIFIED, BEFORE MATING. ALL HARDWARE SHALL BE STAINLESS STEEL 3/B INCH DIAMETER OR SIZED TO MATCH COMPONENTS OR LOG SIZE.
- FOR GROUND BOND TO STEEL ONLY: INSERT A CADMIUM FLAT WASHER BETWEEN LUG AND STEEL, COAT ALL SURFACES WITH AN ANTI-OXIDANT COMPOUND BEFORE MATING.
- ALL STEEL CONDUIT SHALL BE BONDED AT BOTH ENDS WITH GROUNDING BUSHING.
- ALL ELECTRICAL AND GROUNDING AT THE POLE SITE SHALL COMPLY WITH THE NATIONAL ELECTRICAL CODE (NEC), NATIONAL FIRE PROTECTION ASSOCIATION (NFPA) 780 (LATEST EDITION), AND MANUFACTURER.
- ALL DETAILS ARE SHOWN IN GENERAL TERMS. ACTUAL GROUNDING INSTALLATION AND CONSTRUCTION MAY VARY DUE TO SITE SPECIFIC CONDITIONS.
- 6. GROUND ALL ANTENNA BASES, FRAMES, CABLE RUNS, AND OTHER METALLIC COMPONENTS USING #6 GROUND WIRES. FOLLOW ANTENNA AND BTS MANUFACTURER'S PRACTICES FOR GROUNDING REQUIREMENTS.
- 7. ALL GROUND CONNECTIONS SHALL BE #6 AWG, UNLESS OTHERWISE NOTED. USE SOLID COPPER, BLACK JACKETED WRE ON NON WOOD POLES AND SOLID TINNED COPPER, BARE (NO JACKET) WRES ON WOOD POLES. BLACK WRES WILL USE A SINGLE STRIPE OF GREEN ELECTRICAL TAPE WITHIN 12" OF THE CONNECTION POINTS TO IDENTIFY AS GROUNDING WRE.
- 8 NOTIFY ARCHITECT/ENGINEER IF THERE ARE ANY DIFFICULTIES INSTALLING GROUNDING SYSTEM DUE TO SITE SOIL CONDITIONS,
- 9. ALL HORIZONTALLY RUN GROUNDING CONDUCTORS SHALL BE INSTALLED A MINIMUM OF 30" BELOW GRADE/ 6" BELOW FROST—LINE IN TRENCH, UNLESS OTHERWISE NOTED. BACK FILL SHALL BE COMPACTED AS REQUIRED BY ARCHITECT/ENGINEER.
- ALL GROUND CONDUCTORS SHALL BE RUN AS STRAIGHT AND SHORT AS POSSIBLE, WITH A MINIMUM 12" BENDING RADIUS NOT LESS THAN 90 DEGREES.
- 11. ACCEPTABLE CONNECTIONS FOR GROUNDING SYSTEM SHALL BE:
 - BURNDY, HY-GRADE U.L. LISTED CONNECTORS FOR OUTDOOR USE OR AS APPROVED BY APPLICANT PROJECT MANAGER.
 - B. CADWELD, EXOTHERMIC WELDS (WELDED CONNECTIONS).
 - ONE (1) OR (2) HOLES TINNED COPPER COMPRESSION (LONG BARREL) FITTINGS.
- ALL CRIMPED CONNECTIONS SHALL HAVE EMBOSSED MANUFACTURER'S DIEMARK VISIBLE AT THE CRIMP (RESULTING FROM USE OF PROPER CRIMPING DEVICES) AND WEATHER—PROOFED WITH HEAT SHRINK.
- ALL CONNECTION HARDWARE SHALL BE TYPE 3-16 STAINLESS STEEL (NOT ATTRACTED TO MAGNETS).
- 14. ELECTRICAL SERVICE EQUIPMENT GROUNDING SHALL COMPLY WITH NEC, ARTICLE 250-82 AND SHALL BOND ALL (E) AND NEW GROUNDING ELECTRODES. NEW GROUNDING ELECTRODE SHALL INCLUDE BUT NOT LIMITED TO GROUND RODS.

TESTING AND EQUIPMENT TURN UP REQUIREMENTS:

- RF CABLE, DATA CABLE, RADIO EQUIPMENT AND BACK HAUL EQUIPMENT TESTING WILL COMPLY WITH CURRENT INDUSTRY STANDARDS AND OR THOSE STANDARDS OF THE EQUIPMENT MANUFACTURER OR PROVIDED TO THE CONTRACTOR PRIOR TO TESTING.
- 2. CONTRACTOR WILL USE THE APPROPRIATE CALIBRATED TESTING EQUIPMENT IN THE TESTING OF RF CABLE, DATA CABLE, RADIO EQUIPMENT AND BACK HAUL. EQUIPMENT THAT MEET INDUSTRY STANDARDS OF THE MANUFACTURER OR THOSE STANDARDS PROWDED TO THE CONTRACTOR PRIOR TO TESTING.

- CONTRACTOR TO VERIFY AND RECORD ALL TEST RESULTS AND PROVIDE THESE RESULTS WITHIN THE FINAL CLOSE OUT PACKAGE.
- 4. ALL PERSONNEL INVOLVED IN THE TESTING OF RF CABLE, DATA CABLE, RADIO EQUIPMENT AND BACK HAUL EQUIPMENT WILL BE REQUIRED TO HAVE BEEN TRAINED AND OR CERTIFIED IN THE PROPER TESTING OF RF CABLE, DATA CABLE, RADIO EQUIPMENT AND BACK HAUL EQUIPMENT.
- ALL TEST RESULTS SHALL BE TIME STAMPED, RECORDED AND PRESENTED PRIOR TO ENERGIZING AND TURN UP OF ANY EQUIPMENT.
- GPS EQUIPMENT (WHEN REQUIRED) IS NOT TO BE TESTED OR ATTACHED TO ANY CABLING DURING TESTING, DOING SO WILL DAMAGE THE CPS UNIT.
- PRIOR TO TESTING IF THE CONTRACTOR HAS ANY QUESTIONS ABOUT THE TESTING PROCEDURES THEY ARE TO CALL AND OBTAIN ASSISTANCE FROM A QUALIFIED DESIGNATED TESTING REPRESENTATIVE.
- B. EQUIPMENT IS NOT TO BE ENERGIZED UNTIL ALL TESTING HAS BEEN COMPLETED, APPROVED AND THE APPROPRIATE AUTHORITY HAS BEEN NOTIFIED AND GIVES APPROVAL TO ENERGIZE THE EQUIPMENT.

SITE WORK NOTES:

- DO NOT EXCAVATE OR DISTURB BEYOND THE PROPERTY LINES OR LEASE LINES, UNLESS OTHERWISE NOTED.
- SIZE, LOCATION AND TYPE OF ANY UNDERGROUND UTILITIES OR IMPROVEMENTS SHALL BE ACCURATELY NOTED AND PLACED ON AS-BUILT DRAWNGS BY GENERAL CONTRACTOR AND ISSUED TO ARCHITECT/ENGINEER AT COMPLETION OF PROJECT.
- 3. ALL (E) UTILITIES, FACILITIES, CONDITIONS AND THEIR DIMENSIONS SHOWN ON PLANS HAVE. BEEN PLOTTED FROM AVAILABLE RECORDS. THE ENGINEER AND OWNER ASSUME NO RESPONSIBILITY WHATSOEVER AS TO THE SUFFICIENCY OR ACCURACY OF THE INFORMATION SHOWN ON THE PLANS OR THE MANNER OF THEIR REMOVAL OR ADJUSTMENT. CONTRACTOR SHALL BE RESPONSIBLE FOR DETERMINING EXACT LOCATION OF ALL (E) UTILITIES AND FACILITIES PRIOR TO START OF CONSTRUCTION. CONTRACTOR SHALL ALSO OBTAIN FROM EACH UTILITY COMPANY DETAILED INFORMATION RELATIVE TO WORKING SCHEDULES AND METHODS OF REMOVING OR ADJUSTING (E) UTILITIES.
- 4. CONTRACTOR SHALL VERIFY ALL (E) UTILITIES BOTH HORIZONTALLY AND VERTICALLY PRIOR TO START OF CONSTRUCTION. ANY DISCREPANCIES OR DOUBTS AS TO THE INTERPRETATION OF PLANS SHALL BE IMMEDIATELY REPORTED TO THE ARCHITECT/ENGINEER OR JACOBS CM FOR RESOLUTION AND INSTRUCTION, AND NO FURTHER WORK SHALL BE PERFORMED UNTIL THE DISCREPANCY IS CHECKED AND CORRECTED BY THE ARCHITECT/ENGINEER. FAILURE TO SECURE SUCH INSTRUCTION MEANS CONTRACTOR WILL HAVE WORKED AT THEIR OWN RISK AND EXPENSE. CONTRACTOR SHALL CALL LOCAL UTILITY LOCATE HOT LINE, SUCH AS 811, FOR UTILITY LOCATIONS A MINIMUM OF 48 HOURS PRIOR TO START OF CONSTRUCTION.
- 5. ALL NEW AND (E) UTILITY STRUCTURES ON SITE AND IN AREAS TO BE DISTURBED BY CONSTRUCTION SHALL BE ADJUSTED TO FINISH ELEVATIONS PRIOR TO FINAL INSPECTION OF WORK, ANY COST RELATED TO ADJUSTING (E) STRUCTURES SHALL BE BORNE SOLELY BY THE CONTRACTOR.
- GRADING OF THE SITE WORK AREA IS TO BE SMOOTH AND CONTINUOUS IN SLOPE AND IS TO FEATHER INTO (E) GRADES AT THE GRADING LIMITS.
- ALL TEMPORARY EXCAVATIONS FOR THE INSTALLATION OF FOUNDATIONS, UTILITIES, ETC., SHALL BE PROPERLY LAID BACK OR BRACED IN ACCORDANCE WITH CORRECT OCCUPATIONAL SAFETY AND HEALTH ADMINISTRATION (OSHA) REQUIREMENTS.



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IT IS A VIOLATION OF THE LAW FOR ANY PERSON, UNLESS THEY ARE ACTING UNDER THE DIRECTION OF A LICENSED PROFESSIONAL ENGINEER, TO ALTER THIS DOCUMENT



MC2 ENGINEERING AND CONSTRUCTION, P.C.
HAS NOT PERFORMED A STRUCTURAL
EVALUATION OR FOUNDATION DESIGN OF THIS
PROJECT.

MRSTX049968 18627-050 222 PIKE STREET SOUTH PADRE ISLAND, TX 78597 UTILITY POLE

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SITE WORK NOTES CONT'D

- STRUCTURAL FILLS SUPPORTING PAVEMENTS SHALL BE COMPACTED TO 95% OF MAXIMUM STANDARD PROCTOR DRY DENSITY, UNLESS OTHERWISE NOTED.
- 9. NEW GRADES NOT IN BUILDING AND DRIVEWAY IMPROVEMENT AREA TO BE ACHIEVED BY FILLING WITH APPROVED CLEAN FILL AND COMPACTED TO 95% OF STANDARD PROCTOR DENSITY.
- 10. ALL FILL SHALL BE PLACED IN UNIFORM LIFTS, THE LIFTS THICKNESS SHOULD NOT EXCEED THAT WHICH CAN BE PROPERLY COMPACTED THROUGHOUT ITS ENTIRE DEPTH WITH THE EQUIPMENT AVAILABLE.
- 11. ANY FILLS PLACED ON (E) SLOPES THAT ARE STEEPER THAN 10 HORIZONTAL TO 1 VERTICAL SHALL BE PROPERLY BENCHED INTO THE (E) SLOPE AS DIRECTED BY A GEOTECHNICAL ENGINEER.
- 12. CONTRACTOR SHALL CLEAN ENTIRE SITE AFTER CONSTRUCTION SUCH THAT NO DEBRIS, PAPER, TRASH, WEEDS, BRUSH, EXCESS FILL, OR ANY OTHER DEPOSITS WILL REMAIN. ALL MATERIALS COLLECTED DURING CLEANING OPERATIONS SHALL BE DISPOSED OF OFF-SITE BY THE GENERAL CONTRACTOR.
- 13. ALL TREES AND SHRUBS WHICH ARE NOT IN DIRECT CONFLICT WITH THE IMPROVEMENTS SHALL BE PROTECTED BY THE GENERAL CONTRACTOR.
- 14. ALL SITE WORK SHALL BE CAREFULLY COORDINATED BY GENERAL CONTRACTOR WITH LOCAL UTILITY COMPANY, TELEPHONE COMPANY, AND ANY OTHER UTILITY COMPANIES HAVING JURISDICTION OVER THIS LOCATION.

ENVIRONMENTAL NOTES:

- ALL WORK PERFORMED SHALL BE DONE IN ACCORDANCE WITH ISSUED PERMITS. THE CONTRACTOR SHALL BE RESPONSIBLE FOR PAYMENT OF FINES AND PROPER CLEAN UP FOR AREAS IN VIOLATION.
- 2. CONTRACTOR SHALL BE RESPONSIBLE FOR CONSTRUCTION AND MAINTENANCE OF EROSION AND SEDIMENTATION CONTROLS DURING CONSTRUCTION FOR PROTECTION OF ADJACENT PROPERTIES, ROADWAYS AND WATERWAYS. ALL EROSION AND SEDIMENTATION CONTROLS SHALL BE MAINTAINED IN PLACE THROUGH FINAL JURISDICTIONAL INSPECTION & RELEASE OF SITE.
- 3. CONTRACTOR SHALL INSTALL/CONSTRUCT ALL NECESSARY SEDIMENT/SILT CONTROL FENCING AND PROTECTIVE MEASURES AS REQUIRED BY THE LOCAL JURISDICTION WITHIN THE LIMITS OF SITE DISTURBANCE PRIOR TO CONSTRUCTION.
- 4. NO SEDIMENT SHALL BE ALLOWED TO EXIT THE PROPERTY. THE CONTRACTOR IS RESPONSIBLE FOR TAKING ADEQUATE MEASURES FOR CONTROLLING EROSION. ADDITIONAL SEDIMENT CONTROL FENCING MAY BE REQUIRED IN ANY AREAS SUBJECT TO FROSION.
- 5. THE CONTRACTOR IS RESPONSIBLE FOR MAINTAINING POSITIVE DRAINAGE ON THE SITE AT ALL TIMES WITH SILT AND EROSION CONTROL MEASURES MAINTAINED ON THE DOWNSTREAM SIDE OF SITE DRAINAGE. ANY DAMAGE TO ADJACENT PROPERTY AS A RESULT OF EROSION WILL BE CORRECTED AT THE CONTRACTORS EXPENSE.
- 5. CONTRACTOR SHALL BE RESPONSIBLE FOR DAILY INSPECTIONS AND ANY REPAIRS OF ALL SEDIMENT CONTROL MEASURES INCLUDING SEDIMENT REMOVAL AS NECESSARY.
- CLEARING OF VEGETATION AND TREE REMOVAL SHALL BE ONLY AS PERMITTED AND BE HELD TO A MINIMUM. ONLY TREES NECESSARY FOR CONSTRUCTION OF THE FACILITIES SHALL BE REMOVED.
- SEEDING AND MULCHING AND/OR SODDING OF THE SITE WILL BE ACCOMPLISHED AS SOON AS POSSIBLE AFTER COMPLETION OF THE PROJECT FACILITIES AFFECTING LAND DISTURBANCE
- 9. CONTRACTOR SHALL PROVIDE ALL EROSION AND SEDIMENTATION CONTROL MEASURES AS REQUIRED BY LOCAL, COUNTY AND STATE CODES AND ORDINANCES TO PROTECT EMBANKMENTS FROM SOIL LOSS AND TO PREVENT ACCUMULATION OF SOIL AND SILT IN STREAMS AND DRAINAGE PATHS LEAVING THE CONSTRUCTION AREA. THIS MAY INCLUDE, BUT IS NOT LIMITED TO SUCH MEASURES AS SILT FENCES, STRAW BALE SEDIMENT BARRIERS, AND CHECK DAMS.
- RIP RAP OF SIZES INDICATED SHALL CONSIST OF CLEAN, HARD, SOUND, DURABLE, UNIFORM IN QUALITY STONE FREE OF ANY DETRIMENTAL QUANTITY OF SOFT, FRIABLE, THIN, ELONGATED OR LAMINATED PIECES, DISINTEGRATED MATERIAL, ORGANIC MATTER, OIL, ALKALI, OR OTHER DELETERIOUS SUBSTANCES.

11. GC TO PLACE FILTER MATERIAL AT ALL CATCH BASINS ADJACENT TO CONSTRUCTION SITE TO PREVENT SOLID WASTE CONTAMINATION FROM ENTERING SEWER SYSTEM

FOUNDATION, EXCAVATION AND BACKFILL NOTES:

- 1. ALL FINAL GRADED SLOPES SHALL BE A MAXIMUM OF 3 HORIZONTAL TO 1 VERTICAL, UNLESS OTHERWISE NOTED.
- BACKFILL OF THE POLES SHALL BE PERFORMED BASED ON THE WATER TABLE, FLOWABLE FILL MIXTURES PURCHASED FROM CONCRETE PLANTS WILL BE USED INSTEAD OF FOAM IN WATER TABLE AREAS.
 - A: NORMAL SOILS ORDER OF PREFERENCE FOAM, FLOWABLE FILL, CONCRETE, COMPACTED AGGREGATES
 - B: HIGH WATER TABLE SOILS ORDER OF PREFERENCES FLOWABLE FILL, CONCRETE, COMPACTED AGGREGATES.
- 3. ALL EXCAVATIONS PREPARED FOR PLACEMENT OF CONCRETE SHALL BE OF UNDISTURBED SOILS, SUBSTANTIALLY HORIZONTAL AND FREE FROM ANY LOOSE. UNSUITABLE MATERIAL OR FROZEN SOILS, AND WITHOUT THE PRESENCE OF POUNDING WATER. DEWATERING FOR EXCESS GROUND WATER SHALL BE PROVIDED WHEN REQUIRED. COMPACTION OF SOILS UNDER CONCRETE PAD FOUNDATIONS SHALL NOT BE LESS THAN 95% OF THE MODIFIED PROCTOR MAXIMUM DRY DENSITY FOR THE SOIL IN ACCORDANCE WITH ASTM D1557.
- 4. CONCRETE FOUNDATIONS SHALL NOT BE PLACED ON ORGANIC OR UNSUITABLE MATERIAL. IF ADEQUATE BEARING CAPACITY IS NOT ACHIEVED AT THE DESIGNED EXCAVATION DEPTH, THE UNSATISFACTORY SOIL SHALL BE EXCAVATED TO ITS FULL DEPTH AND EITHER BE REPLACED WITH MECHANICALLY COMPACTED GRANULAR MATERIAL OR THE EXCAVATION SHALL BE FILLED WITH CONCRETE OF THE SAME TYPE SPECIFIED FOR THE FOUNDATION. CRUSHED LIME STONE #57 MAY BE USED TO STABILIZE THE BOTTOM OF THE EXCAVATION. ANY STONE SUB BASE MATERIAL, IF USED, SHALL NOT SUBSTITUTE FOR REQUIRED THICKNESS OF CONCRETE.
- 5. ALL EXCAVATIONS SHALL BE CLEAN OF UNSUITABLE MATERIAL SUCH AS VEGETATION, TRASH, DEBRIS, AND SO FORTH PRIOR TO BACK FILLING, BACK FILL SHALL CONSIST OF APPROVED MATERIALS SUCH AS EARTH, LOAM, SANDY CLAY, SAND AND GRAVEL, OR SOFT SHALE, FREE FROM CLODS OR LARGE STONES OVER 2 1/2" MAX DIMENSIONS. ALL BACK FILL SHALL BE PLACED IN
- 6. ALL FILL MATERIALS AND FOUNDATION BACK FILL SHALL BE PLACED IN MAXIMUM 6" THICK LIFTS BEFORE COMPACTION, EACH LIFT SHALL BE WETTED IF REQUIRED AND COMPACTED TO NOT LESS THAN 95% OF THE MODIFIED PROCTOR MAXIMUM DRY DENSITY FOR SOIL IN ACCORDANCE WITH ASTM D1557.
- 7. NEWLY PLACED CONCRETE FOUNDATIONS SHALL CURE A MINIMUM OF 72 HRS PRIOR TO BACK FILLING.
- 8. FINISHED GRADING SHALL BE SLOPED TO PROVIDE POSITIVE DRAINAGE AND PREVENT STANDING WATER. THE FINAL (FINISH) ELEVATION OF SLAB FOUNDATIONS SHALL SLOPE AWAY IN ALL DIRECTIONS FROM THE CENTER. FINISH GRADE OF CONCRETE PADS SHALL BE A MAXIMUM OF 4 INCHES ABOVE FINAL FINISH GRADE ELEVATIONS. PROVIDE SURFACE FILL GRAVEL TO ESTABLISH SPECIFIED ELEVATIONS WHERE REQUIRED.
- 9. NEWLY GRADED GRAVEL SURFACE AREAS TO RECEIVE GRAVEL SHALL BE COVERED WITH GEOTEXTILE FABRIC TYPE: TYPAR+3401 AS MANUFACTURED BY TYPAR GEOSYNTHETICS OR AN APPROVED EQUIVALENT, SHOWN ON PLANS. THE GEOTEXTILE FABRIC SHALL BE BLACK IN COLOR TO CONTROL THE RECURRENCE OF VEGETATIVE GROWTH AND EXTEND TO WITHIN 1 FOOT OUTSIDE THE SITE FENCING OR ELECTRICAL GROUNDING SYSTEM PERIMETER WHICH EVER IS GREATER. ALL FABRIC SHALL BE COVERED WITH A MINIMUM OF 4" DEEP COMPACTED STONE OR GRAVEL AS SPECIFIED, I.E. FDOT TYPE NO. 57 FOR FENCED COMPOUND, FDOT TYPE NO. 67 FOR ACCESS DRIVE AREA, UNLESS OTHERWISE NOTED:
- 10. IN ALL AREAS TO RECEIVE FILL: REMOVE ALL VEGETATION, TOPSOIL, DEBRIS, WET AND UNSATISFACTORY SOIL MATERIALS, OBSTRUCTIONS, AND DELETERIOUS MATERIALS FROM GROUND SURFACE. PLOW STRIP OR BREAK UP SLOPED SURFACES STEEPER THAN 1 VERTICAL TO 4 HORIZONTAL SUCH THAT FILL MATERIAL WILL BIND WITH (E)/PREPARED SOIL SURFACE.
- 11. WHEN SUB GRADE OR PREPARED GROUND SURFACE HAS A DENSITY LESS THAN THAT REQUIRED FOR THE FILL MATERIAL, SCARIFY THE GROUND SURFACE TO DEPTH REQUIRED, PULVERIZE, MOISTURE-CONDITION AND/OR AERATE THE SOILS AND RECOMPACT TO THE REQUIRED DENSITY PRIOR TO PLACEMENT OF FILLS.

- 12. IN AREAS WHICH (E) GRAVEL SURFACING IS REMOVED OR DISTURBED DURING CONSTRUCTION OPERATIONS, REPLACE GRAVEL SURFACING TO MATCH ADJACENT GRAVEL SURFACING AND RESTORED TO THE SAME THICKNESS AND COMPACTION AS SPECIFIED. ALL RESTORED GRAVEL SURFACING SHALL BE FREE FROM CORRUGATIONS AND WAVES
- 13. (E) GRAVEL SURFACING MAY NOT BE REUSED.
- 14. GRAVEL SUB SURFACE SHALL BE PREPARED TO REQUIRED COMPACTION AND SUB GRADE ELEVATIONS BEFORE GRAVEL SURFACING IS PLACED AND/OR RESTORED. ANY LOOSE OR DISTURBED MATERIALS SHALL BE THOROUGHLY COMPACTED AND ANY DEPRESSIONS IN THE SUB GRADE SHALL BE FILLED AND COMPACTED WITH APPROVED SELECTED MATERIAL GRAVEL SURFACING MATERIAL SHALL NOT BE USED FOR FILLING DEPRESSIONS IN THE SUB GRADE.
- 15. PROTECT (E) GRAVEL SURFACING AND SUB GRADE IN AREAS WHERE EQUIPMENT LOADS WILL OPERATE. USE PLANKING 'MATTS' OR OTHER SUITABLE PROTECTION DESIGNED TO SPREAD EQUIPMENT LOADS AS MAY BE NECESSARY, REPAIR ANY DAMAGE TO (E) GRAVEL SURFACING OR SUB GRADE WHERE SUCH DAMAGE IS DUE TO THE CONTRACTORS OPERATIONS.
- 16. DAMAGE TO (E) STRUCTURES AND/OR UTILITIES RESULTING FROM CONTRACTORS NEGLIGENCE SHALL BE REPAIRED AND/ OR REPLACED TO THE OWNERS SATISFACTION AT NO ADDITIONAL COST TO THE CONTRACT.
- 17. ALL SUITABLE BORROW MATERIAL FOR BACK FILL OF THE SITE SHALL BE INCLUDED IN THE BID. EXCESS TOPSOIL AND UNSUITABLE MATERIAL SHALL BE DISPOSED OF OFF SITE AT LOCATIONS APPROVED BY GOVERNING AGENCIES AT NO ADDITIONAL COST TO THE CONTRACT.

PEDESTAL (IF REQUIRED) GENERAL CONDITION NOTES:

THE POWER COMPANY WILL BE RESPONSIBLE FOR:

- (A) SPECIFYING THE METER PEDESTAL LOCATION, NOTE: THE NATIONAL ELECTRICAL CODE (NEC) RECOMMENDS THAT THE SERVICE EQUIPMENT BE "IN SIGHT FROM" AND WITHIN 30'-0" OF THE MOBILE HOME.
- (B) INSTALLING AND REMOVING THE METER.
- (C) PROVIDING AND INSTALLING THE UNDERGROUND SERVICE LATERAL CONDUCTORS.

THE CUSTOMER WILL BE RESPONSIBLE FOR

- (A) PROVIDING AND INSTALLING THE METER PEDESTAL.
- (B) PROVIDING AND INSTALLING THE METER BASE.
- (C) PROVIDING AN ADEQUATE GROUND TO THE SERVICE EQUIPMENT DISCONNECT DEVICE GROUND IN ACCORDANCE WITH ARTICLE 250 OF THE NATIONAL ELECTRICAL CODE (NEC).
- (D) SECURELY INSTALLING THE METER PEDESTAL AS SHOWN.
- (E) SECURELY MOUNTING THE METER BASE IN A LEVEL AND PLUMB POSITION. METER MUST FACE THE STREET OR ACCESS WALKWAY.
- (F) PROVIDING AND INSTALLING THE SERVICE EQUIPMENT DISCONNECT DEVICE.
- (G) PROVIDING SERVICE ENTRANCE CONDUCTORS OF SUFFICIENT AMPACITY TO SERVE THE CONNECTED LOAD ACCORDING TO THE CURRENT NEC.

PEDESTAL GENERAL CONSTRUCTION NOTES:

- THIS INSTALLATION IS ALSO FOR MOBILE HOMES IN PARKS.
- 2. CUSTOMER IS TO SIZE GROUND WIRE ACCORDING TO NEC REQUIREMENTS.
- BURIAL DEPTH IS THE DISTANCE BETWEEN FINAL GRADE AND THE TOP OF THE BURIED CABLE OR CONDUIT. THE POWER COMPANY SHALL SPECIFY THE REQUIRED BURIAL DEPTH TO CONFORM TO LOCAL REQUIREMENTS. THE BURIAL DEPTH SHALL NOT BE LESS THAN 2'-6". ARKANSAS, OKLAHOMA, LOUISIANA, AND TEXAS SHALL NOT BE LESS THAN 3. IF ADDITIONAL CONDUIT IS REQUIRED TO CLEAR OBSTRUCTIONS, REFER TO POWER COMPANY FOR APPROVED USAGE.
- 4. BURIAL DEPTH TO COMPLY WITH LOCAL CODES. 2'-0" MIN. IS CONSIDERED ADEQUATE BY ARTICLE 330-5 OF THE NEC. A GROUNDING AS WELL AS A GROUNDED CONDUCTOR MUST EXTEND BETWEEN THE MOBILE HOME AND ITS ADJACENT SERVICE EQUIPMENT. NEITHER THE FRAME OF THE MOBILE HOME NOR THE FRAME OF ANY DISTRIBUTION PANEL OR APPLIANCE MAY BE CONNECTED TO THE NEUTRAL (GROUNDED) CONDUCTOR IN THE MOBILE HOME. THE GROUNDING AND GROUNDED CONDUCTORS ARE BONDED TOGETHER ONLY ON THE SUPPLY SIDE OF THE SERVICE DISCONNECT DEVICE. REFER TO ARTICLE 550 OF THE NEC - GROUNDING



JACOBS

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IT IS A VIOLATION OF THE LAW FOR ANY PERSON, UNLESS THEY ARE ACTING UNDER TO DIRECTION OF A USCENSED PROFESSIONAL ENGINEER, TO ALTER THIS DOCUMENT THE OF TELL MEGAN L. CROW

MC2 ENGINEERING AND CONSTRUCTION, P.C. HAS NOT PERFORMED A STRUCTURAL EVALUATION OR FOUNDATION DESIGN OF THIS PROJECT.

CALONAL ENT

CENSED MEST 107989

MRSTX049968 18627-050 222 PIKE STREET SOUTH PADRE ISLAND, TX 78597 **UTILITY POLE**

SHEET TITLE

GENERAL NOTES

SHEET NUMBER